### **INDEX** COVER SHEET GENERAL NOTES SUMMARY OF QUANTITIES TYPICAL SECTIONS SUPER ELEVATION TRANSITION DETAILS SCHEDULE OF QUANTITIES ALIGNMENT AND BENCHMARKS REMOVAL PLAN RESURFACING PLAN 10 ROADWAY PLAN AND PROFILES 11 SUGGESTED MAINTENANCE OF TRAFFIC PLANS AND DETAILS 15 DRAINAGE AND UTILITY PLAN 16 EROSION CONTROL PLAN

PAVEMENT MARKING AND SIGNING PLANS

STANDARD SYMBOLS, ABBREVIATIONS AND PATTERNS

MISCELLANEOUS DETAILS

CROSS SECTIONS


# **BRISTOL ROAD DISTRICT KENDALL COUNTY**


### SECTION ILLINOIS CONTRACT NO

# PROPOSED PLANS FOR ROADWAY RECONSTRUCTION

**ROUTE 3791 CANNONBALL TRAIL** SECTION 20-02118-00-SP

# **CANNONBALL TRAIL RECONSTRUCTION FROM** ALICE AVE TO PATRICIA LN

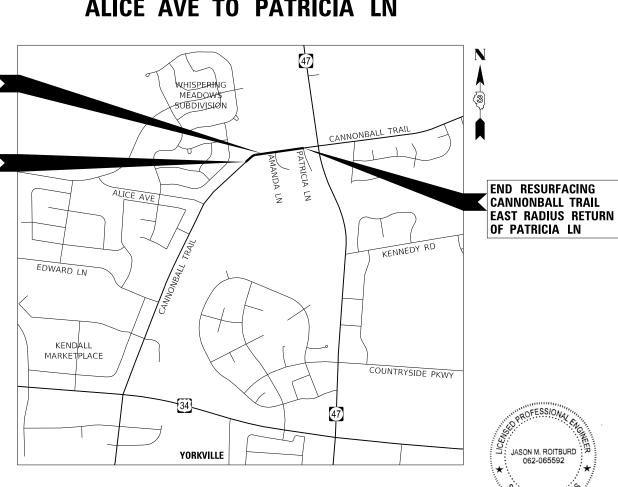

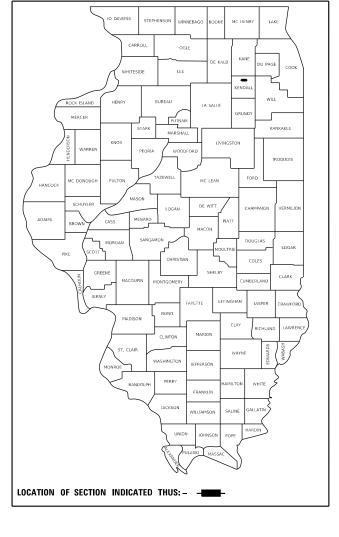

### LIST OF HIGHWAY STANDARDS

280001-07 TEMPORARY EROSION CONTROL SYSTEMS 542411 SLOPED METAL ENDSECTIONS FOR PIPE CULVERTS 15" THRU 60" DIA 667101-02 PERMANENT SURVEY MARKERS 701001-02 OFF-RD OPERATIONS 2L, 2W, MORE THAN 15' AWAY OFF-ROAD OPERATIONS, 2L, 2W, 15' TO 24" FROM PAVEMENT EDGE 701006-05 701011-04 OFF-RD MOVING OPERATIONS 2L, 2W, DAY ONLY, FOR SPEEDS ≥ 45 MPH 701301-04 LANE CLOSURE, 2L, 2W, SHORT TIME OPERATIONS

**END RECONSTRUCTION** 

**BEGIN RESURFACING** 

**BEGIN RECONSTRUCTION** CANNONBALL TRAIL

**CANNONBALL TRAIL** 

STA 107 + 85.00

STA 101 + 00.00

LANE CLOSURE, 2L, 2W, SLOW MOVING OPERATIONS DAY ONLY, FOR SPEEDS ≥ 45 MPH 701306-04

701311-03 LANE CLOSURE 2L, 2W MOVING OPERATIONS-DAY ONLY

701901-08 TRAFFIC CONTROL DEVICES 720001-01 SIGN PANEL MOUNTING DETAILS SIGN PANEL ERECTION DETAILS 720006-04 780001-05 TYPICAL PAVEMENT MARKINGS

TYPICAL APPLICATIONS RAISED REFLECTIVE PAVEMENT MARKERS 781001-04

TRAFFIC DATA

17

18 21

26

**DESIGN DESIGNATIONS:** 

**CANNONBALL TRAIL** = MAJOR COLLECTOR

ADT:

CANNONBALL TRAIL = 11,000 (2040)


DESIGN SPEED:

CANNONBALL TRAIL = 45 MPH

POSTED SPEED:

CANNONBALL TRAIL = 45 MPH

JOINT UTILITY LOCATING INFORMATION FOR EXCAVATION 1-800-892-0123 OR 811

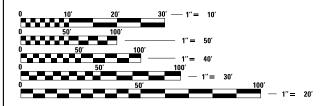

FULL SIZE PLANS HAVE BEEN PREPARED USING STANDARD ENGINEERING SCALES. REDUCED SIZED PLANS WILL NOT CONFORM TO STANDARD SCALES. IN MAKING MEASUREMENTS ON REDUCED PLANS, THE ABOVE SCALES MAY BE USED.

PROJECT GROSS AND NET LENGTHS: CANNONBALL TRAIL RECONSTRUCTION = 685 FEET (0.13 MILES) CANNONBALL TRAIL RESURFACING = 800 FEET (0.15 MILES) TOTAL = 1485 FEET (0.28 MILES)

JASON M. ROITBURD, P.E. NO. 062-065592 EXPIRES: 11/30/2023

HR GREEN, INC.



2363 SEQUOIA DRIVE, SUITE 101 | AURORA, ILLINOIS 60506 Phone: 630.553.7560 | Toll Free: 800.728.7805 | Fax: 630.553.7646 | HRGreen.cor ILLINOIS PROFESSIONAL DESIGN FIRM #184-001322

### GENERAL NOTES

### PAVING

THE THICKNESS OF HMA MIXTURES SHOWN ON THE PLANS IS THE NOMINAL THICKNESS. DEVIATIONS FROM THE NOMINAL THICKNESS WILL BE PERMITTED WHEN SUCH DEVIATIONS OCCCUR DUE TO IRREGULARITIES IN THE EXISTING SURFACE OR BASE ON WHICH THE HMA MIXTURE IS PLACED.

THE HMA SURFACE OF ALL MAILBOX TURNOUTS, PRIVATE ENTRANCES, COMMERCIAL ENTRANCES, AND SIDE ROADS SHALL BE MADE NEATLY, IN A WORKMANLIKE MANNER, AND SHALL ACCURATELY CONFORM TO THE SHAPES AND DIMENSIONS SHOWN ON THE PLAN DETAILS. IF REQUIRED BY THE ENGINEER, THE CONTRACTOR SHALL BE REQUIRED TO SAW CUT THE HMA SURFACE TO CONFORM TO THE SHAPES AND DIMENSIONS SHOWN ON THE PLAN DETAILS. THIS WORK SHALL BE INCLUDED IN THE COST OF THE HMA SURFACE

THE ENGINEER WILL BE THE SOLE JUDGE CONCERNING CURING TIME FOR THE VARIOUS HMA LIFTS

### SEWER AND WATER MAIN

THE CONTRACTOR SHALL ENSURE THAT POSITIVE DRAINAGE IS MAINTAINED AT ALL TIMES DURING AND AFTER THE CONSTRUCTION. THIS WORK SHALL BE CONSIDERED AS INCLUDED IN THE CONTRACT UNIT PRICE OF THE APPLICABLE DRAINAGE ITEMS.

WHEN EXISTING DRAINAGE FACILITIES ARE DISTURBED, THE CONTRACTOR SHALL PROVIDE AND MAINTAIN TEMPORARY OUTLETS AND CONNECTIONS FOR ALL PRIVATE OR PUBLIC DRAINS, SEWERS, OR CATCH BASINS. CONTRACTOR SHALL PROVIDE FACILITIES TO TAKE IN ALL STORM WATER WHICH WILL BE RECEIVED BY THESE DRAINS AND SEWERS AND DISCHARGE SAME. CONTRACTOR SHALL PROVIDE AND MAINTAIN AN EFFICIENT PUMPING PLANT, IF NECESSARY, AND A TEMPORARY OUTLET SHALL BE PREPARED AT ALL TIMES TO DISPOSE OF THE WATER RECEIVED FROM THESE TEMPORARY CONNECTIONS UNTIL SUCH TIME AS THE PERMANENT ROADSIDE DRAINAGE SYSTEM IS BUILT AND IN SERVICE. THIS WORK WILL NOT BE PAID FOR SEPARATELY, BUT SHALL BE CONSIDERED AS INCLUDED IN THE UNIT BID PRICES OF THE CONTRACT.

ANY LOOSE MATERIAL DEPOSITED IN THE FLOWLINE OF DRAINAGE STRUCTURES, WHICH OBSTRUCTS THE NATURAL FLOW OF WATER SHALL BE REMOVED AT THE CLOSE OF EACH WORKING DAY. PRIOR TO ACCEPTANCE OF THE IMPROVEMENT, ALL DRAINAGE STRUCTURES SHALL BE FREE OF DIRT AND DEBRIS. THIS WORK WILL NOT BE PAID FOR SEPARATELY, BUT SHALL BE CONSIDERED AS INCLUDED IN THE UNIT BID PRICES OF THE CONTRACT.

### STAKING

THE CONTRACTOR SHALL PROTECT AND CAREFULLY PRESERVE ALL SECTION OR SUBSECTION MONUMENTS, PROPERTY CORNERS, AND REFERENCE MARKERS UNTIL THE OWNER, HIS AGENT, OR AN AUTHORIZED SURVEYOR HAS WITNESSED OR OTHERWISE REFERENCED THEIR LOCATIONS.

EXCEPT AS NOTED ON THE PLANS, PAVEMENT GRADES SHOWN ARE AT THE TOP OF PAVEMENT SURFACES.

OFFSET LOCATIONS GIVEN IN THE PLANS FOR STRUCTURES, EDGE OF PAVEMENT, ETC. ARE FROM THE ROADWAY CENTERLINE.

ALL ELEVATIONS ARE ON NAVD 88 DATUM.

### MISCELLANEOUS

IT IS THE CONTRACTOR'S RESPONSIBILITY TO ASCERTAIN EXISTING FIELD CONDITIONS BEFORE BIDDING ON THE CONTRACT.

WHERE NEW WORK MEETS EXISTING FEATURES TO REMAIN, THE CONTRACTOR SHALL FIELD CHECK ALL DIMENSIONS AND ELEVATIONS PRIOR TO PROCEEDING WITH CONSTRUCTION AND NOTIFY THE ENGINEER IMMEDIATELY OF ANY DISCREPANCIES.

SEEDING WILL NOT BE PERMITTED AT ANY TIME WHEN THE GROUND IS FROZEN, WET, OR IN AN UNTILLABLE CONDITION. LOCATIONS TO BE SEEDED WILL BE DETERMINED BY THE FNGINFER.

ANY REFERENCE TO A STANDARD THROUGHOUT THE PLANS OR SPECIAL PROVISIONS SHALL BE INTERPRETED TO MEAN THE EDITION AS INDICATED BY THE SUBNUMBER SHOWN IN THE LIST OF STANDARDS INCLUDED IN THESE PLANS.

THE REMOVAL OF AGGREGATE SHOULDERS AND ENTRANCES WILL NOT BE PAID FOR SEPARATELY, BUT SHALL BE INCLUDED IN THE CONTRACT UNIT BID PRICE FOR EARTH EXCAVATION.

SAW CUTTING WILL BE REQUIRED FOR ALL REMOVAL ITEMS LISTED IN SECTION 440 OF THE STANDARD SPECIFICATIONS, SHOWN IN THE PLANS, AND AS DIRECTED BY THE ENGINEER. THE COST OF SAW CUTTING WILL BE INCLUDED IN CONTRACT UNIT BID PRICES FOR THE ITEMS BEING REMOVED.

ADDITIONAL PAVEMENT REMOVAL WILL BE REQUIRED IN AREAS WHERE THE PROPOSED PAVEMENT WIDENING IS LESS THAN 2' IN ORDER TO OBTAIN THE REQUIRED COMPACTION WITHIN THE PROPOSED WIDENING AREA, ADEQUATE QUANTITIES HAVE BEEN PROVIDED.

THE CONTRACTOR WILL BE REQUIRED TO COMPLY WITH ALL STATE REGULATIONS REGARDING AIR, WATER, AND NOISE POLLUTION. THE CONTRACTOR IS PROHIBITED FROM BURNING ANY MATERIAL WITHIN OR ADJACENT TO THE IMPROVEMENT.

THE PRESERVATION OF EXISTING TREES IS OF THE UTMOST IMPORTANCE. TREE REMOVAL PAY ITEMS AND QUANTITIES HAVE BEEN PROVIDED FOR TREES THAT MAY BE IN CONFLICT WITH CONSTRUCTION. ANY TREE REMOVAL ALONG WITH ALL TREE PROTECTION, PRUNING AND ROOT PRUNING SHALL BE COMPLETED BEFORE CONSTRUCTION OPERATIONS COMMENCE IN ANY AREA. AT NO TIME SHALL THE CONTRACTOR PRUNING OR REMOVE ANY TREES UNLESS SPECIFICALLY DIRECTED BY THE ENGINEER. PRUNING WILL NOT BE PAID FOR SEPARATELY, BUT SHALL BE CONSIDERED AS INCLUDED IN THE UNIT BID PRICES OF THE CONTRACT, AND NO ADDITIONAL COMPENSATION WILL BE ALLOWED.

THE CONTRACTOR SHALL ERECT A TREE PROTECTION AROUND ALL TREES WITHIN THE CONSTRUCTION AREA TO ESTABLISH A "TREE PROTECTION ZONE" TO THE SATISFACTION OF THE ENGINEER BEFORE ANY WORK BEGINS OR ANY MATERIAL IS DELIVERED TO THE JOB SITE. NO WORK IS TO BE PERFORMED (OTHER THAN PRUNING), MATERIALS STORED OR VEHICLES DRIVEN OR PARKED WITHIN THE "TREE PROTECTION ZONE". TREE PROTECTION SHALL BE REMOVED ONLY AFTER ALL CONSTRUCTION WORK HAS BEEN COMPLETED. TREE PROTECTION WILL NOT BE PAID FOR SEPARATELY, BUT SHALL BE CONSIDERED AS INCLUDED IN THE UNIT BID PRICES OF THE CONTRACT, AND NO ADDITIONAL COMPENSATION WILL BE ALLOWED.

THE SUBGRADE SHALL BE KEPT DRAINED DURING CONSTRUCTION OF THE PAVEMENT STRUCTURE. THE CONTRACTOR SHALL FACILITATE SUBFACE DRAINAGE BY CUTTING WEEPS IN THE SUBGRADE OR ADJACENT TERRAIN AS NECESSARY. THIS WORK SHALL BE CONSIDERED AS INCLUDED IN THE UNIT BID PRICES OF THE CONTRACT AND NO ADDITIONAL COMPENSATION WILL BE ALLOWED.

THE FOLLOWING RATES OF APPLICATION HAVE BEEN USED IN CALCULATING PLAN OUANTITIES:

GRANULAR MATERIALS	2.05	TONS / CU YD
BITUMINOUS MAT (PRIME COAT)	0.05	LBS / SQ FT (MILLED HMA/AGED HMA)
	0.025	LBS / SQ FT (HMA LIFTS)
	0.25	LBS / SQ FT (AGGREGATE)
HMA RESURFACING	112	LBS / SQ YD / IN
SHORT TERM PAVEMENT MARKING	10	FT / 100 FT OF APPLICATION

### UTILITIES

THE CONTRACTOR SHALL BE RESPONSIBLE FOR CONTACTING THE OWNERS OF ALL UTILITIES PRIOR TO CONSTRUCTION TO DETERMINE THE LOCATION OF ALL UTILITY EQUIPMENT. THE CONTRACTOR SHALL COOPERATE WITH ALL UTILITY OWNERS IN ACCORDANCE WITH THE STANDARD SPECIFICATIONS IF UTILITY RELOCATION, ADJUSTMENT, OR PROTECTION IS NECESSARY

ABANDONED UNDERGROUND UTILITIES THAT CONFLICT WITH CONSTRUCTION SHALL BE DISPOSED OF OUTSIDE THE LIMITS OF THE RIGHT OF WAY ACCORDING TO ARTICLE 202.03 OF THE STANDARD SPECIFICATIONS AND AS DIRECTED BY THE ENGINEER. THIS WORK WILL NOT BE PAID FOR SEPARATELY, BUT SHALL BE CONSIDERED AS INCLUDED IN THE COST OF EARTH EXCAVATION.

THE LOCATION OF EXISTING DRAINAGE STRUCTURES, STORM SEWERS, WATER MAINS, SANITARY SEWERS, AND ANY OTHER PUBLIC OR PRIVATE UTILITIES AS SHOWN ON THE PLANS IS APPROXIMATE AND THEIR EXACT LOCATION IS TO BE DETERMINED IN THE FIELD BY THE CONTRACTOR. THIS WORK SHALL BE CONSIDERED AS INCLUDED IN THE UNIT BID PRICES OF THE CONTRACT, AND NO ADDITIONAL COMPENSATION WILL BE ALLOWED.

THE CONTRACTOR SHALL BE RESPONSIBLE FOR THE PROTECTION OF ALL UNDERGROUND AND SURFACE UTILITIES EVEN THOUGH THEY MIGHT NOT BE SHOWN ON THE PLANS. ANY UTILITY PROPERTY DAMAGED DURING CONSTRUCTION SHALL BE REPAIRED OR REPLACED TO THE SATISFACTION OF THE OWNER AT THE CONTRACTOR'S EXPENSE.

### UTILITY CONTACTS

AT&T CARL DONAHUE 866 ROCK CREEK ROAD PLANO, IL 60545 (630) 573-6414

COMCAST

COMED

ROBERT STROLL

(630) 600-6213

PETE KRATZER

(630) 424-5704

688 INDUSTRIAL DRIVE

ELMHURST, IL 60126

1N423 SWIFT ROAD

LOMBARD, IL 60148

JMC ENGINEERS AND ASSOCIATES, INC. RICH MEYERS 201 S. CRESCENT STREET GILMAN, IL 60938 (815) 265-4056

THE UNITED CITY OF YORKVILLE ERIC DHUSE 800 GAME FARM ROAD YORKVILLE, IL. 60560 (630) 553-4350 EDHUSE@YORKVILLE.IL.US NICOR CHARLES "CHIP" PARROTT, PE 1844 FERRY ROAD NAPERVILLE, IL 60563-9600 (630) 388-3319

> METRONET LORI KEMPER 3701 COMMUNICATIONS WAY EVANSVILLE, IN 47715 (812) 213-1050

HMA MIXTURE REQUIREMENTS

TIMA MIXTORE REGOINEMENTS										
	HMA BINDER (CANNONBALL TRAIL) (TEMPORARY PAVEMENT)	HMA SURFACE (CANNONBALL TRAIL) (ENTRANCES)								
PG GRADE	PG64-22	PG64-22								
DESIGN AIR VOIDS	4.0% @ N70	4.0% @ N70								
MIXTURE COMPOSITION	IL 19.0	IL 9.5								
FRICTION AGGREGATE		MIXTURE D								
MIXTURE WEIGHT	112.0 LB/SY/IN	112.0 LB/SY/IN								
QUALITY MANAGEMENT PROGRAM	QCQA	QCQA								
SUBLOT SIZE	NA	NA								
DENSITY TEST METHOD	CORES	CORES								

MATERIAL SHALL BE COMPACTED TO 93.0 - 97.4 PERCENT OF THE MAXIMUM THEORETICAL DENSITY, EXCEPT THAT WHEN PLACED AS FIRST LIFT ON AN UNIMPROVED SUBGRADE THE MINIMUM PERCENT COMPACTION SHALL BE 92.0 PERCENT. THE MAXIMUM THEORETICAL DENSITY SHALL BE DETERMINED FROM THE MOVING AVERAGE AS SPECIFIED IN THE QA/QC SPECIFICATION.

WHEN MORE THAN 20% RAP IS USED, A SOFTER ASPHALT BINDER (PG58-22) MAY BE REQUIRED AS DETERMINED BY THE ENGINEER.

USER NAME = amiller	DESIGNED - JMR	REVISED -
	DRAWN - AJM	REVISED -
PLOT SCALE = 20.0000 ' / in.	CHECKED -	REVISED -
PLOT DATE = 3/4/2022	DATE -	REVISED -

		_						F.A. RTE	SECT	ΠΟΝ		COUNTY	TOTAL SHEETS	SHEET NO.
GENERAL NOTES							3791	20-0211	KENDALL	26	2			
												CONTRAC	CT NO.	
SHEET	1	OF	1	SHEETS	STA.	TO	STA.			ILLINOIS	FFD. All	D PROJECT		

S.P.	PAY ITEM NO.	DESIGNATION	UNIT	TOTAL
	20200100	EARTH EXCAVATION	CU YD	686
	20400800	FURNISHED EXCAVATION	CU YD	151
	21101505	TOPSOIL EXCAVATION AND PLACEMENT	CU YD	521
	25000210	SEEDING, CLASS 2A	ACRE	0.48
	25000400	NITROGEN FERTILIZER NUTRIENT	POUND	44
	25000500	PHOSPHORUS FERTILIZER NUTRIENT	POUND	44
	25000600	POTASSIUM FERTILIZER NUTRIENT	POUND	44
	25100630	EROSION CONTROL BLANKET	SQ YD	2,341
	28000305	TEMPORARY DITCH CHECKS	FOOT	45
	28000400	PERIMETER EROSION BARRIER	FOOT	1,297
	28000500	INLET AND PIPE PROTECTION	EACH	1
	30300112	AGGREGATE SUBGRADE IMPROVEMENT 12"	SQ YD	2,512
	31101600	SUBBASE GRANULAR MATERIAL, TYPE B 8.	SQ YD	1,975
	40600275	BITUMINOUS MATERIALS (PRIME COAT)	POUND	8,665
	40603085	HOT-MIX ASPHALT BINDER COURSE, IL-19.0, N70	TON	1,733
	40604062	HOT-MIX ASPHALT SURFACE COURSE, IL-9.5, MIX "D", N70	TON	496
	44000100	PAVEMENT REMOVAL	SQ YD	3,587
	44000160	HOT-MIX ASPHALT SURFACE REMOVAL, 2 3/4	SQ YD	3,095
	44000200	DRIVEWAY PAVEMENT REMOVAL	SQ YD	51
	54260415	SLOPED METAL END SECTION, STANDARD 542411, 15", 1:4	EACH	2
	542C0220	PIPE CULVERTS, CLASS C, TYPE 1 15"	FOOT	34
	66700305	PERMANENT SURVEY MARKERS, TYPE II	EACH	2
	67100100	MOBILIZATION	L SUM	1
	70300100	SHORT TERM PAVEMENT MARKING	FOOT	807
	70300150	SHORT TERM PAVEMENT MARKING REMOVAL	SQ FT	269
	70306120	TEMPORARY PAVEMENT MARKING - LINE 4" - TYPE III TAPE	FOOT	10,775
	72000100	SIGN PANEL - TYPE 1	SQ FT	33

 $<sup>\</sup>Delta$  = INDICATES SPECIALTY ITEM \* = SEE SPECIAL PROVISIONS

	S.P.	PAY ITEM NO.	DESIGNATION	UNIT	TOTAL
Δ		72800100	TELESCOPING STEEL SIGN SUPPORT	FOOT	57
Δ		73100100	BASE FOR TELESCOPING STEEL SIGN SUPPORT	EACH	4
Δ		78009000	MODIFIED URETHANE PAVEMENT MARKING - LETTERS AND SYMBOLS	SQ FT	16
Δ		78009004	MODIFIED URETHANE PAVEMENT MARKING - LINE 4"	FOOT	5,753
Δ		78009008	MODIFIED URETHANE PAVEMENT MARKING - LINE 8"	FOOT	161
Δ		78009012	MODIFIED URETHANE PAVEMENT MARKING - LINE 12"	FOOT	221
Δ		78300200	RAISED REFLECTIVE PAVEMENT MARKER REMOVAL	EACH	26
Δ		78300202	PAVEMENT MARKING REMOVAL - WATER BLASTING	SQ FT	3,592
	*	X4021000	TEMPORARY ACCESS (PRIVATE ENTRANCE)	EACH	1
	*	X4022000	TEMPORARY ACCESS (COMMERCIAL ENTRANCE)	EACH	3
	*	X7010216	TRAFFIC CONTROL AND PROTECTION, (SPECIAL)	L SUM	1
Δ	*	X7010238	CHANGEABLE MESSAGE SIGN, SPECIAL	CAL MO	6
Δ	*	X7810300	RECESSED REFLECTIVE PAVEMENT MARKER	EACH	42
	*	Z0013798	CONSTRUCTION LAYOUT	L SUM	1
	*	Z0030850	TEMPORARY INFORMATION SIGNING	SQ FT	250
	*	Z0062456	TEMPORARY PAVEMENT	SQ YD	1,513


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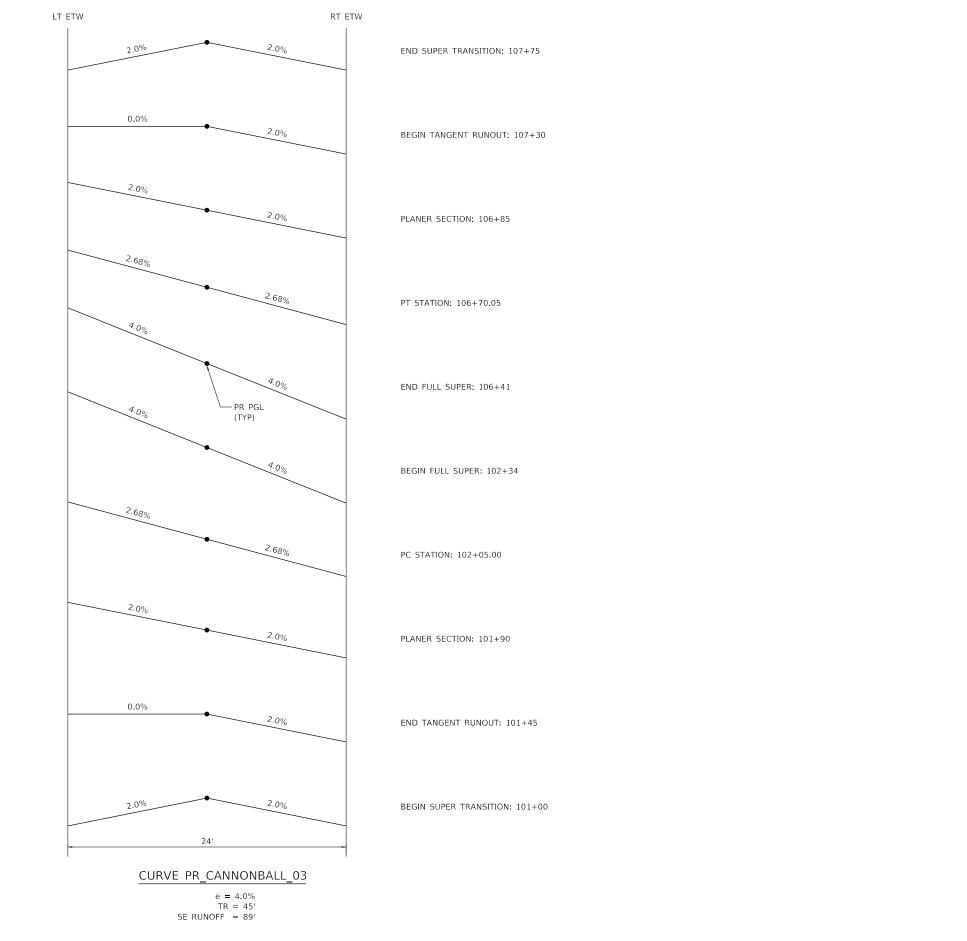
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USER NAME = amiller	DESIGNED - JMR	REVISED -
	DRAWN - AJM	REVISED -
PLOT SCALE = 40.0000 ' / in.	CHECKED -	REVISED -
PLOT DATE = 3/4/2022	DATE -	REVISED -

												F.A. SECTION					COUNTY TOTAL SHEET NO.			
	SUMMARY OF QUANTITIES								3791	3791 20-02118-00-SP			KENDALL	26	3					
														CONTRAC	ΓNO.					
	SCALE:	SHEET	1	OF	1	SHEETS	STA.	TO	0	STA.		ILLINOIS FED. AID PROJECT								





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PLOT DATE = 3/4/2022	DATE -	REVISED -

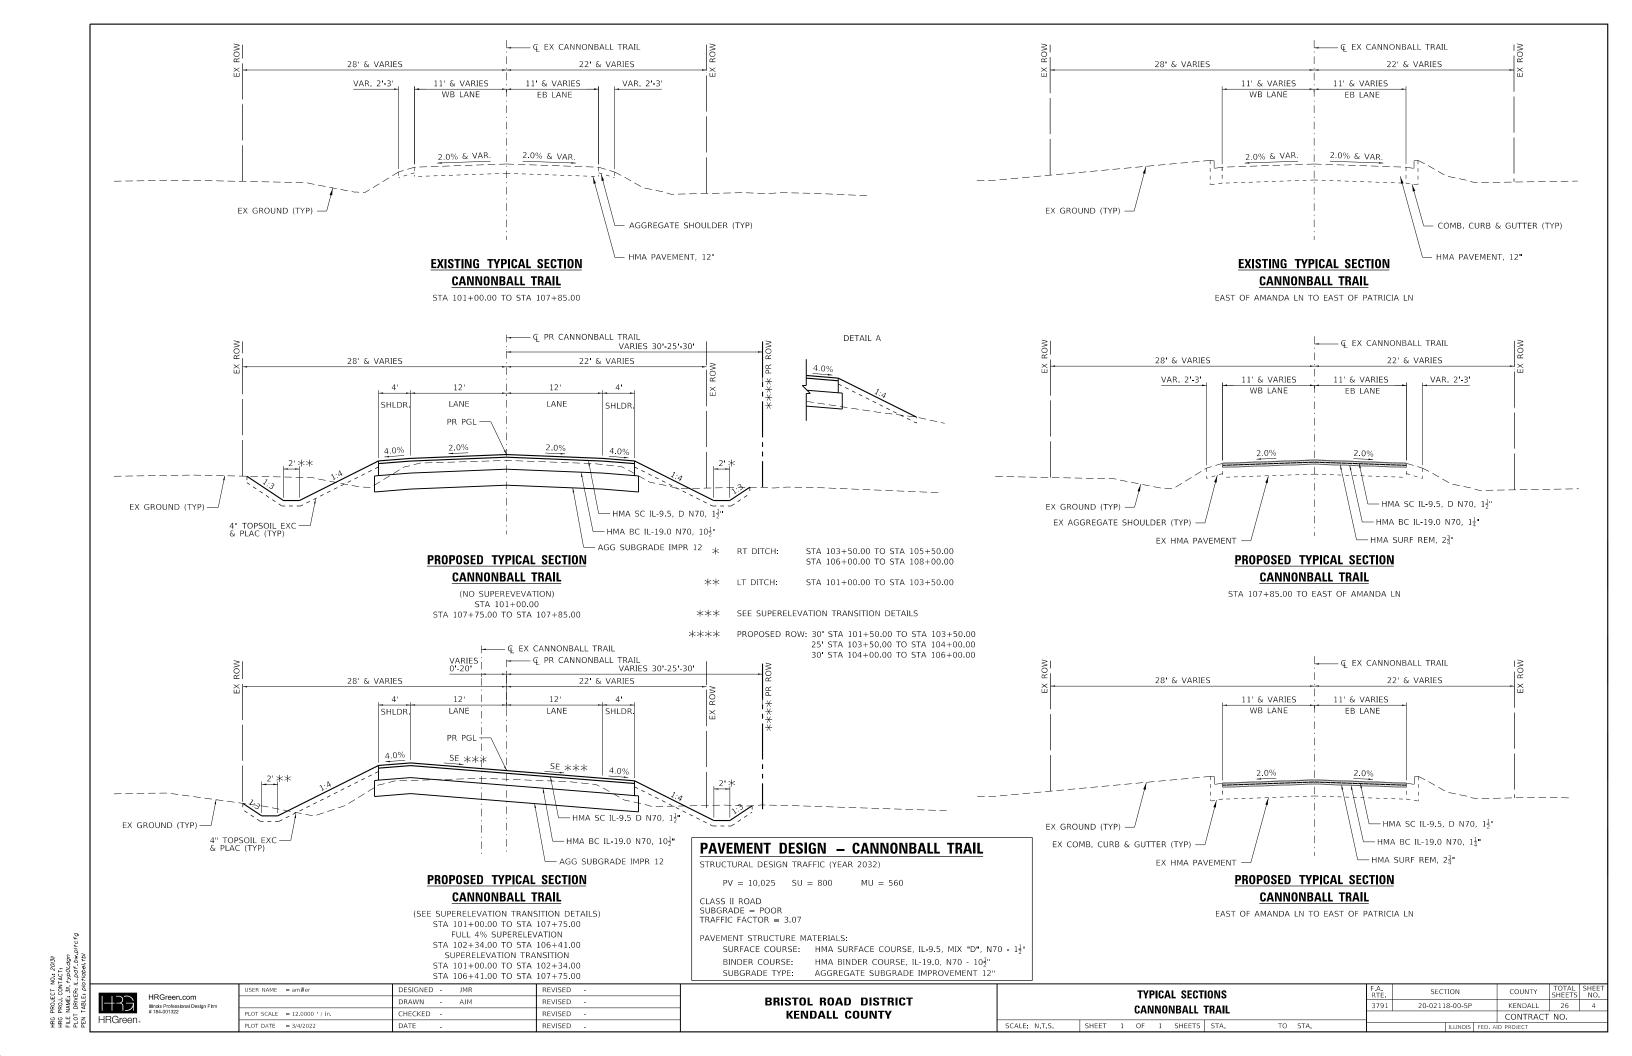BRISTOL	ROAD	DISTRICT
KEND	ALL C	OUNTY

	SUPER	RELI	EVAT	ION	TRANS	SITION	DETAILS	F.A. RTE	TION		COUNTY	TOTAL SHEETS	SHEE' NO.		
CANNONDALL TRAIL									3791	20-02118-00-SP			KENDALL	26	5
CANNONBALL TRAIL													CONTRACT	NO.	
	SHEET	1	OF	1	SHEETS	STA.	TO	STA.	ILLINOIS FED. AID I				ID PROJECT		

			PAVEMENT SO	CHEDULE							
LOCATION	AGGREGATE SUBGRADE IMPROVEMENT 12" (SQ YD)	SUBBASE GRANULAR MATERIAL TYPE B 8" (SQ YD)	BITUMINOUS MATERIALS (PRIME COAT) (POUND)	HOT-MIX ASPHALT BINDER COURSE, IL-19.0, N70 (TON)	HOT-MIX ASPHALT SURF. COURSE IL-9.5 MIX "D", N70 (TON)	PAVEMENT REMOVAL (SQ YD)	HOT-MIX ASPHALT SURFACE REMOVAL, 2 3/4" (SQ YD)	DRIVEWAY PAVEMENT REMOVAL (SQ YD)	TEMPORARY ACCESS (PRIVATE ENTRANCE)	TEMPORARY ACCESS (COMMERCIAL ENTRANCE)	TEMPORARY PAVEMENT (SQ YD)
CANNONBALL TRAIL											
C/MANONAD/ACE THANKS											
STA 101+00.00 TO STA 107+85.00	2,512		6576	1,432	205	2,074					
STA 107+85.00 TO PATRICIA LN			2089	217	260		3,095				
DRIVEWAYS											
STA 101+88.00 (PE)		75		10	7			20	1		
STA 104+00.00 (CE)		108		27	9					1	
STA 104+78.00 (CE)		98		25	8					1	
STA 107+03.00 (CE)		87		22	7			31		1	
STAGE I - MOT											
STA 99+50.00 TO STA 109+35.00		1607									1513
STAGE III - MOT											
STA 101+00.00 TO STA 102+72.00						89					
STA 106+04.00 TO STA 107+85.00						94					
STAGE III-B - MOT											
STA 99+50.00 TO STA 109+35.00						1330					
TOTALS:	2,512	1,975	8665	1733	496	3,587	3,095	51	1	3	1513

		WORK ZO	NE PAVEMENT	MARKING		SHORT-	TERM
	PAVEMENT					PAVE	4ENT
	MARKING		LINE	- 4"		MARI	KING
	REMOVAL	SOLID	SOLID	SOLID	SOLID	MEDIAN	LANE
LOCATION	WATER	EDGE LINE	EDGE LINE	LANE LINE	MEDIAN CL	LINE	LINE
	BLASTING	WHITE	WHITE	WHITE	YELLOW	YELLOW	WHITE
	(SQ FT)	(FOOT)	(FOOT)	(FOOT)	(FOOT)	(FOOT)	(FOOT)
		LEFT	RIGHT				
PRE-STAGE							
107+85.00 TO PATRICIA LN				115	1196		
STAGE I							
CANNONBALL TRAIL							
STA. 99+50.00 TO STA. 109+35.00		1031	910		930		
STAGE 2							
CANNONBALL TRAIL							
STA. 99+50.00 TO STA. 109+35.00	2871	1016	984		1021		
STAGE 3							
CANNONBALL TRAIL							
STA. 99+50.00 TO STA. 109+35.00	4539	1963	1541		68		
107+85.00 TO PATRICIA LN						200	400
						70	137
TOTAL	3592		10	775		80	17

### EARTHWORK SCHEDULE

	*TOPSOIL	*TOPSOIL	*TOPSOIL	EARTH	EARTH	*EMBANKMENT	TOPSOIL	EARTH
	EXCAVATION	EXCAVATION	PLACEMENT	EXCAVATION	EXCAVATION		BALANCE	BALANCE
LOCATION		ADJUSTED FOR			ADJUSTED FOR		SURPLUS (+) OR	SURPLUS (+) OR
		SHRINKAGE (25%)			SHRINKAGE (25%)		SHORTAGE (-)	SHORTAGE (-)
	(CU YD)	(CU YD)	(CU YD)	(CU YD)	(CU YD)	(CU YD)	(CU YD)	(CU YD)
CANNONBALL TRAIL								
100+00 TO STA 107+85	695	521	135	686	515	416	386	99
STAGE I								
TEMPORARY PAVEMENT	0	0	0	0	0	250	0	-250
TOTAL	695	521	135	686	515	666	386	-151

- NOTES:

  1. ALL MATERIAL TO BE UTILIZED AS EMBANKMENT ON THIS PROJECT SHALL CONFORM TO THE APPLICABLE SECTIONS OF THE STANDARD SPECIFICATIONS AND THE SPECIAL PROVISIONS INCLUDED IN THIS CONTRACT AT THE TIME OF CONSTRUCTION.

  2. EXCESS TOPSOIL SHALL BE UTILIZED IN THE EMBANKMENT TO REDUCE THE VOLUME OF FURNISHED EXCAVATION NEEDED, HOWEVER THE USE OF TOPSOIL IN THE EMBANKMENT SHALL BE IN ACCORDANCE WITH NOTE #1 ABOVE. THE EARTHWORK SCHEDULE HAS NOT BEEN ADJUSTED TO ACCOUNT FOR USE OF EXCESS TOPSOIL IN THE EMBANKMENT.

SHRINKAGE FACTORS
TOPSOIL & EARTH EXCAVATION

25%

PAY ITEMS				
	20200100	EARTH EXCAVATION	686	CU YD
	20400800	FURNISHED EXCAVATION	151	CU YD
	*21101505	TOPSOIL EXCAVATION AND PLACEMENT	521	CU YD

\* NOMINAL QUANTITIY INCLUDED FOR TEMPORARY PAVEMENT CONSTRUCTED IN STAGE I.

PAVEMENT MARKING SCHEDULE								
	LINE - 4"			LINE -	8"	LINE 12"	RAISED	RECESSED
LETTERS	MEDIAN LINE	EDGE	LINE	LANE L	.INE	DIAGONAL LINE	REFLECTIVE	REFLECTIVE
&	SOLID	SOI	_ID	SKIP DASH	SOLID	SOLID	PAVEMENT	PAVEMENT
SYMBOLS	YELLOW	W⊦	ITE	WHITE	WHITE	YELOW	MARKER	MARKER
		LEFT	RIGHT				REMOVAL	
(SQFT)	(FOOT)	(FOOT)	(FOOT)	(FOOT)	(FOOT)	(FOOT)	(EACH)	(EACH)
	1370	693	678				20	36
15.6	2392	329	291	46	115	221	6	6
15.6	5,	.753		46	115	221	26	42
	& SYMBOLS (SQFT)	LETTERS & MEDIAN LINE SOLID SYMBOLS YELLOW (SQFT) (FOOT)  1370 15.6 2392	MEDIAN LINE   SOLID   SOLID	LETTERS & MEDIAN LINE	LETTERS & SOLID SOLID SYMBOLS         MEDIAN LINE SOLID SOLID SOLID SKIP DASH WHITE           (SQFT)         (FOOT)         (FOOT)         (FOOT)         (FOOT)         (FOOT)         (FOOT)           1370         693         678         15.6         2392         329         291         46	LETTERS	New York   New York	Name

	EROSION	CONTROL AN	ID LANDSCAPII	NG SCHEDULES			
LOCATION	TOPSOIL EXCAVATION AND PLACEMENT	SEEDING, CLASS 2A	NITROGEN FERTILIZER NUTRIENT	PHOSPHOROUS FERTILIZER NUTRIENT	POTASSIUM FERTILIZER NUTRIENT	EROSION CONTROL BLANKET	PERIMETER EROSION BARRIER
	(CU YD)	(ACRE)	(POUND)	(POUND)	(POUND)	(SQ YD)	(FOOT)
CANNONBALL TRAIL							
STA 101+00.00 TO STA 101+76.00 (RT)	8	0.01	1	1	1	69	87
STA 101+00.00 TO STA 103+81.05 (LT)	76	0.14	13	13	13	682	314
STA 102+00.00 TO STA 107+85.00 (RT)	103	0.19	17	17	17	927	564
STA 104+18.95 TO STA 104+62.86 (LT)	13	0.02	2	2	2	117	58
STA 104+93.14 TO STA 106+73.00 (LT)	48	0.09	8	8	8	434	195
STA 107+33.00 TO STA 107+85.00 (LT)	12	0.02	2	2	2	112	79
TOTALS:	260	0.48	44	44	44	2,341	1,297

SIGNAGE SCHEDULE									
	SIGN PLACEMENT								
	STANDARD NUMBER (NEW)	SIGN PANEL	TELESCOPING	HEIGHT ABOVE	CENTERLINE				
LOCATION	DESCRIPTION (EXISTING)	TYPE 1	STEEL SIGN	EDGE OF	/ PGL				
			SUPPORT	PAVEMENT	OFFSET				
		(SQ FT)	(FOOT)						
CANNONBALL TRAIL									
STA 101+05 RT	W1-2R-3636	9.00	13.5	7.0	22.0				
STA 102+55 RT	R2-1-3036	7.50	15.0	7.0	22.0				
STA 106+20 LT	R2-1-3036	7.50	15.0	7.0	22.0				
STA 107+70 LT	W1-2R-3636	9.00	13.5	7.0	22.0				
TOTALS:		33.00	57						

NOTES: 1. ALL EXISTING SHALL BE REMOVED UNLESS OTHERWISE NOTED ON THE PLANS.

66700305 PERMANENT SURVEY MARKERS, TYPE II

EACH LOCATION
CANNONBALL TRAIL
1 STA 102+05.00
1 STA 106+70.05 SUB-TOTAL

2 TOTAL

70106800 CHANGEABLE MESSAGE SIGN, SPECIAL

CAL MO LOCATION
3 CANNONBALL TRAIL EASTBOUND
3 CANNONBALL TRAIL WESTBOUND
6 SUB-TOTAL


6 TOTAL


HRGreen.com HRGreen.

USER NAME = amiller	DESIGNED - JMR	REVISED -
	DRAWN - AJM	REVISED -
PLOT SCALE = 40.0000 ' / in.	CHECKED -	REVISED -
PLOT DATE = 3/4/2022	DATE -	REVISED -

BRISTOL	ROAD	DISTRICT
KEND	ALL C	DUNTY

							_			F.A. RTE	SEC	TION		COUNTY	TOTAL SHEETS	SHEET NO.
	SCHEDULE OF QUANTITIES							3791	1 20-02118-00-SP			KENDALL	26	6		
											CONTRACT	NO.				
SCALE:	SHEET	1	OF	1	SHEETS	STA.	T	0	STA.			ILLINOIS	FED. A	ID PROJECT		

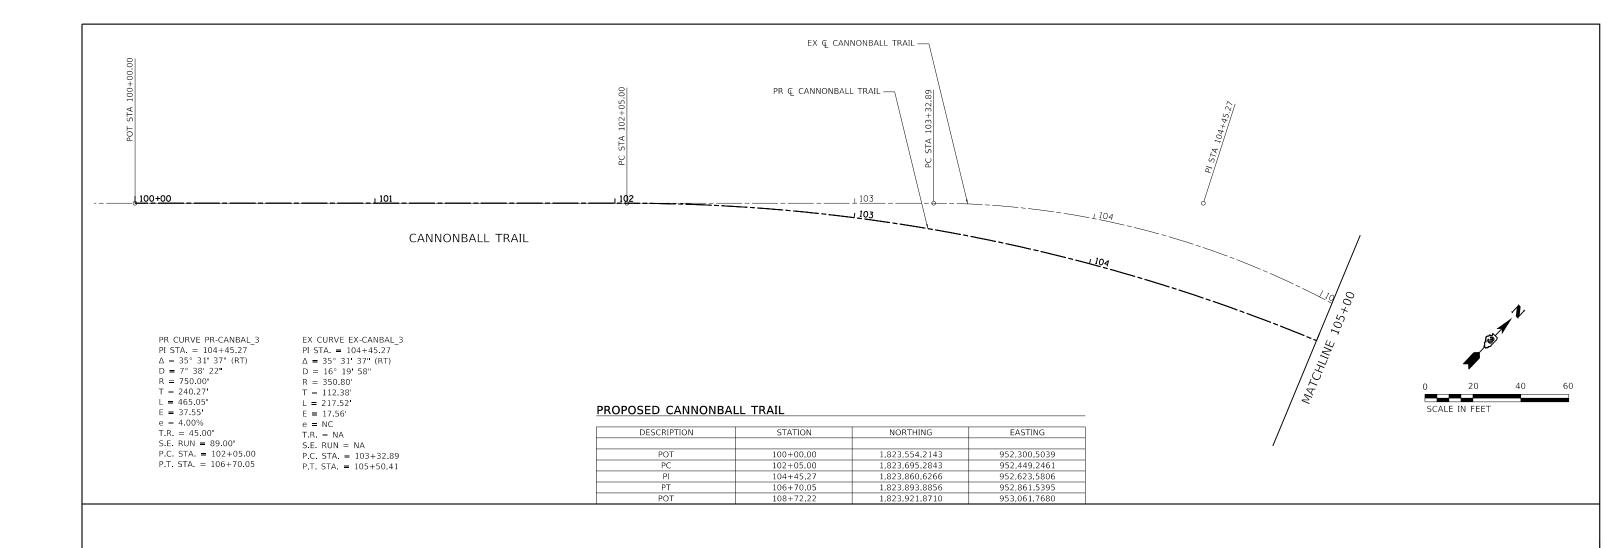

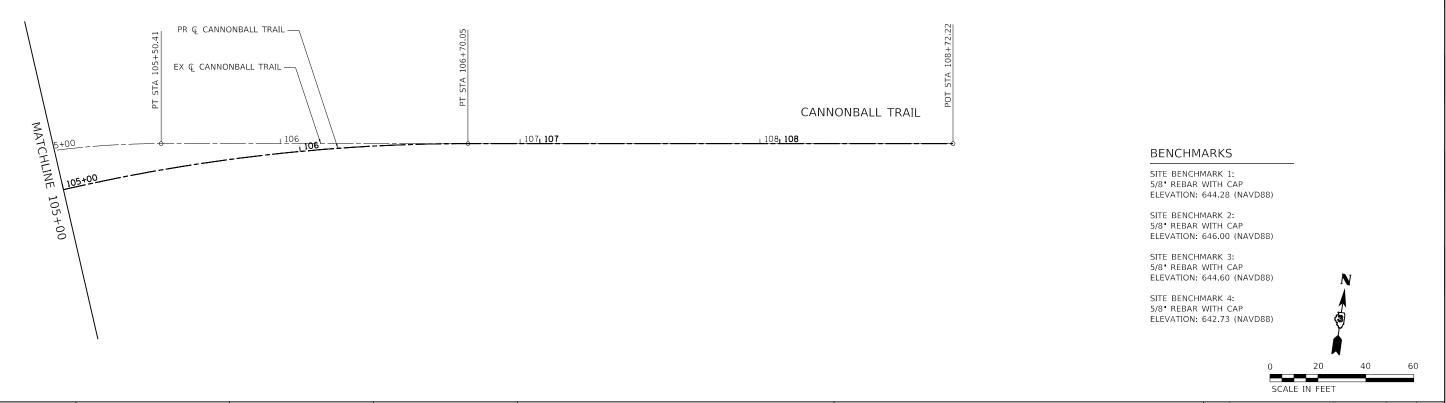

HRG PROJECT NO.: 20/3// HRG PROJ. CONTACT: FILE NAME: 3// atb0/dgm PLOT DRIVER: IL.Ddf. bw.pitcfg PEN TABLE: plotiabei.tb/

HRGreen.com
Illinois Professional Design Firm
#184-001322


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PLOT DATE = 3/4/2022	DATE -	REVISED -

BRISTOL	ROAD	DISTRICT
KEND	ALL C	OUNTY


	Α	LIGN	IME	NT .	AND BE	NCHMA	ARKS	F.A. RTE	SECTION
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SCALE: 1" = 20'	SHEET	1	OF	1	SHEETS	STA.	TO STA.		ILLINOIS

COUNTY

KENDALL 26 CONTRACT NO.

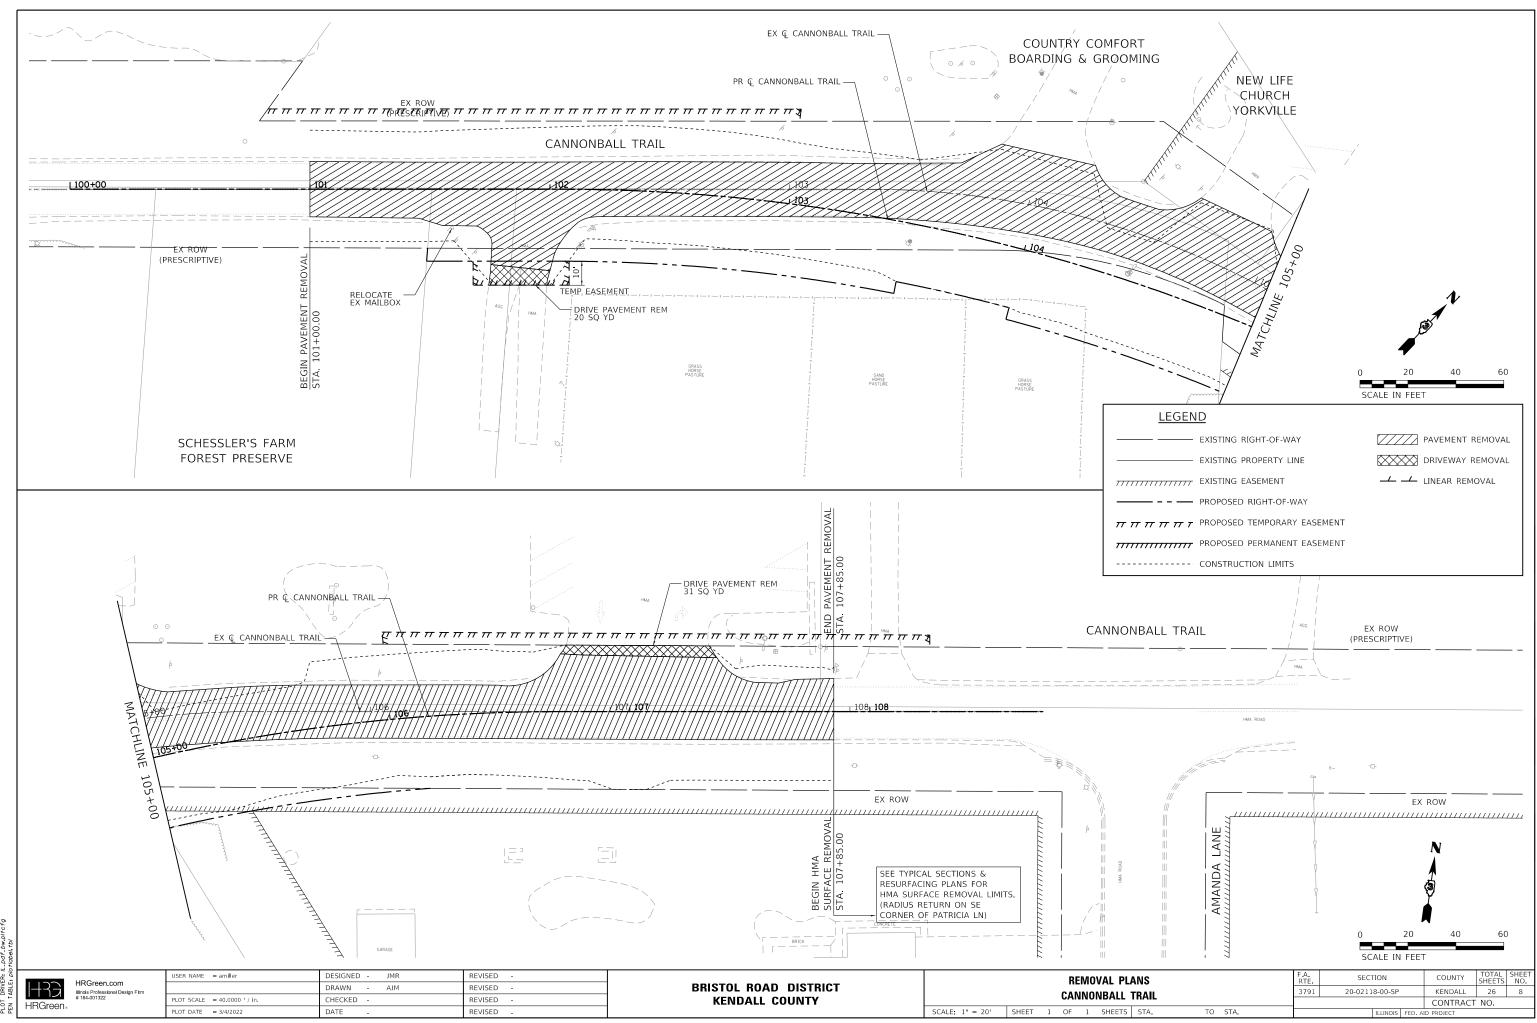

HRG PROJECT NO.: 2013//
HRG PROJ. CONTACT:
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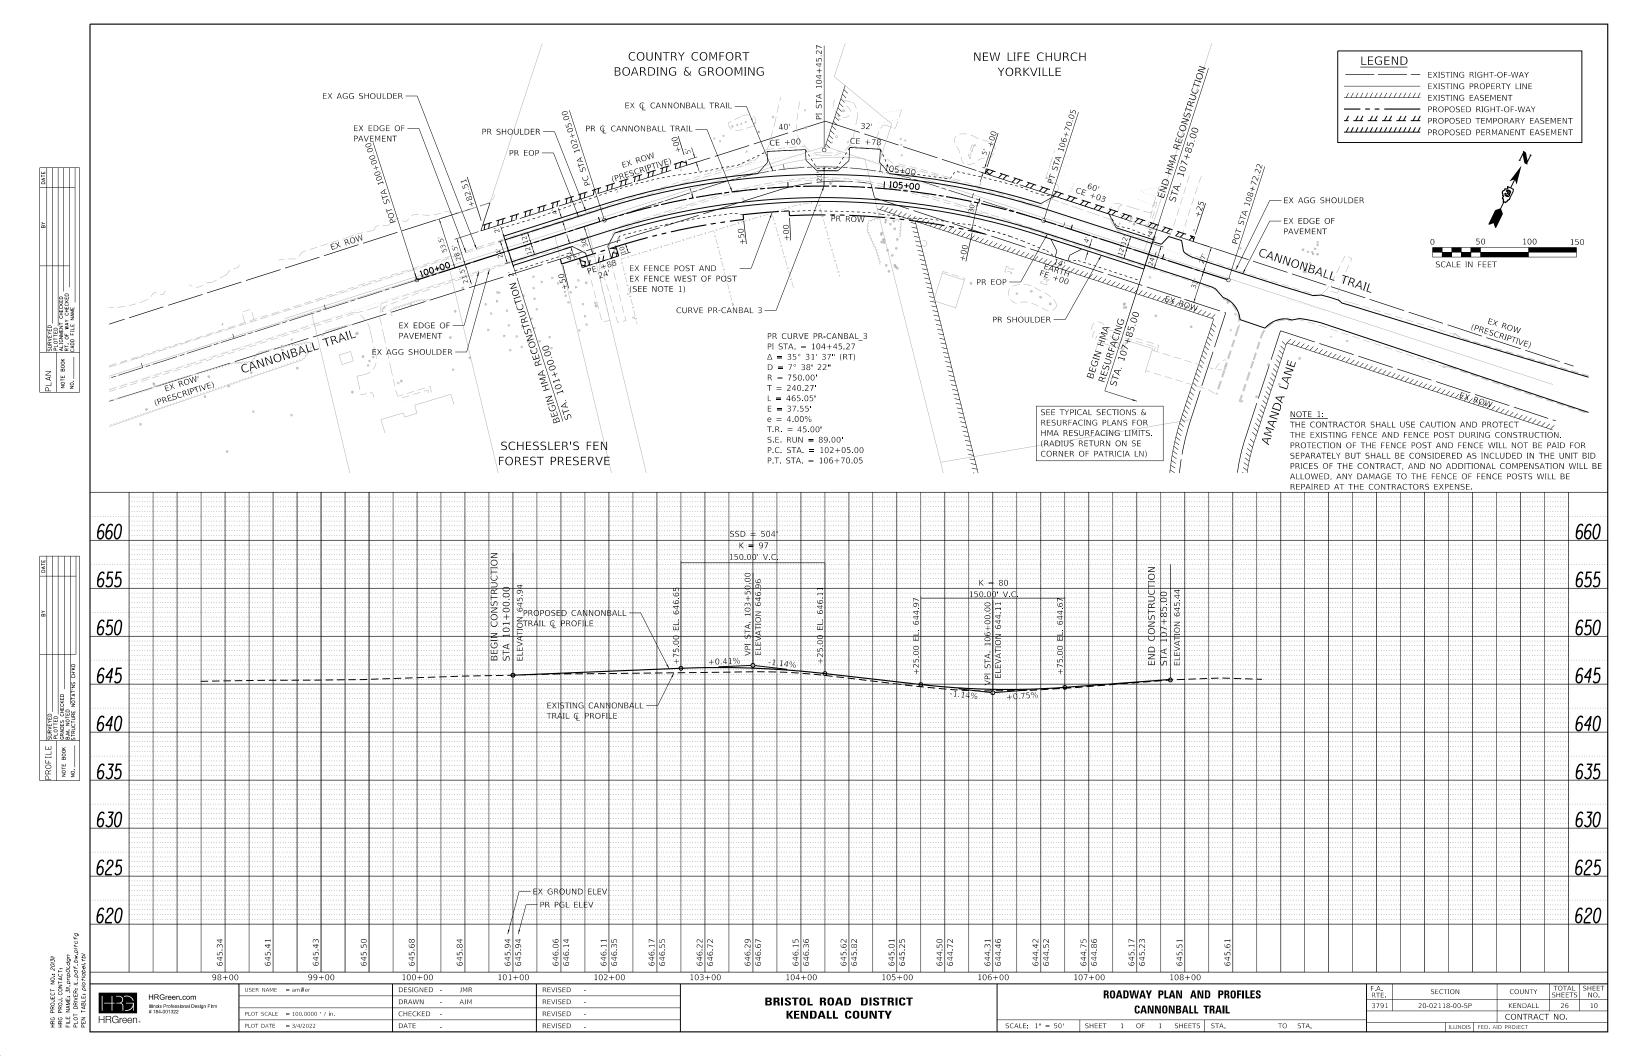
HRGreen.

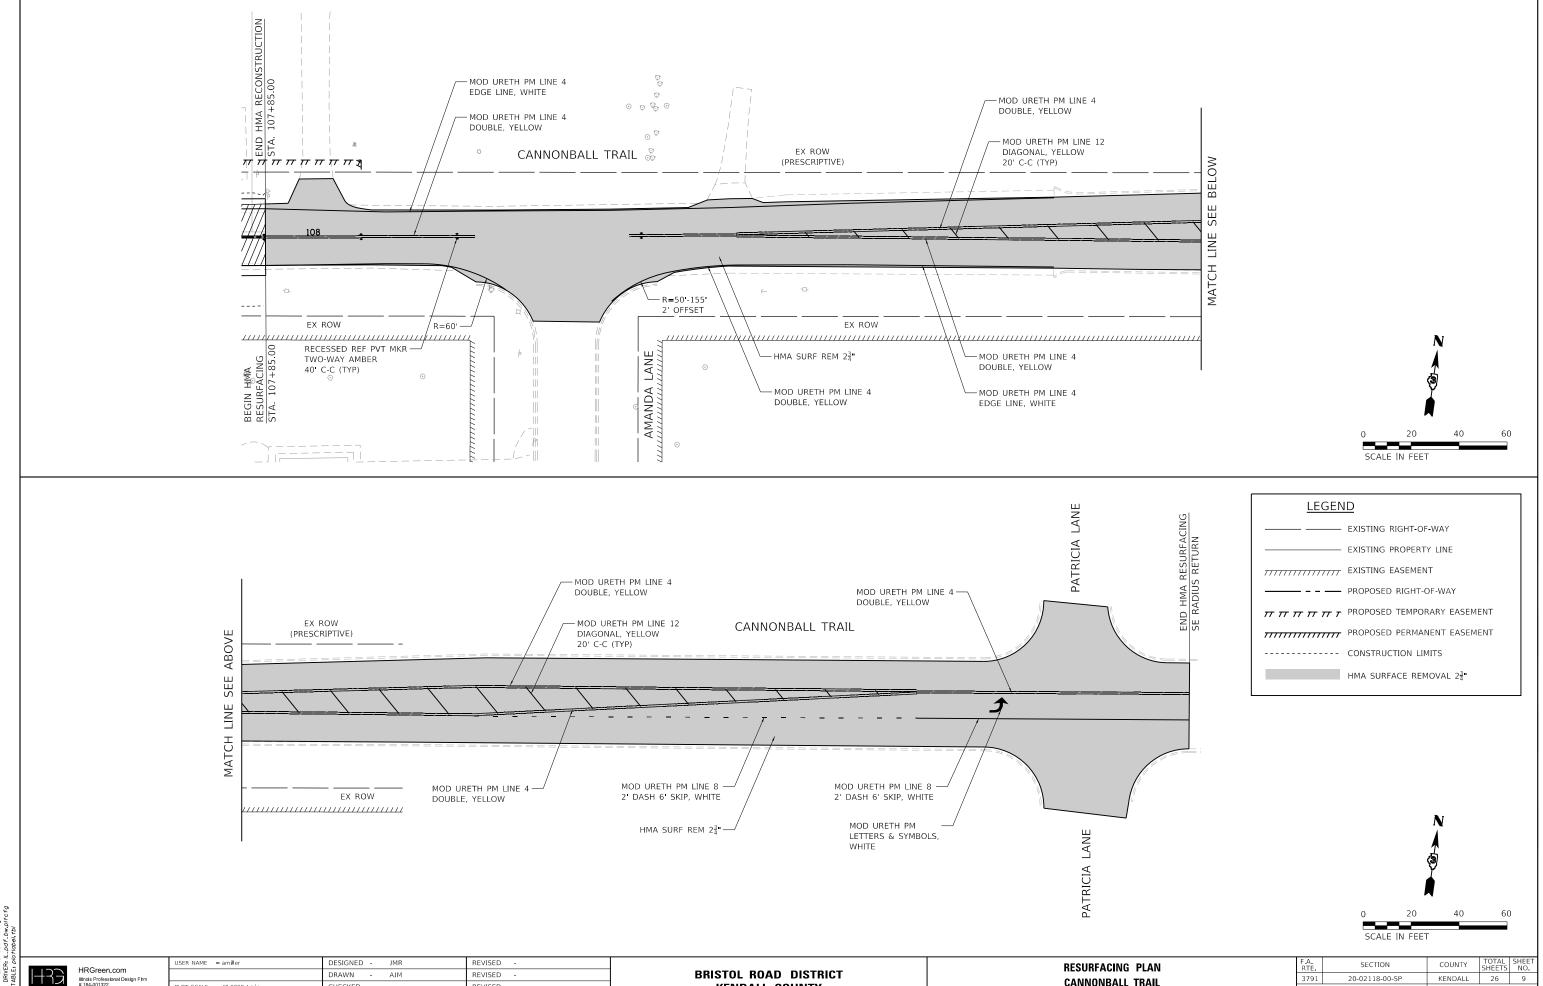CHECKED REVISED PLOT DATE = 3/4/2022 DATE REVISED

**KENDALL COUNTY** 

**CANNONBALL TRAIL** SCALE: 1" = 20' SHEET 1 OF 1 SHEETS STA.

TO STA.



### PRE STAGE - CANNONBALL TRAIL

- MILL 2<sup>3</sup>/<sub>4</sub>" OF CANNONBALL TRAIL FROM STATION 107+85 TO RADIUS RETURN ON SOUTHEAST CORNER OF PATRICIA LANE INTERSECTION UNDER TRAFFIC IN ACCORDANCE WITH STANDARD 701306.
- 2. INSTALL TEMPORARY PAVEMENT MARKING AS NECESSARY.

### STAGE I - CANNONBALL TRAIL

- 1. SHIFT CANNONBALL TRAIL TRAFFIC SOUTH PER STAGE 1 MOT PLANS.
- REMOVE THE APPLICABLE SHOULDER ALONG THE NORTH SIDE OF CANNONBALL TRAIL AND CONSTRUCT THE TEMPORARY PAVEMENT UNDER TRAFFIC IN ACCORDANCE WITH STANDARD 701306-04.

### STAGE II - CANNONBALL TRAIL

- 1. SHIFT CANNONBALL TRAIL TRAFFIC NORTH PER THE STAGE II MOT PLANS.
- REMOVE THE EXISTING PAVEMENT AND CONSTRUCT THE SOUTH SIDE OF CANNONBALL TRAIL UP TO BUT NOT INCLUDING THE FINAL LIFT OF HMA BINDER COURSE
- 3 CONSTRUCT FINAL GRADING ALONG THE SOUTH SIDE OF CANNONBALL TRAIL ACCORDING TO THE PLANS.

### STAGE III - CANNONBALL TRAIL

- SHIFT THE EASTBOUND TRAFFIC ALONG CANNONBALL TRAIL SOUTH PER STAGE III MOT PLANS.
- WESTBOUND TRAFFIC TO REMAIN ON PREVIOUSLY CONSTRUCTED TEMPORARY PAVEMENT PER THE STAGE III MOT PLANS.
- REMOVE THE APPLICABLE PORTIONS OF THE TEMPORARY PAVEMENT PER THE STAGE III MOT PLANS.
- 4. REMOVE THE EXISTING PAVEMENT AND CONSTRUCT THE APPLICABLE PORTIONS OF THE NORTH SIDE OF CANNONBALL TRAIL UP TO BUT NOT INCLUDING THE FINAL LIFT OF HMA BINDER COURSE PER THE STAGE II MOT PLANS.

### STAGE IIIA - CANNONBALL TRAIL

- 1 SHIFT TRAFFIC TO ITS FINAL CONFIGURATION ALONG CANNONBALL TRAIL.
- REMOVE THE TEMPORARY PAVEMENT ALONG THE NORTH SIDE OF CANNONBALL TRAIL.
- CONSTRUCT THE DRIVEWAY ENTRANCES AND FINAL GRADING ALONG THE NORTH SIDE OF CANNONBALL TRAIL.
- CONSTRUCT THE FINAL LIFT OF HMA BINDER COURSE AND SURFACE COURSE ON CANNONBALL TRAIL UNDER TRAFFIC IN ACCORDANCE WITH STANDARD 701306.
- 5. INSTALL PERMANENT STRIPING AND SIGNAGE ON CANNONBALL TRAIL.
- 6. FINAL LANDSCAPING.

### SUGGESTED MAINTENANCE OF TRAFFIC - GENERAL NOTES:

- 1. THE CONTRACTOR SHALL PLACE A CHANGEABLE MESSAGE SIGN AT EACH END OF THE PROJECT AND/OR AS DIRECTED BY THE ENGINEER TO INFORM MOTORISTS OF UPCOMING CONSTRUCTION ACTIVITIES. THESE MESSAGE SIGNS WITH THE APPROPRIATE INFORMATION SHALL BE IN PLACE TWO (2) WEEKS PRIOR TO THE START OF CONSTRUCTION ACTIVITY. THIS WORK IS TO BE PAID FOR AT THE CONTRACT UNIT PRICE PER CALENDAR MONTH FOR CHANGEABLE MESSAGE SIGN, SPECIAL. A MINIMUM OF ONE THROUGH LANE IN EACH DIRECTION SHALL REMAIN OPEN ON CANNONBALL TRAIL AT ALL TIMES, EXCEPT FOR PERIODS OF SHORT DURATION DURING MILLING AND RESURFACING OPERATIONS OR AS DIRECTED BY THE ENGINEER. TEMPORARY TRAFFIC LANES SHALL BE A MINIMUM OF 10' WIDE ALONG CANNONBALL TRAIL.
- 2. ACCESS TO ALL PROPERTIES SHALL BE MAINTAINED AT ALL TIMES, EXCEPT FOR PERIODS OF SHORT DURATION AS DETERMINED BY THE ENGINEER. THE CONTRACTOR SHALL NOTIFY PROPERTY OWNERS A MINIMUM OF 48 HOURS PRIOR TO ANY ACCESS RESTRICTIONS OR CLOSURES. CONSTRUCTION ADJACENT TO AN ENTRANCE, RESULTING IN A TEMPORARY CLOSURE TO THE ENTRANCE, SHALL BE EXPEDITED AND THE ENTRANCE REOPENED TO TRAFFIC AS SOON AS POSSIBLE. DURING THE TEMPORARY CLOSURE, THE CONTRACTOR SHALL PROVIDE TYPE III BARRICADES WITH "ROAD CLOSED" SIGNS AT THE LOCATIONS DESIGNATED BY THE ENGINEER. TEMPORARY CLOSURES AT ENTRANCES WILL NOT BE PERMITTED DURING THE WEEKEND.
- 3. WORK ZONE PAVEMENT MARKING FOR THE MAINTENANCE OF TRAFFIC SHALL CONSIST OF PAVEMENT MARKING TAPE, TYPE III. EXISTING PAVEMENT MARKINGS IN CONFLICT WITH MAINTENANCE OF TRAFFIC TEMPORARY PAVEMENT MARKINGS SHALL BE REMOVED.
- 4. EXISTING OR PROPOSED TRAFFIC SIGNS CONFLICTING WITH THE TEMPORARY TRAFFIC CONTROL SHALL BE TEMPORARILY REMOVED OR COVERED AS DIRECTED BY THE ENGINEER.
- 5. THE CONTRACTOR SHALL MAINTAIN POSITIVE DRAINAGE AS REQUIRED OR AS DIRECTED BY THE ENGINEER THROUGHOUT THE CONSTRUCTION ZONE FOR THE DURATION OF CONSTRUCTION. THIS WORK SHALL BE INCLUDED IN THE COST OF THE TEMPORARY DRAINAGE WORK. THE EXISTING DRAINAGE SYSTEM SHALL BE USED THROUGHOUT CONSTRUCTION STAGING.
- 6. ALL ADVANCE "ROAD CONSTRUCTION" SIGNS, W20-1 SERIES, AS SHOWN ON THE PLANS, REFERENCED IN THE STANDARDS OR DIRECTED BY THE ENGINEER, SHALL BE EQUIPPED WITH A TYPE B MONODIRECTIONAL FLASHING LIGHT, THE COST OF THIS WORK SHALL BE INCLUDED IN THE COST FOR TRAFFIC CONTROL AND PROTECTION, (SPECIAL).
- 7. VARIOUS TEMPORARY INFORMATION SIGNS SHALL BE REQUIRED AS DIRECTED BY THE ENGINEER. THIS SHALL BE PAID FOR AS THE FOLLOWING: TEMPORARY INFORMATION SIGNING

# VARIES 2' - 17' SEE MOT SHEETS WORK ZONE \*\*TEMPORARY PAVEMENT

### STAGE II MOT TYPICAL SECTION

- \* TEMPORARY DRAINAGE EASEMENT STA. 100+82.51 TO STA. 103+00.00 STA. 106+00.00 TO STA. 108+25.00
- \*\* TEMPORARY PAVEMENT
- STA. 99+50.00 TO STA. 109+35.00
- \*\* MAINTAIN 11' LANES IN STAGE II AS SHOWN IN THE STAGE II PLANS

## TEMPORARY PAVEMENT STRUCTURE

8" FULL DEPTH HMA PAVEMENT 8" HMA BINDER COURSE, IL-19.0, N70 4" SUBBASE GRANULAR MATERIAL TYPE B


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	DRAWN - AJM	REVISED -
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PLOT DATE = 3/4/2022	DATE -	REVISED -

SU	GGESTE	D	MAIN	ITE	NANCE	OF TRAFFI	C PLANS		F.A. RTE	SECT	TION	COUNTY	TOTAL SHEETS	SHEET NO.
GENERAL NOTES							3791	20-0211	.8-00-SP	KENDALL	. 26	11		
			G.	-141	IIAL NO	ILU					CONTRA	CONTRACT NO.		
	SHEET	1	OF	1	SHEETS	STA	TO STA	i			TILLINOIS LEED	AID DROIFET		

ADVANCED WIDTH RESTRICTION SIGNING


W12-I102(0)-48

W12-I102(0)-48

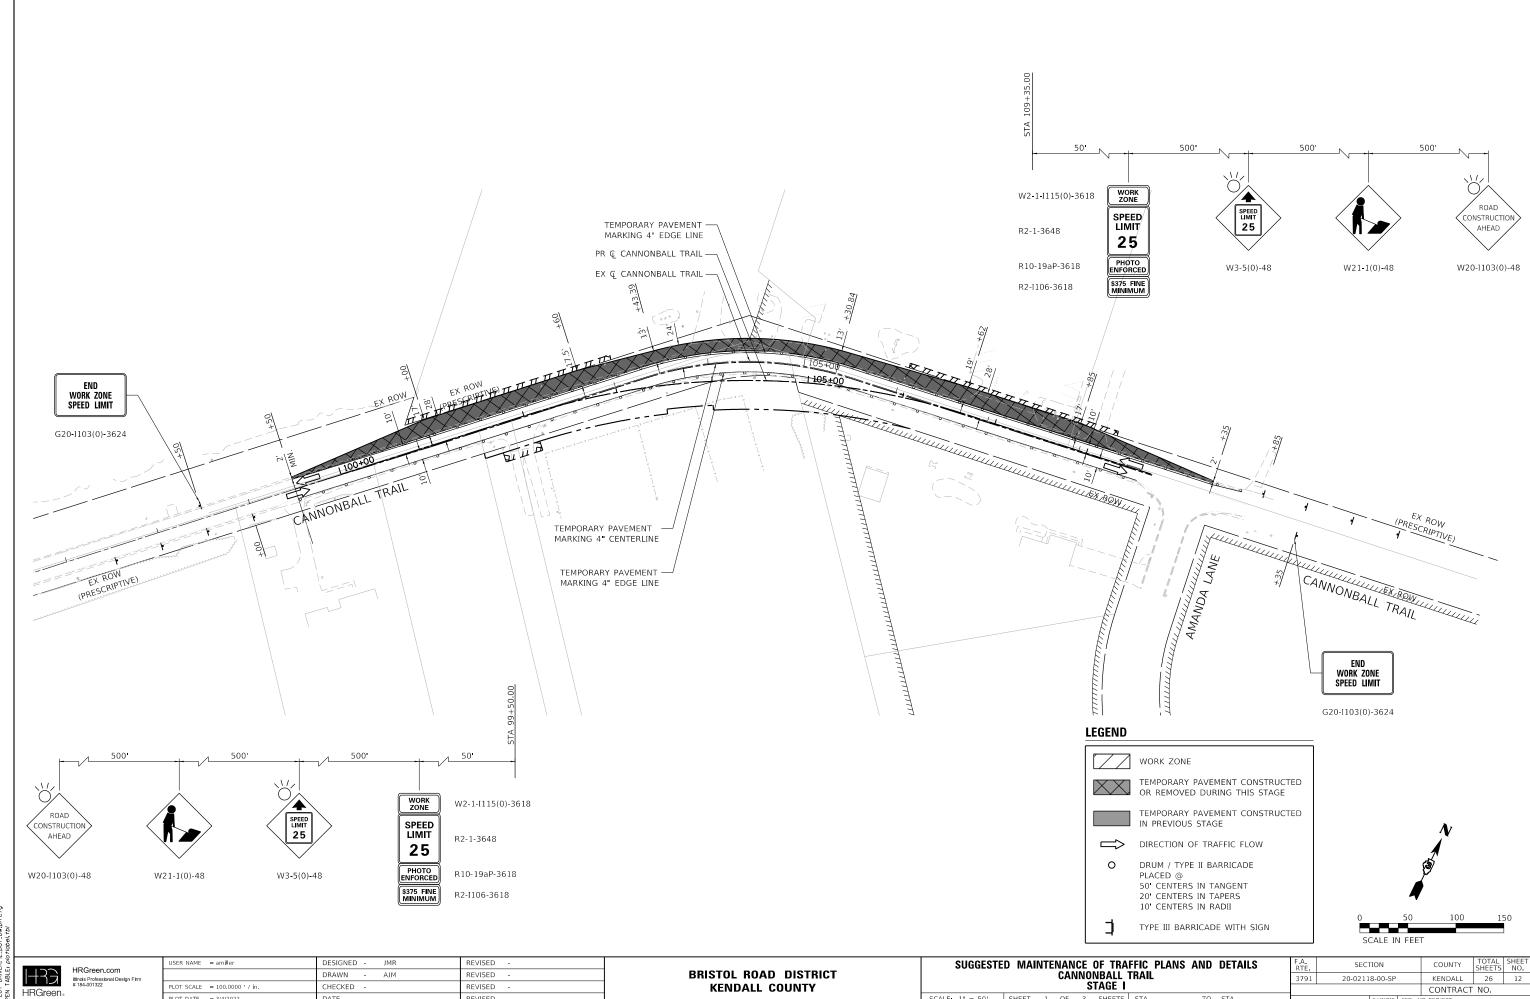

**KENDALL COUNTY** 


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**KENDALL COUNTY** 

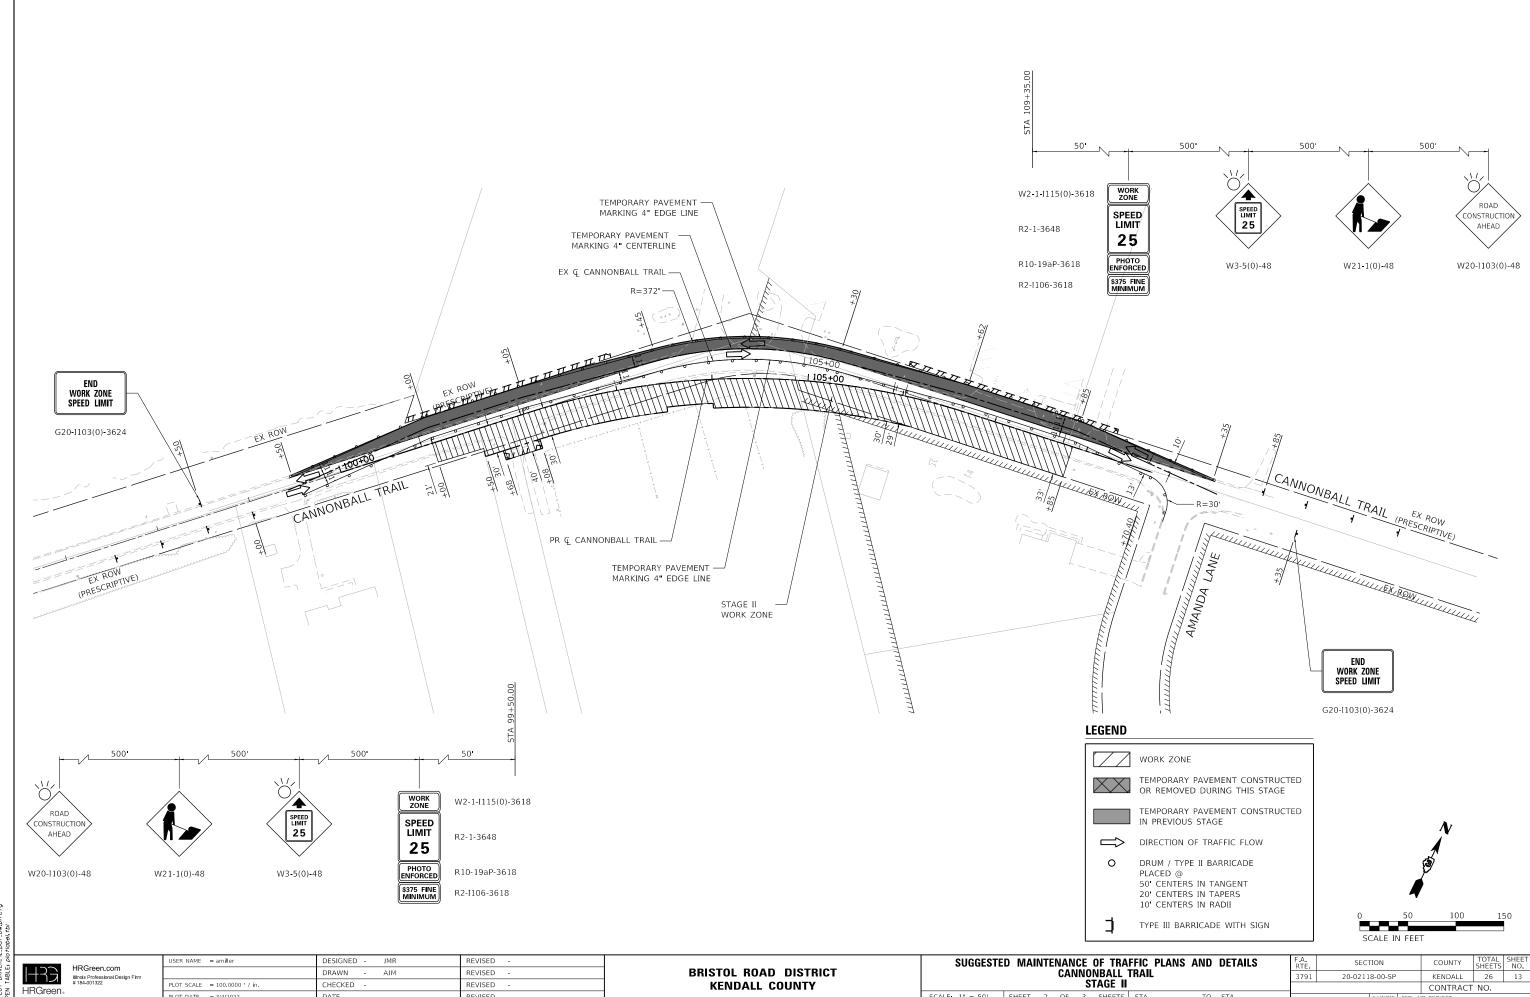
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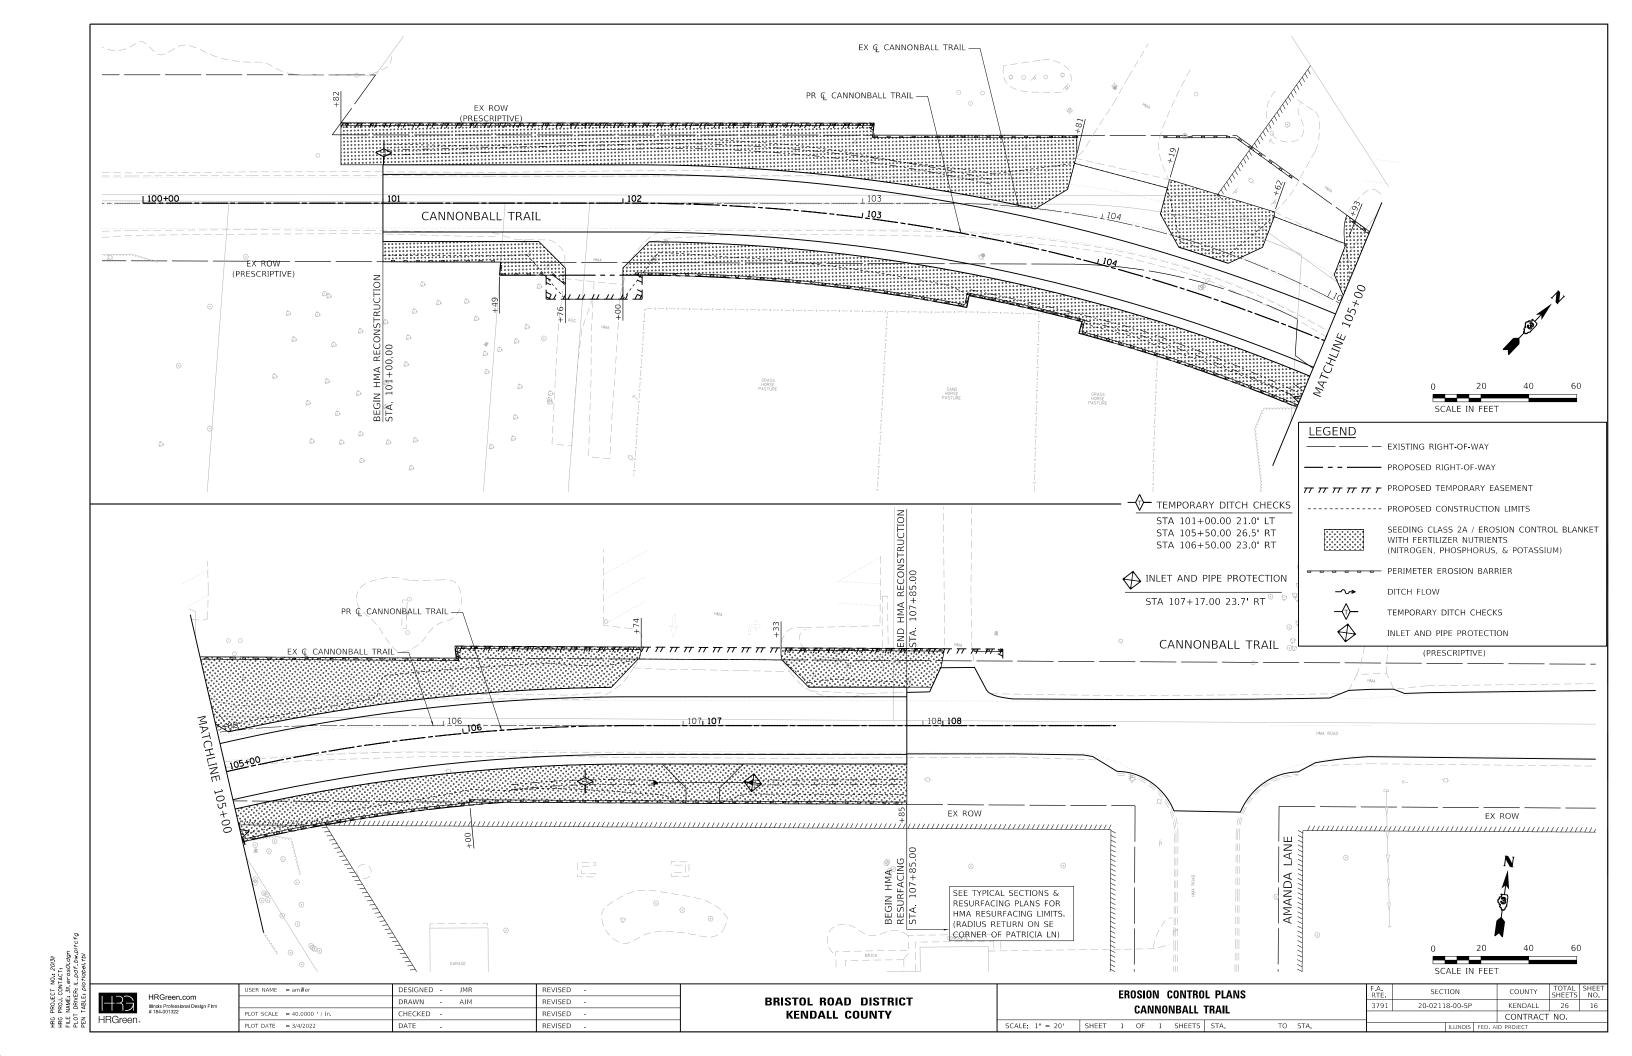



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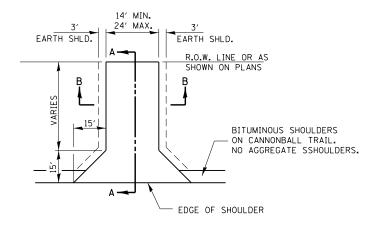
**KENDALL COUNTY** 


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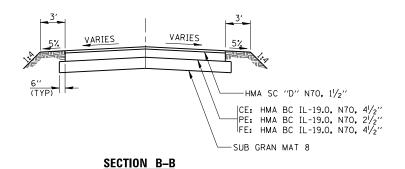


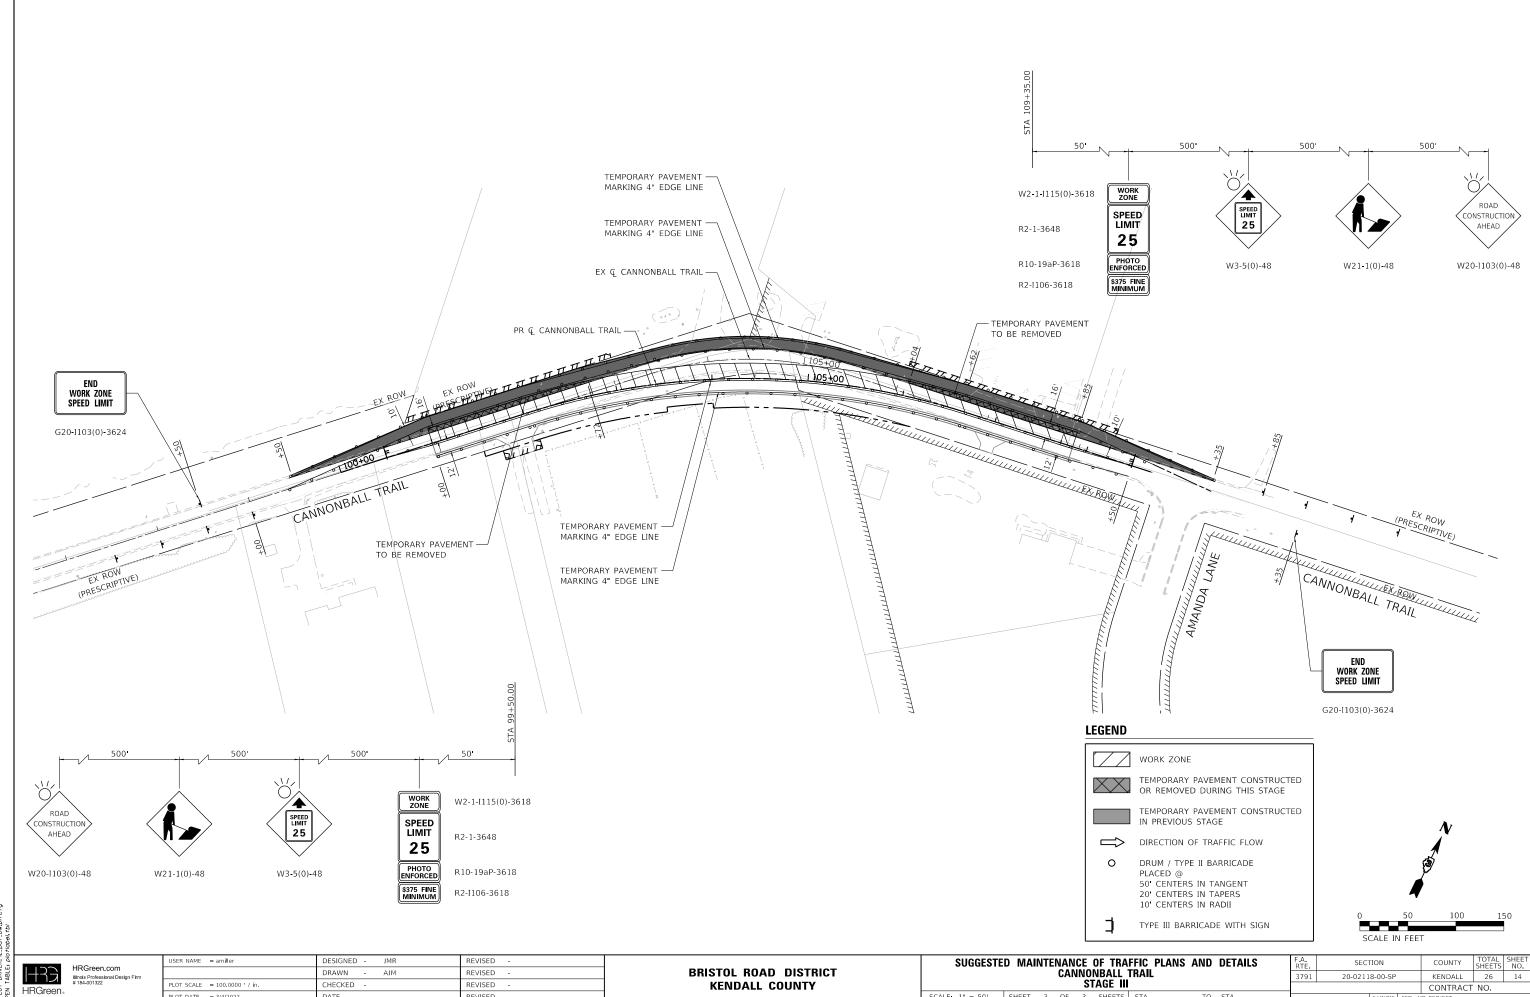


\* SLOPE AWAY FROM HIGHWAY SURFACE AT 1.5% MINIMUM TO 10% MAXIMUM FOR A RURAL COMMERCIAL ACCESS A DISTANCE OF 10' OR TO CENTERLINE OF DITCH.
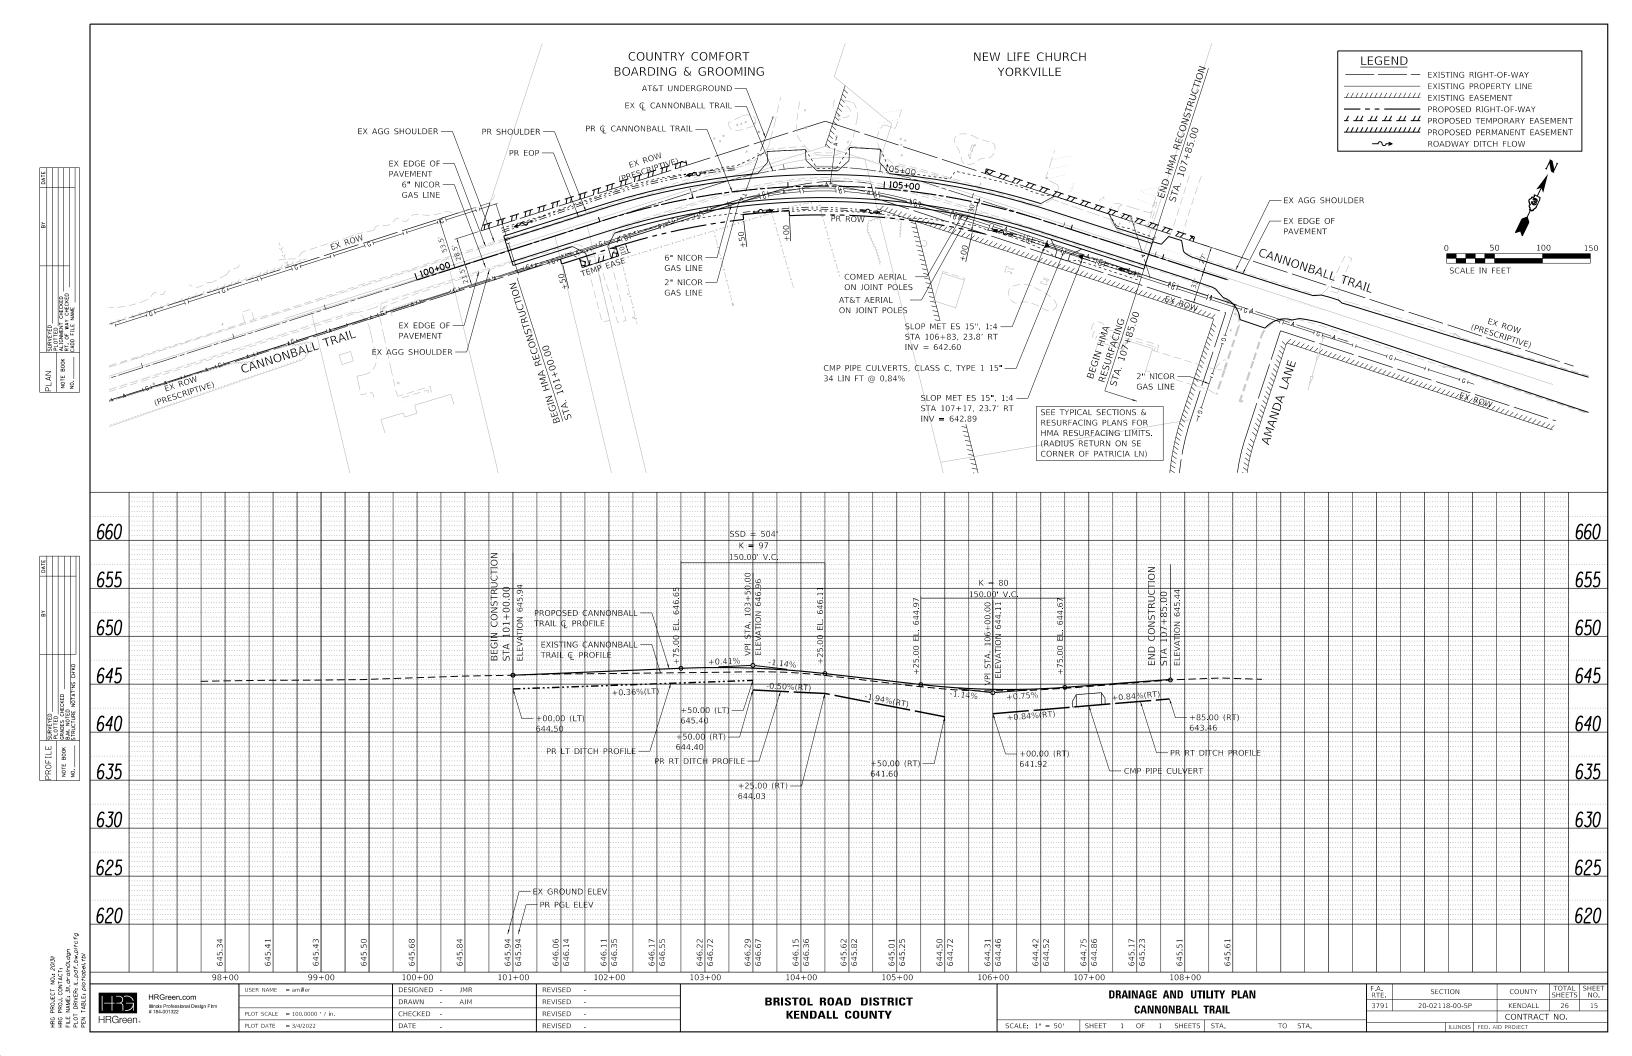
### SECTION A-A

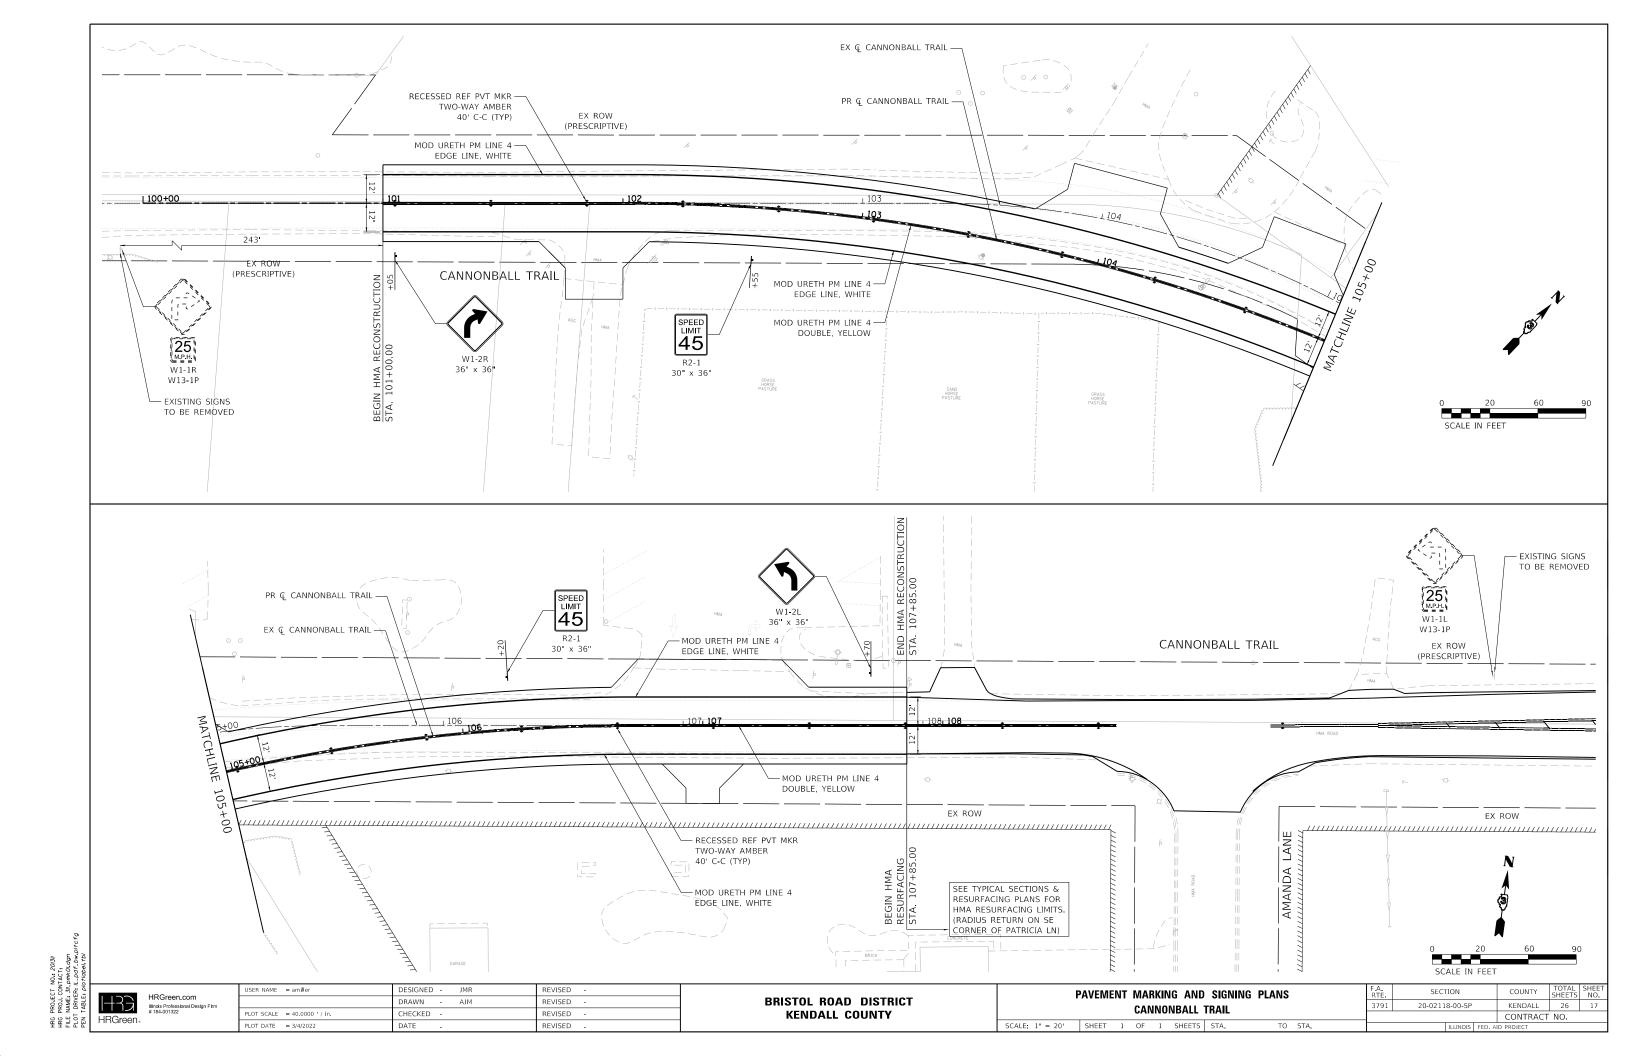
SLOPE AWAY FROM HIGHWAY SURFACE AT 1.5% MINIMUM TO 8% MAXIMUM FOR A RURAL NONCOMMERCIAL ACCESS A DISTANCE OF 10' OR TO CENTERLINE OF DITCH. (PRIVATE ENTRANCE AT STA 630+97 DIFFERS FROM DETAIL, SEE CROSS SECTIONS).

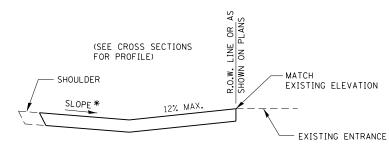

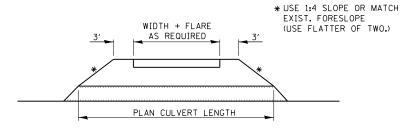

ALL DRIVEWAYS SHALL BE SURFACED FROM THE EDGE OF PAVEMENT TO THE RIGHT OF WAY LINE.


### **ENTRANCE DETAIL**

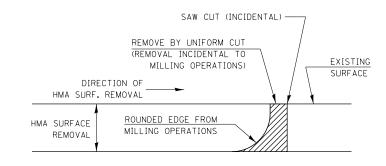


### NOTE:


WHEN MILLING OPERATIONS PRODUCE A ROUNDED EDGE, THEN A SAW CUT SHALL BE USED TO MANUFACTURE A PERPENDICULAR EDGE AS SHOWN IN THE DETAIL. THE ENGINEER SHALL BE THE SOLE JUDGE CONCERNING THE USE OF THIS DETAIL

### HMA DETAIL AT BUTT JOINTS

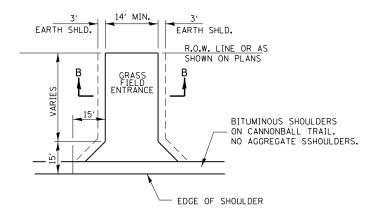

(SEE CROSS SECTIONS FOR PROFILE)

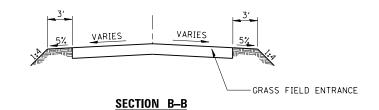

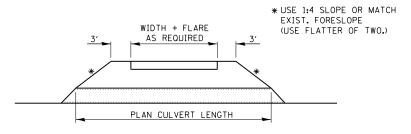

NOTE: GRASS FIELD ENTRANCE SHALL BE GRADED FROM THE EDGE OF SHOULDER TO THE RIGHT OF WAY LINE.

### **GRASS FIELD ENTRANCE DETAIL** (STA 107 + 00.00 RT)




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JSER NAME = amiller DESIGNED - JMR REVISED DRAWN -MLA REVISED HECKED REVISED PLOT DATE = 3/4/2022 REVISED DATE


**BRISTOL ROAD DISTRICT KENDALL COUNTY** 

								F.A. RTE	SEC.	TION		COUNTY	TOTAL SHEETS	SHEET NO.
MISCELLANEOUS DETAILS								3791	20-0211	8-00-SP		KENDALL	26	18
												CONTRACT	NO.	
SHEET	1	OF	3	SHEETS	STA.	TO	STA.			ILLINOIS	EED ΔI	ID PROJECT		

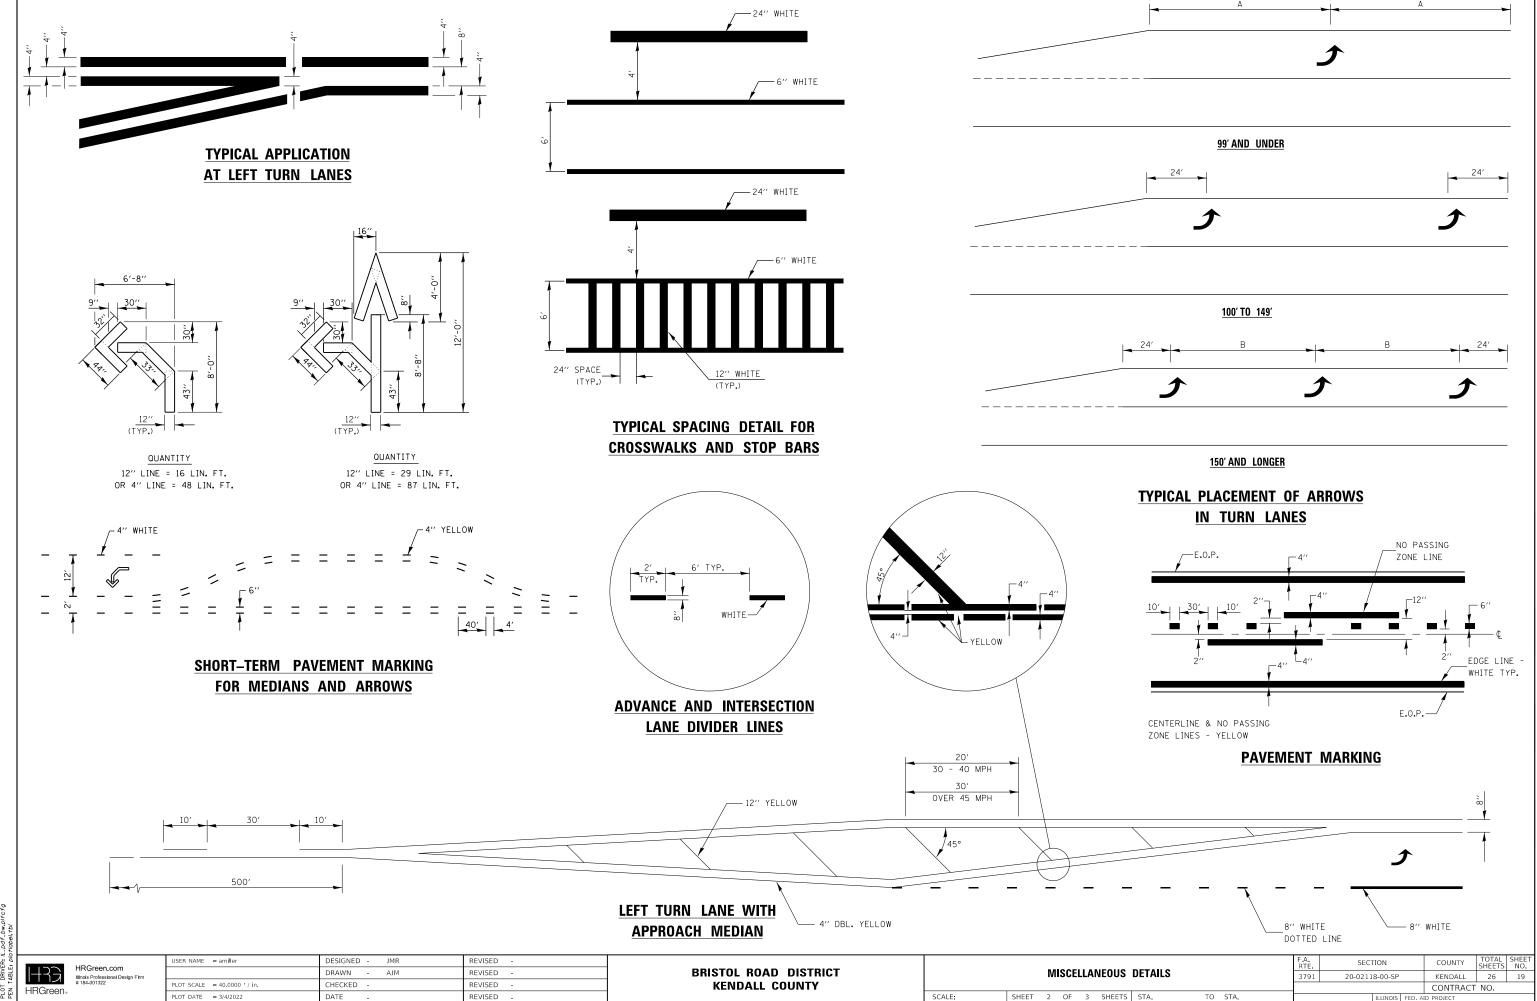

PLOT DATE = 3/4/2022 DATE

SHEET 2 OF 3 SHEETS STA.

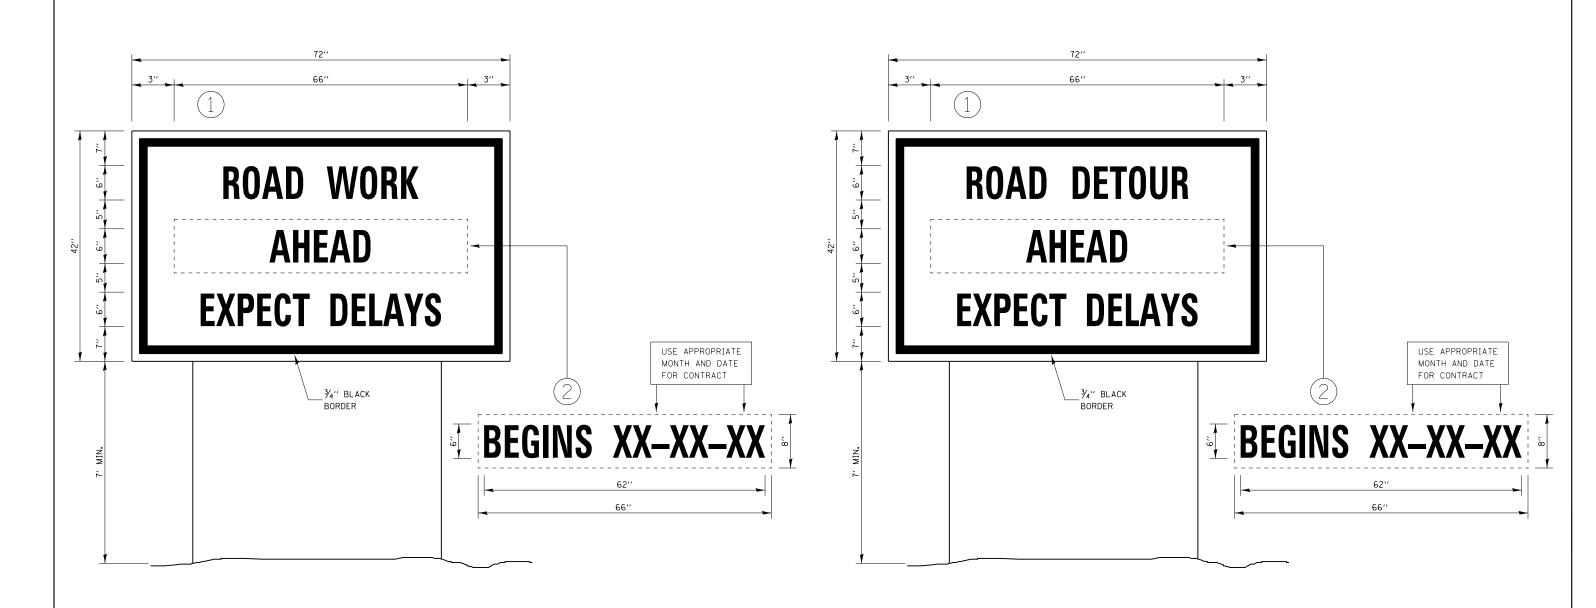

### **TEMPORARY INFORMATION SIGNING**

### NOTES:

- 1. USE 6" D BLACK LETTERING ON FLOURESENT ORANGE BACKGROUND.
- ERECT SIGNS AT LOCATIONS IN ADVANCE OF THE "ROAD CONSTRUCTION AHEAD" SIGNS AS DIRECTED BY THE ENGINEER.
- 3. ERECT SIGN() WITH INSTALLED PANEL (2) A MINIMUM OF ONE WEEK PRIOR TO THE START OF THE LANE CLOSURE.
- 4. REMOVE PANEL 2 ON THAT DATE.
- 5. SEE SPECIAL PROVISION "TEMPORARY INFORMATION SIGNING" FOR ADDITIONAL INFORMATION.
- 6. WILL BE PAID FOR PER SO FT AS "TEMPORARY INFORMATION SIGNING". EACH SIGN = 21 SQ FT AND THE DATE PANEL WILL NOT BE MEASURED SEPARATELY FOR PAYMENT.

### **TEMPORARY INFORMATION SIGNING**

### NOTES:

- 1. USE 6" D BLACK LETTERING ON FLOURESENT ORANGE BACKGROUND.
- 2. ERECT SIGNS AT LOCATIONS IN ADVANCE OF THE "ROAD CONSTRUCTION AHEAD" SIGNS AS DIRECTED BY THE ENGINEER.
- 3. ERECT SIGN () WITH INSTALLED PANEL (2) A MINIMUM OF ONE WEEK PRIOR TO THE START OF THE DETOUR.
- 4. REMOVE PANEL 2 ON THAT DATE.
- 5. SEE SPECIAL PROVISION "TEMPORARY INFORMATION SIGNING" FOR ADDITIONAL INFORMATION.
- 6. WILL BE PAID FOR PER SQ FT AS "TEMPORARY INFORMATION SIGNING". EACH SIGN = 21 SQ FT AND THE DATE PANEL ② WILL NOT BE MEASURED SEPARATELY FOR PAYMENT.

### TEMPORARY INFORMATION SIGN DETAILS



USER NAME = amiller	DESIGNED - JMR	REVISED -
	DRAWN - AJM	REVISED -
PLOT SCALE = 40.0000 ' / in.	CHECKED -	REVISED -
PLOT DATE = 3/4/2022	DATE	REVISED

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	MISCELLANEOUS DETAILS									3791 20-02118-00-SP			KENDALL	26	20			
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SCALE:	SHEET	3	OF	3	SHEETS	STA.		TO	STA.			ILLINOIS FED. AID PROJECT						

