



**KENDALL COUNTY
STORMWATER MANAGEMENT OVERSIGHT COMMITTEE
PUBLIC HEARING**

111 West Fox Street • Room 209 and 210 • Yorkville, IL • 60560
(630) 553-4141 Fax (630) 553-4179

AGENDA

June 18, 2024 – 9:00 a.m.

CALL TO ORDER

ROLL CALL: Zach Bachman, Brian DeBolt, Elizabeth Flowers, Scott Gengler (Vice-Chair), Matt Kellogg (Chair), Dan Koukol, Jason Peterson, Brooke Shanley, Ruben Rodriguez, and Seth Wormley

APPROVAL OF AGENDA (VV)

APPROVAL OF MINUTES (VV) October 12, 2023, Public Hearing/Meeting (Pages 2-3)

PUBLIC COMMENT

OPEN OF STORMWATER MANAGEMENT OVERSIGHT COMMITTEE PUBLIC HEARING

ITEMS OF BUSINESS FOR PUBLIC HEARING (ROLL CALL VOTE) (Pages 4-60)

1. **Petition 24-15 Kendall County Forest Preserve District**

Request	Stormwater Management Variance
Location	Subat Forest Preserve (4845 Eldamain Road, Plano) in Little Rock Township
PINs	01-25-400-009, 01-36-200-022, and 01-36-200-025
Purpose	Request for Approval of a Variance to Section 203 of the Kendall County Stormwater Management Ordinance Regarding Applicability of Site Runoff Storage Requirements. The Petitioner Requests a Variance that Allows Exclusion of the Impervious Trail Sections of the Subat Forest Preserve Nature Center Project in the Calculation of Total Impervious Improvements Resulting in No Stormwater Detention Requirement for the Project. The Petitioner Requests a Variance from Site Runoff Storage Requirements to Avoid Unnecessary Disturbance of Restored Prairie Habitats and Native Trees that Reside within Subat Forest Preserve.

CLOSE OF STORMWATER MANAGEMENT OVERSIGHT COMMITTEE PUBLIC HEARING

OTHER BUSINESS

ADJOURNMENT (VV)

If special accommodations or arrangements are needed to attend this County meeting, please contact the Administration Office at 630-553-4171, a minimum of 24-hours prior to the meeting time.

**KENDALL COUNTY
STORMWATER OVERSIGHT COMMITTEE
PUBLIC HEARING
*Kendall County Office Building
Rooms 209 & 210
111 W. Fox Street, Yorkville, Illinois*
Meeting Minutes of October 12, 2023 – Unofficial Until Approved
4:00 p.m.**

CALL TO ORDER

Chairman Kellogg called the Stormwater Oversight Committee Public Hearing to order at 4:00 p.m.

ROLL CALL

Committee Members Present: Zach Bachman, Brian DeBolt, Scott Gengler, Matt Kellogg, Dan Koukol, Jason Peterson, Ruben Rodriguez (Arrived at 4:04 p.m.), Brooke Shanley, and Seth Wormley (Arrived at 4:04 p.m.)

Committee Members Absent: Elizabeth Flowers

Also present: Matt Asselmeier, Ryan Zaborowski, Christina Burns, Greg Chismark, and Stasi Brown

APPROVAL OF AGENDA

Member DeBolt made a motion, seconded by Member Peterson, to approve the agenda as presented. With a voice vote of seven (7) ayes, the motion carried.

APPROVAL OF MINUTES

Member Gengler made a motion, seconded by Member Bachman, to approve the minutes of the October 13, 2022, public hearing and meeting. With a voice vote of seven (7) ayes, the motion carried.

PUBLIC COMMENT

None

OPEN OF STORMWATER MANAGEMENT OVERSIGHT COMMITTEE PUBLIC HEARING

Chairman Kellogg opened the Stormwater Management Oversight Committee Public Hearing at 4:01 p.m.

Comments on Stormwater Management Related Regulations and Enforcement

Mr. Asselmeier read a memo regarding stormwater related activities since the October 2022 hearing/meeting. He noted the funds in the stormwater fee-in-lieu accounts, the statistics on stormwater management permits for the year, the status of WBK Engineering's review of the

State's floodplain regulations, updates on stormwater ordinance violation investigations, and provided the survey results from the 2023 NPDES survey to the townships.

Mr. Asselmeier also provided draft comments from WBK Engineering regarding the removal of several dams along the Fox River. He noted WBK Engineering's concerns related to increased sedimentation at the Yorkville dam because of the removal of the dams upstream.

Members Rodriguez and Wormley arrived at this time (4:04 p.m.).

Member DeBolt asked about ordinance enforcement procedure. Mr. Asselmeier explained the enforcement procedure for stormwater ordinance violations, from warning notice to court procedures in cases of non-compliance.

Member Gengler asked about the frequency of dam removals. Mr. Asselmeier responded that dam removals by the Corps of Engineers are rare.

Proposed Changes to the Kendall County Stormwater Management Ordinance

Mr. Asselmeier said that Staff had no proposed changes at this time.

No other proposed changes were presented by the Committee or members of the public.

CLOSE OF ANNUAL STORMWATER MANAGEMENT OVERSIGHT COMMITTEE PUBLIC HEARING

Chairman Kellogg closed the Stormwater Management Oversight Committee Public Hearing at 4:05 p.m.

OTHER BUSINESS

None

ADJOURNMENT

Member Koukol made a motion, seconded by Member Shanley, to adjourn the meeting. With a voice vote of nine (9) ayes, the motion carried. The Stormwater Management Oversight Committee adjourned at 4:05 p.m.

Respectfully submitted,
Matthew H. Asselmeier, AICP, CFM
Director



Kendall County Agenda Briefing

Meeting Type: Other Committee
Meeting Date: 6/18/2024
Subject: Approval of Petition 24-15, Stormwater Ordinance Variance for Subat Forest Preserve
Prepared by: Matthew H. Asselmeier, AICP, CFM
Department: Planning, Building and Zoning

Action Requested:

Approval of Petition 24-15, A Request from the Kendall County Forest Preserve District for a Variance to Section 203 of the Kendall County Stormwater Management Ordinance Regarding Applicability of Site Runoff Storage Requirements at the Subat Forest Preserve Located at 4845 Eldamain Road, Plano (PINs: 01-25-400-009, 01-36-200-022, and 01-36-200-025) in Little Rock Township

Previous Board/Committee Review:

N/A

Fiscal impact:

N/A

Background and Discussion:

The Petitioner requests a variance that allows exclusion of the impervious trail sections of the Subat Forest Preserve Nature Center Project in the calculation of total impervious improvements resulting in no stormwater detention requirement for the project. The Petitioner requests a variance from site runoff storage requirements to avoid unnecessary disturbance of restored prairie habitats and native trees that reside within Subat Forest Preserve.

Per the application, “the project has an impervious area of 36,850 sf. Under current project conditions, the Ordinance requires detention for developments resulting in an impervious area of greater than 32,000 sf. The trail section of the project constitutes 19,930 sf of impervious area or approximately 54% of the total impervious area of the project.”

Greg Chismark, from WBK Engineering, reviewed the proposal and recommended approval. As of the date this memo, the four (4) outstanding items noted in Greg Chismark’s letter that needed to be resolved in order to issue the stormwater permit remained unresolved.

The property previously obtained stormwater permits in 2003 for the installation of the parking lot, picnic shelter, and overlook platform and in 2005 for wetland restoration.

Based on the information provided by the Petitioner and WBK, Staff believes that the following findings of fact as required by Section 904.1 of the Kendall County Stormwater Management Ordinance have been met:

1. The variance will not increase the probability of flood damage or create an additional threat to the public health, safety or welfare.
2. The variance requested is the minimum relief necessary to accomplish the objectives of the development without compromising the objectives of Section 102 of the Kendall Stormwater Management Ordinance.
3. The variance will not result in a reduction of water quality benefits as compared to compliance with ordinance requirements.
4. The variance is not requested solely for the purpose of reducing site runoff storage requirements.
5. The variance shall not cause conveyance of stormwater from the project to increase peak discharges beyond design capacity of existing offsite conveyance facilities for any storm event from the 2-year to the 100-year recurrence frequency.
6. The variance shall seek to preserve valuable environmental and biological resources including but not limited to stands of native trees, existing wetlands and natural floodplain storage.

Staff Recommendation:

Approval with Conditions

Attachments:

Application Materials

WBK Comment Letter Dated May 30, 2024

Draft Ordinance

May 7, 2024

Kendall County Department of Planning, Building, & Zoning
111 West Fox Street
Yorkville, Illinois, 60560

**SUBJECT: Subat Nature Center
Kendall County Forest Preserve District
ERA Project #W23229.00**

ERA is pleased to submit this stormwater permit application submittal for the renovation of Subat Nature Center. Enclosed you will find plans, exhibits, and a narrative describing the proposed work for this project.

All work has been completed by me or someone directly under my supervision, and this sheet signed and sealed will encompass all documents pertaining to the report.

I appreciate the opportunity for your review of this project.

Sincerely,

[Redacted Signature]

John Mayer, P.E., CFM
Project Manager



Expires: November 30, 2025

Existing Site Description

The project area is a nature preserve on three parcels owned by the Kendall County Forest Preserve District: 01-25-400-009, 01-36-200-022, and 01-36-200-025. Kendall County GIS indicates that the total property acreage is 67.27 acres. It is noted that disturbance of the property will be limited to approximately 1.63 acres.

The existing site includes a gravel parking lot, shelter, restroom building, and associated aggregate paths. Stormwater drainage directions vary across the property, with some areas draining south and west toward Rob Roy Creek, some areas draining toward on-site wetlands, and some areas draining south toward River Road.

There are no regulatory floodplain areas on the project site, as shown in Exhibit 5. ERA completed a wetland delineation of the project area on September 22, 2023 which identified on-site wetlands, as depicted in Exhibit 7. ERA is coordinating with the US Army Corps of Engineers to obtain a permit for minimal wetland impacts associated with installation of a boardwalk as part of this project. Additional exhibits are provided to include depictions of the site location, aerial imagery, soils, and USGS topography. It is noted that surveyed topography is provided in the plan set in areas where development is proposed, and that the project study area shown in these exhibits broadly depicts the location of the project and does not represent the disturbance area depicted in the provided plan set.

Existing site conditions are shown in Sheet L100 of the provided plan set.

Proposed Site Description

The proposed project includes expansion and upgrade of the existing parking lot with an additional entrance along Eldamain Road, installation of new asphalt and crushed limestone walking paths, installation of a boardwalk, and installation of a nature center facility on a concrete pad. Proposed site conditions are shown in the provided plan set.

Proposed Drainage Features

Proposed drainage features include stormwater culverts installed under the new parking lot entrance at the northeast corner of the project area and under the portion of trail that crosses the roadside ditch at the northwest corner of Eldamain Road and River Road. ERA obtained Kendall County LIDAR data to delineate the tributary areas of the proposed culverts. A depiction of the delineated tributary areas is provided as Exhibit 8 of this submittal. The existing tributary area of the culvert location at the new parking lot entrance was determined to be 0.145 acre. ERA determined that a 12-inch RCP culvert would provide adequate flow capacity for this small area. It is noted that geometry and grading of the existing parking lot entrance will remain the same, and there is no existing or proposed stormwater conveyance proposed below this entrance. The existing tributary area of the culvert at the corner of River Road and Eldamain Road was determined to be 1.067 acres. ERA conservatively recommended a 21-inch RCP culvert to ensure that adequate flow capacity would be provided in the roadside ditch.

Although not required by the Kendall County Stormwater Management Ordinance, the proposed nature center facility is designed with rain gardens equipped with 4" mitered drain outlets to facilitate stormwater drainage. Rain garden locations are shown in C302 and associated design details are shown in L500 of the provided plan set.

The Kendall County Forest Preserve District will be responsible for maintenance responsibilities associated with all proposed drainage features, including regular inspection of the proposed RCP culverts and any associated repairs.

Development Areas and Detention Variance Request

The total development area of the project is approximately 71,125 sf (1.63-ac). The cumulative impervious improvement area of the project is approximately 36,850 sf (0.85-ac). In accordance with the Kendall County Stormwater Management Ordinance, since the development area is less than 5 acres, the % Impervious to Unit Area Detention nomograph depicted in Table 203 of the Ordinance may be used to determine the runoff storage volume requirement. Approximately 52% of the development area is impervious, therefore, 0.3 acre-ft of storage per acre of detention basin tributary area would be required. Assuming that the entire development area (1.63-ac) would be managed by the detention basin, approximately 0.49 ac-ft of storage volume would be required.

The Kendall County Forest Preserve District is requesting a variance from the detention requirement of the Kendall County Stormwater Management Ordinance for this project. Linear improvements such as impervious trails and walkways do not significantly impact site runoff rates, and providing detention for linear improvements is difficult and costly. For these reasons, the surrounding collar counties have specified exceptions to the detention requirements of their stormwater ordinances for impervious paths and trails developed in open space. In this particular case, asphalt and crushed limestone paths account for more than half of the proposed impervious development area. Other proposed impervious facilities, including the parking lot, entrances, and nature center account for approximately 16,920 sf of impervious area, which is less than the 32,000-sf impervious area threshold for site runoff storage requirements in the Kendall County Stormwater Management Ordinance. Additionally, the intent of this project is to improve and provide community access to the Subat Forest Preserve without resulting in unnecessary disturbance of on-site prairie and wetland areas. Due to the location of on-site wetlands, it is likely that at least two detention basins would be necessary to manage stormwater runoff from northern and southern project areas, resulting in additional on-site disturbance.

Soil Erosion and Sediment Control

The stormwater pollution prevention plan provided as L101 of the plan set describes the erosion control measure that will be implemented prior to the start of construction. Silt fencing is provided at downstream edges of the project. A temporary concrete washout location is proposed southwest of the facility parking lot. Excavated soils that are not repurposed as backfill material will be kept on-site and graded to maintain the existing site drainage direction, with silt fencing installed at the downstream edge of the stockpile area. All disturbed areas will be stabilized with topsoil, seed, and erosion control blanket in accordance with the IEPA General NPDES Permit for Construction Activities.

Conclusion

ERA looks forward to the County's review of this stormwater management permit application submittal for the renovation of Subat Nature Center. Please contact me with any questions or concerns at 630 393-3060 or jmayer@eraconsultants.com.

Respectfully submitted,
Engineering Resource Associates, Inc.



John F. Mayer, PE, CFM
Project Manager

Attachment 1 – Stormwater Management Permit Application Form
Attachment 2 – Exhibits
Attachment 3 – Plan Set

STORMWATER MANAGEMENT PERMIT

PERMIT APPLICATION # _____

Conformance with all Federal, State, and County Regulations is required. Applicants are encouraged to the Countywide Stormwater Management Ordinance and consider a pre-application meeting with Department staff prior to submittal. See attached highlights of regulations.

Property: Name Kendall County Forest Preserve District
Owner Address 110 W. Madison Street, Yorkville, IL 60560
Phone 630-553-4025
Agent: Name Engineering Resource Associates, Inc.
Address 3s701 W Avenue, Suite 150, Warrenville, IL 60555
Phone 630-393-3060
Site: Address or Location Intersection of Eldamain Road and River Road, Plano, IL 60545
Tax Parcel # 01-25-400-009, 01-36-200-022, and 01-36-200-025
Zoning/Land Use/Acres A1 Agricultural / Forest Preserve / 67.27 acres (1.63-ac disturbance)

Proposed Development:

The proposed development will upgrade facilities and walking paths at Subat Forest Preserve. Please see the description of the proposed development in the attached permit application memo.

Attachments: Plat _____ Construction Plans X
Soils _____ Landscaping _____
Grading X _____ Phasing _____
Other _____

Fees \$ _____ Processing Fee (\$50.00)
\$ _____ Engineering Review Deposit (\$2,500.00 or 2% of estimated cost of the proposed improvements, whichever is greater. A \$3,500.00 Construction Inspection Services Fee and General Consultation Fee Might Be Required as the Project Progresses)

TOTAL \$ _____ One check is acceptable made out to the Kendall County Treasurer

Staff will contact Applicant regarding schedule and reviews.

I hereby certify that the information on this application, on the documents attached, and on other submittals made during the review process is true and correct; that I am authorized to file this application; and that I agree to conform to all requirements set forth by the County and all conditions of the County Stormwater Management Ordinance. I understand that by signing this form, that the property in question may be visited by County Staff and County Engineers throughout the permit and construction process. I also understand that I am responsible for all costs associated with this application. The applicant attests that they are free of debt or current on all debts owed to Kendall County as of the application date.

Owner's Signature (Including Middle Initial) [Redacted Signature] Date 05/07/2024
Elec. Advisor - KcFPD
Agent's Signature (Including Middle Initial) _____ Date _____

Kendall County Planning, Building, & Zoning Department
111 West Fox Street, Room 203
Yorkville, Illinois 60560
Phone: (630) 553-4139, Fax (630) 553-4179
www.kendallcountvil.gov



DEPARTMENT OF PLANNING, BUILDING & ZONING

111 West Fox Street • Yorkville, IL • 60560
(630) 553-4141 Fax (630) 553-4179

ENGINEERING CONSULTANT FEES

I, _____ understand that Kendall County uses the services of a
Applicant Name

consultant for engineering reviews and inspections and that I will be responsible for
payment of services on _____ project. I authorize the consulting
Project Name
services to proceed.

☐ IF THIS IS **NOT** PART OF A BUILDING PERMIT APPLICATION, PLEASE CHECK THE BOX
AND COMPLETE THIS SECTION:

I hereby submit a deposit of _____ payable to the **Kendall County Treasurer**
\$ Amount

to be used by Kendall County to reimburse consultant for charges invoiced for work
done in the review, approval and inspection of the proposed improvements.

I understand that if the deposit is depleted that I may be required to replenish the
deposit to have work proceed.

I further understand that Kendall County will not issue a Building Permit or a Certificate
of Occupancy as the case may be until I provide payment or proof of payment for the
engineering services.

Signature of Applicant: _____

Date: 05/07/2024

Exec. Advisor. KCFPD

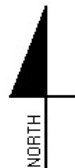


Exhibit 1

Location Map

Lat/Long: 41.646062°, -88.489773°

— Project Study Location



Client: Upland Design
 Project Name: Subat Nature Preserve
 ERA Project #: W23229.00
 Source: Google Maps

Not to Scale




Engineering Resource Associates, Inc.
 3S701 West Avenue, Suite 150
 Warrenville, IL 60555
 Phone: (630) 393-3060 FAX: (630) 393-2152

Warrenville | Chicago | Champaign
www.eraconsultants.com



Exhibit 2
National Wetland Inventory Map
 Lat/Long: 41.646062°, -88.489773°
 — Project Study Location

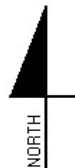

Client: Upland Design
 Project Name: Subat Nature Preserve
 ERA Project #: W23229.00
 Source: USFWS NWI Mapper

Not to Scale




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Exhibit 3
Aerial Photograph
 Lat/Long: 41.646062°, -88.489773°
 — Project Study Location



Client: Upland Design
 Project Name: Subat Nature Preserve
 ERA Project #: W23229.00
 Source: Google Earth

Not to Scale

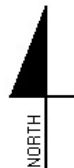

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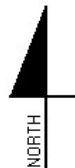


Exhibit 4.1

NRCS Soils Map

Lat/Long: 41.646062°, -88.489773°

 Project Study Location



Client: Upland Design
 Project Name: Subat Nature Preserve
 ERA Project #: W23229.00
 Source: USDA Web Soil Survey

Not to Scale



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Map Unit Legend


Map Unit Symbol	Map Unit Name	Acres in AOI	Percent of AOI
152A	Drummer silty clay loam, 0 to 2 percent slopes	12.5	33.4%
193B	Mayville silt loam, 2 to 5 percent slopes	1.4	3.7%
193C2	Mayville silt loam, 5 to 10 percent slopes, eroded	1.0	2.8%
318D2	Lorenzo loam, 6 to 12 percent slopes, eroded	8.6	23.1%
325A	Dresden silt loam, 0 to 2 percent slopes	5.5	14.7%
325B	Dresden silt loam, 2 to 4 percent slopes	0.8	2.1%
327C2	Fox silt loam, 4 to 6 percent slopes, eroded	4.8	12.9%
820E	Hennepin-Casco complex, 12 to 30 percent slopes	1.1	3.0%
3082A	Millington silt loam, 0 to 2 percent slopes, frequently flooded	1.6	4.3%
Totals for Area of Interest		37.3	100.0%

Exhibit 4.2

NRCS Soils Map

Lat/Long: 41.646062°, -88.489773°

 Project Study Location

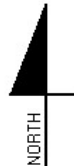

Client: Upland Design
 Project Name: Subat Nature Preserve
 ERA Project #: W23229.00
 Source: USDA Web Soil Survey

Not to Scale




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Exhibit 5
FEMA Flood Insurance Rate Map
 Lat/Long: 41.646062°, -88.489773°
 — Project Study Location



Client: Upland Design
 Project Name: Subat Nature Preserve
 ERA Project #: W23229.00
 Source: FEMA FIRM Viewer

Not to Scale

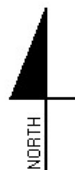

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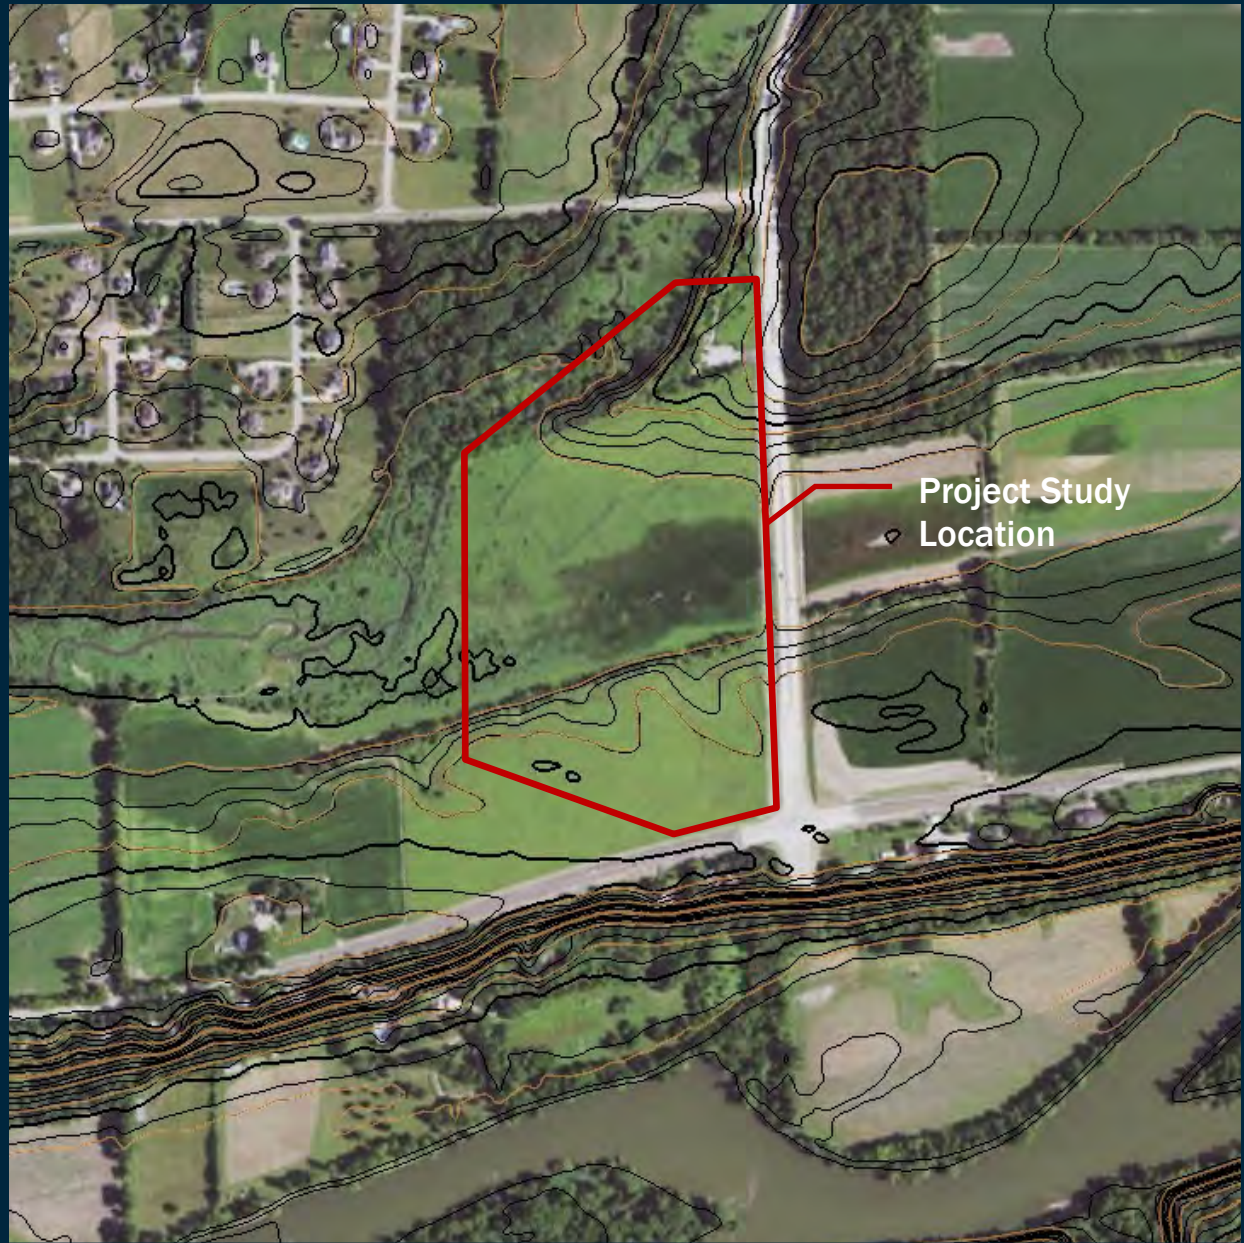
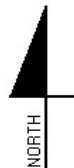


Exhibit 6
USGS Topographic Map
 Lat/Long: 41.646062°, -88.489773°
 — Project Study Location



Client: Upland Design
 Project Name: Subat Nature Preserve
 ERA Project #: W23229.00
 Source: USGS National Map

Not to Scale



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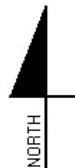


Exhibit 7

Approximate Wetland Boundary

Lat/Long: 41.646062°, -88.489773°

- Approximate Wetland Boundary
- Approximate Offsite Wetlands Boundary
- Project Study Location
- Data Point



Client: Upland Design
 Project Name: Subat Nature Preserve
 ERA Project #: W23229.00
 Source: ESRI


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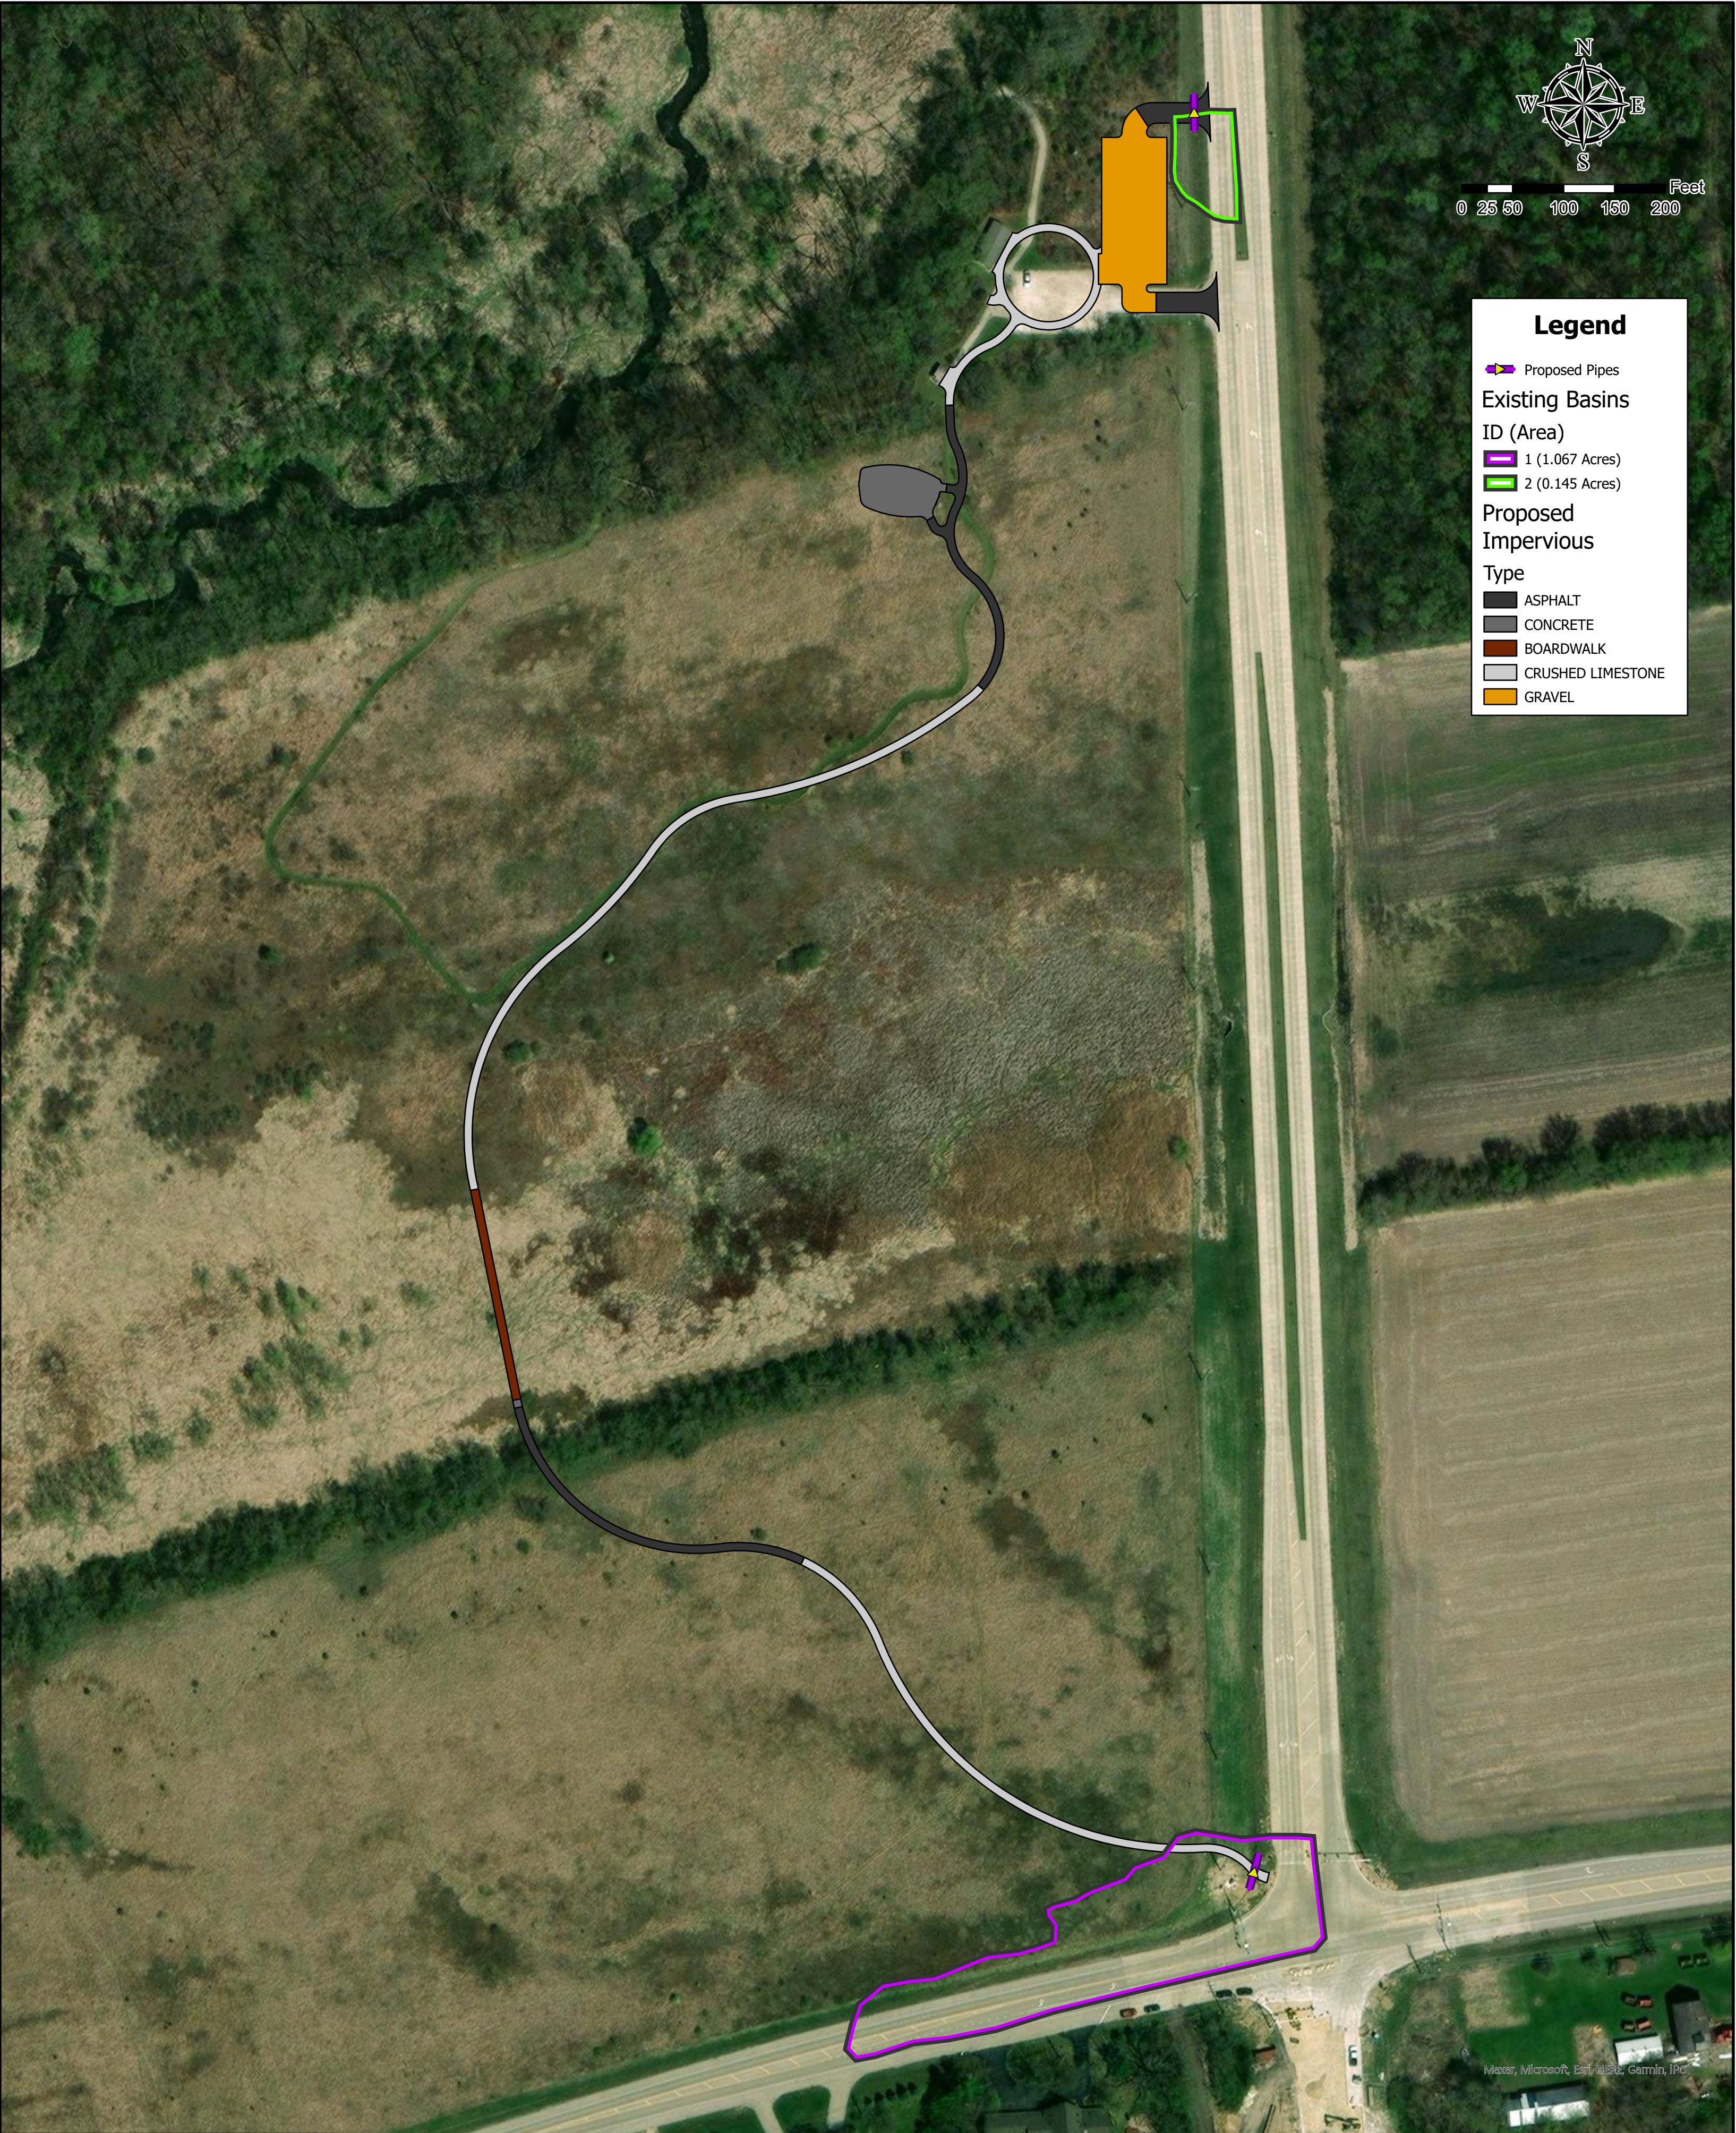
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BASIN 2 (0.145 ACRES)



BASIN 1 (1.067 ACRES)



Legend

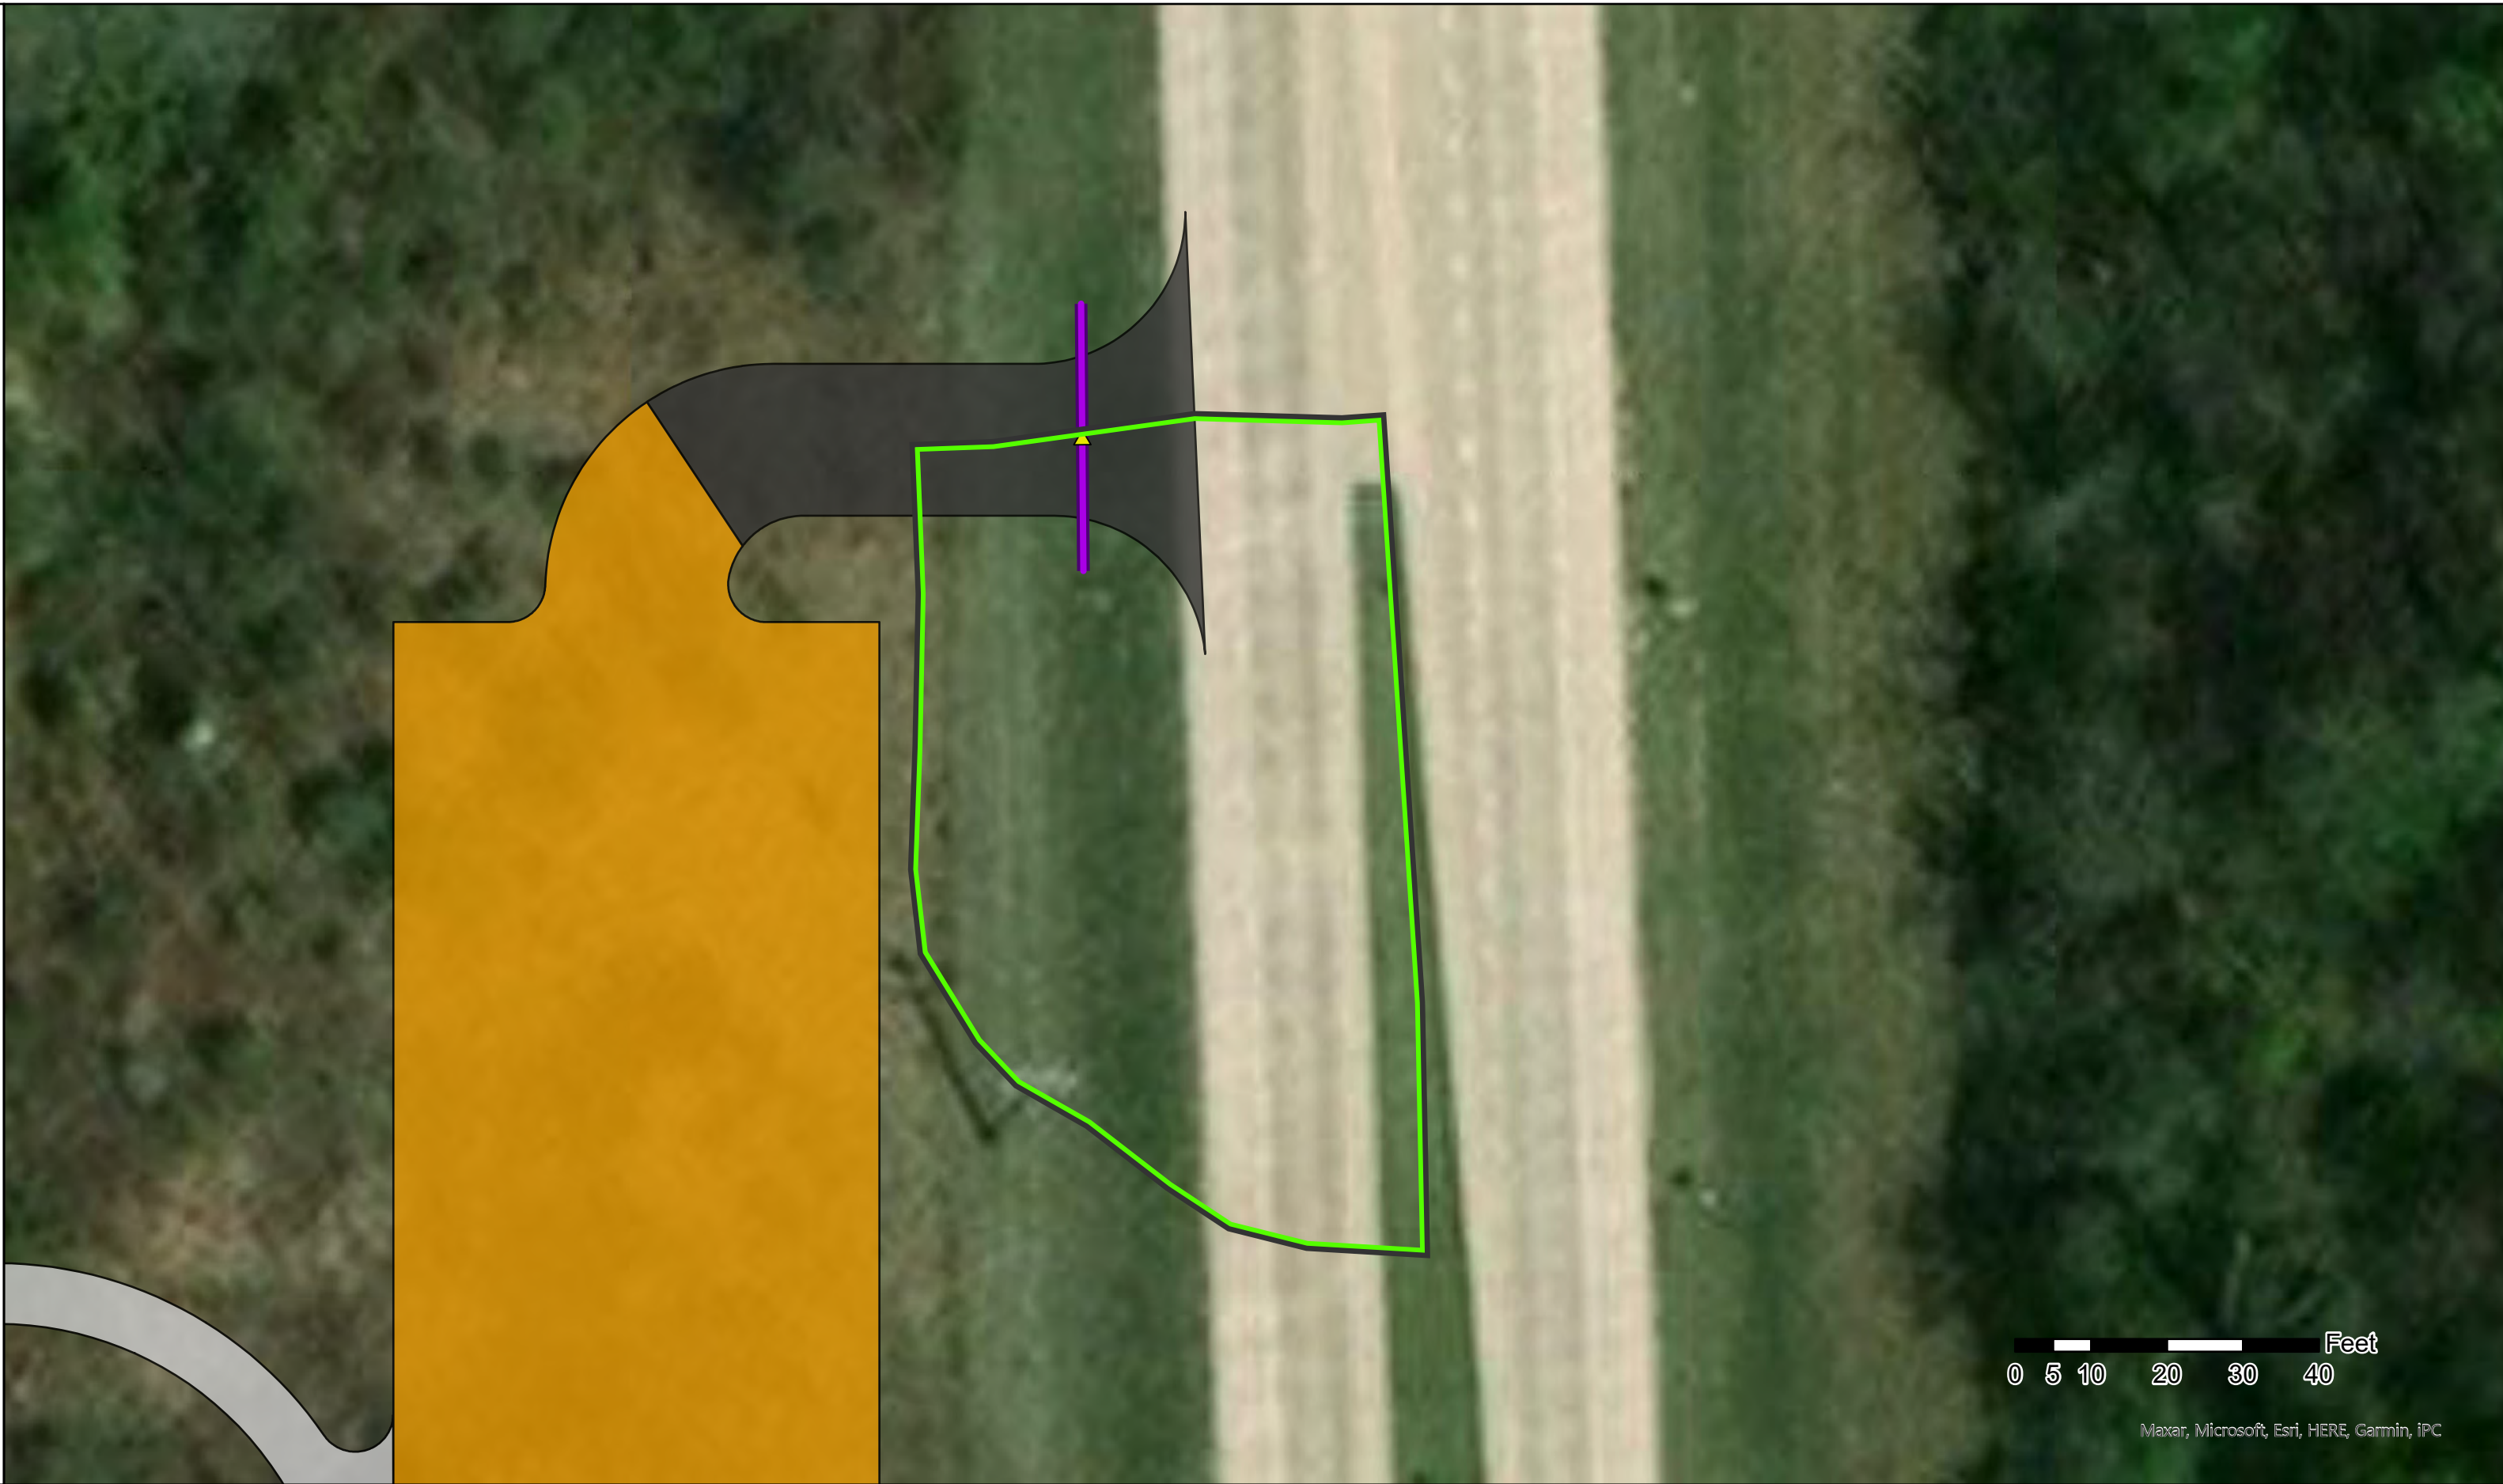Proposed Pipes

Existing Basins
ID (Area)

1 (1.067 Acres)

2 (0.145 Acres)

Proposed
Impervious
Type

ASPHALT

CONCRETE

BOARDWALK

CRUSHED LIMESTONE

GRAVEL

REVISIONS:						DRAWING BY: CF	
DATE	BY	DESCRIPTION	DATE	BY	DESCRIPTION	CHECKED BY: TF	
						APPROVED BY: SG	



35701 WEST AVENUE, SUITE 150
WARRENVILLE, ILLINOIS 60555
PHONE (630) 393-3060
FAX (630) 393-2152

10 S. RIVERSIDE PLAZA, SUITE 875
CHICAGO, ILLINOIS 60606
PHONE (312) 474-7841
FAX (312) 474-6099

2416 GALEN DRIVE
CHAMPAIGN, ILLINOIS 61821
PHONE (217) 351-6268
FAX (217) 355-1902

CLIENT:

UPLAND DESIGN

TITLE:

EXISTING BASINS
SUBAT NATURE PRESERVE

SCALE: 1 IN = 100 FT
DATE: 5/2/2024
PROJECT: W23229.00
SHEET: 1 OF 1

May 14, 2024

Kendall County Department of Planning, Building, & Zoning
111 West Fox Street
Yorkville, Illinois, 60560

**SUBJECT: Subat Nature Center
Kendall County Forest Preserve District
ERA Project #W23229.00
Comments Received May 8, 2024**

ERA submits the following responses to the stormwater management permit application comments received via email on May 8, 2024.

1. Comment: Pursuant to Section 901.4 of the Kendall County Stormwater Management Ordinance, please submit the following materials:
 - a. The common address (if one exists) and legal description(s) of the property.
 - b. The names and addresses of all property owners within 250 feet (PBZ can provide these, but please confirm that the 3 parcel numbers listed are correct).
 - c. The specific provision from which a variance is sought (i.e. the section of the Stormwater Management Ordinance that would be varied).
 - d. A statement that the variance requested is the minimum necessary to permit development.
 - e. Please submit statements explaining how the variance satisfies the standards contained in Section 904.1 of the Kendall County Stormwater Management Ordinance.

Response:

- a. The common address of the forest preserve entrance and parking lot is 4845 Eldamain Road, Plano, IL 60545. A land title survey of the three parcels encompassing the project area is provided as an attachment to this response. Legal descriptions are included in the land title survey document.
- b. A list of names and addresses of all property owners within 250 feet is provided as Attachment 2 (3 pages) to this response.
- c. The applicant seeks a variance from the site runoff storage requirements of Section 203 of the Kendall County Stormwater Management Ordinance.
- d. The variance requested is the minimum necessary to permit the proposed development, as described further in the response to Comment 1.e., below.
- e. The following statements are submitted to address the standards contained in Section 904.1 of the Kendall County Stormwater Management Ordinance (Ordinance):

The project has an impervious area of 36,850 sf. Under current project conditions, the Ordinance requires detention for developments resulting in an impervious area of greater than 32,000 sf. The trail section of the project constitutes 19,930 sf of impervious area or approximately 54% of the total impervious area of the project. The Kendall County Forest Preserve District requests a variance that allows exclusion of the impervious trail sections of the project in the calculation of total impervious improvements, as described below, resulting in no stormwater detention requirement for the project. The Kendall County Forest Preserve District requests a variance from site runoff storage requirements to avoid unnecessary disturbance of restored prairie habitats and native trees that reside within Subat Forest Preserve, as described below.

The variance is not requested solely for the purpose of reducing site runoff storage requirements [904.1(d)]. The variance would preserve valuable environmental and biological resources, including restored prairie habitat, native trees, and existing wetlands [904.1(f)]. The intent of this project is to improve and provide community access to the Subat Forest Preserve without resulting in unnecessary disturbance of valuable on-site natural resources.

ERA looks forward to the County's review of these comment responses. Please contact me with any questions or concerns at 630 393-3060 or jmayer@eraconsultants.com.

Respectfully submitted,
Engineering Resource Associates, Inc.

A black rectangular redaction box covers the signature of John F. Mayer. To the right of the box, the letters "JF" are visible, likely part of the signature.

John F. Mayer, PE, CFM
Project Manager

Attachment 1 – ALTA/NSPS Land Title Survey
Attachment 2 – Properties Within 250' of the Project Area (3 pages)

ALTA/NSPS LAND TITLE SURVEY

SOUTHERLY PARCEL

THAT PART OF THE NORTHEAST QUARTER OF SECTION 36, TOWNSHIP 37 NORTH, RANGE 6 EAST OF THE THIRD PRINCIPAL MERIDIAN, BEING DESCRIBED AS FOLLOWS: COMMENCING AT THE NORTHEAST CORNER OF SAID SECTION 36; THENCE SOUTH 00 DEGREES 00 MINUTES 19 SECONDS WEST ALONG THE EAST LINE OF SAID QUARTER SECTION, 699.00 FEET FOR THE POINT OF BEGINNING; THENCE NORTH 89 DEGREES 49 MINUTES 17 SECONDS WEST, 1279.78 FEET; THENCE SOUTH 00 DEGREES 37 MINUTES 43 SECONDS EAST, 610.73 FEET TO THE CENTERLINE OF RIVER ROAD; THENCE NORTH 75 DEGREES 28 MINUTES 49 SECONDS EAST ALONG SAID CENTERLINE, 1315.05 FEET TO SAID EAST LINE OF SECTION 36; THENCE NORTH 00 DEGREES 00 MINUTES 19 SECONDS EAST ALONG SAID EAST LINE, 277.00 FEET TO THE POINT OF BEGINNING ALL IN THE TOWNSHIP OF LITTLE ROCK, KENDALL COUNTY, ILLINOIS.

NORTHERLY PARCEL

THAT PART OF THE SOUTHEAST QUARTER OF SECTION 25 AND PART OF THE NORTHEAST QUARTER OF SECTION 36, TOWNSHIP 37 NORTH, RANGE 6 EAST OF THE THIRD PRINCIPAL MERIDIAN BY BEING DESCRIBED BY BEGINNING AT THE SOUTHEAST CORNER OF SAID SECTION 25; THENCE NORTH 00 DEGREES 00 MINUTES 39.5 SECONDS WEST ALONG THE EAST LINE OF SAID QUARTER SECTION, 1212.83 FEET TO THE CENTERLINE OF SCHAEFER ROAD; THENCE SOUTH 88 DEGREES 03 MINUTES 05 SECONDS WEST ALONG SAID CENTERLINE, 1285.48 FEET TO THE WEST LINE OF SUB LOT 13 OF SAID SECTION 25 AS SHOWN ON PAGE 36 OF PLAT BOOK 4; THENCE SOUTH 00 DEGREES 02 MINUTES 47 SECONDS WEST ALONG SAID WEST LINE, 1301.73 FEET MORE OR LESS TO A POINT LYING 136.62 FEET SOUTH OF THE NORTH LINE OF SAID SECTION 36, SAID POINT BEING THE SOUTHEAST CORNER OF SUB LOT 2 OF SAID SECTION 36 AS SHOWN ON PAGE 36 OF PLAT BOOK 4; THENCE SOUTH 00 DEGREES 37 MINUTES 43 SECONDS EAST PARALLEL WITH THE EAST LINE OF SAID SUB LOT 3 OF SAID SECTION 36, 562.50 FEET; THENCE SOUTH 89 DEGREES 49 MINUTES 17 SECONDS EAST, 1279.78 FEET TO A POINT ON THE EAST LINE OF SAID SECTION 36; THENCE NORTH 00 DEGREES 00 MINUTES 19 SECONDS EAST ALONG SAID EAST LINE, 699.00 FEET TO THE POINT OF BEGINNING IN THE TOWNSHIP OF LITTLE ROCK, KENDALL COUNTY, ILLINOIS.

SCHAEFER ROAD DEDICATION:

THAT PART OF THE SOUTHEAST QUARTER OF SECTION 25, TOWNSHIP 37 NORTH, RANGE 6 EAST OF THE THIRD PRINCIPAL MERIDIAN IN KENDALL COUNTY, ILLINOIS, DESCRIBED AS FOLLOWS: COMMENCING AT A FOUND IRON ROD AT THE SOUTHEAST CORNER OF SAID SECTION 25 PER MONUMENT RECORD 200900016871; THENCE ON AN ASSUMED BEARING OF NORTH 01 DEGREES 15 MINUTES 34 SECONDS WEST, 35.21 FEET ALONG THE EAST LINE OF SAID SOUTHEAST QUARTER TO THE SOUTHWEST CORNER OF SECTION 30, TOWNSHIP 37 NORTH, RANGE 7 EAST OF THE THIRD PRINCIPAL MERIDIAN; THENCE NORTH 00 DEGREES 51 MINUTES 12 SECONDS WEST, 1,177.55 FEET ALONG SAID EAST LINE TO THE CENTERLINE OF SCHAEFER ROAD AND THE POINT OF BEGINNING; THENCE SOUTH 86 DEGREES 57 MINUTES 58 SECONDS WEST, 395.52 FEET ALONG SAID CENTERLINE AS MONUMENTED; THENCE SOUTH 03 DEGREES 02 MINUTES 02 SECONDS EAST, 30.39 FEET; THENCE SOUTH 89 DEGREES 22 MINUTES 58 SECONDS EAST, 296.17 FEET; THENCE SOUTH 41 DEGREES 00 MINUTES 22 SECONDS EAST, 105.46 FEET TO THE WESTERLY LINE OF ELDA MAIN ROAD; THENCE NORTH 87 DEGREES 25 MINUTES 23 SECONDS EAST, 30.01 FEET TO SAID EAST LINE OF THE SOUTHEAST QUARTER; THENCE NORTH 00 DEGREES 51 MINUTES 12 SECONDS WEST, 132.72 FEET ALONG SAID EAST LINE TO THE POINT OF BEGINNING.


RIVER ROAD DEDICATION:

THAT PART OF THE NORTHEAST QUARTER OF SECTION 36, TOWNSHIP 37 NORTH, RANGE 6 EAST OF THE THIRD PRINCIPAL MERIDIAN IN KENDALL COUNTY, ILLINOIS, DESCRIBED AS FOLLOWS: COMMENCING AT A FOUND IRON ROD AT THE NORTHEAST CORNER OF SAID SECTION 36 PER MONUMENT RECORD 200900016871; THENCE ON AN ASSUMED BEARING OF SOUTH 01 DEGREES 04 MINUTES 12 SECONDS EAST, 976.63 FEET ALONG THE EAST LINE OF SAID NORTHEAST QUARTER TO THE CENTERLINE OF RIVER ROAD AND TO THE POINT OF BEGINNING; THENCE SOUTH 74 DEGREES 24 MINUTES 30 SECONDS WEST, 1314.98 FEET (1,315.05 FEET) ALONG SAID CENTERLINE AS MONUMENTED; THENCE NORTH 01 DEGREES 45 MINUTES 49 SECONDS WEST, 51.33 FEET ALONG THE GRANTOR'S WESTERLY PROPERTY LINE; THENCE NORTH 73 DEGREES 14 MINUTES 27 SECONDS EAST, 105.84 FEET; THENCE NORTH 65 DEGREES 32 MINUTES 27 SECONDS EAST, 105.24 FEET; THENCE NORTH 72 DEGREES 15 MINUTES 44 SECONDS EAST, 295.68 FEET; THENCE NORTH 73 DEGREES 52 MINUTES 48 SECONDS EAST, 302.06 FEET; THENCE NORTH 75 DEGREES 43 MINUTES 45 SECONDS EAST, 242.54 FEET; THENCE NORTH 77 DEGREES 32 MINUTES 47 SECONDS EAST, 203.53 FEET; THENCE NORTH 38 DEGREES 43 MINUTES 34 SECONDS EAST, 57.87 FEET TO THE WESTERLY LINE OF ELDA MAIN ROAD; THENCE NORTH 88 DEGREES 55 MINUTES 48 SECONDS EAST, 27.45 FEET TO SAID EAST LINE OF THE NORTHEAST QUARTER; THENCE SOUTH 01 DEGREES 04 MINUTES 12 SECONDS EAST, 95.29 FEET ALONG SAID EAST LINE TO THE POINT OF BEGINNING.

GENERAL NOTES:

GENERAL NOTES REFERRING PROPERTY SURVEYED:

- 1) THE SURVEYOR HAS NOT RECEIVED A COPY OF TITLE INSURANCE COMPANY COMMITMENT.
- 2) DURING THE PROCESS OF COMPLETING THE SURVEY, WE HAVE NOT FOUND ANY EVIDENCE OF RECENT EARTH WORK OR BUILDING CONSTRUCTION OTHER THAN THE RECENT CONSTRUCTION OF ELDA MAIN ROAD.
- 3) DURING THE PROCESS OF COMPLETING THE SURVEY AND THE PLATTING, I BELIEVE WE HAVE SHOWN ALL EASEMENTS FOR INGRESS AND EGRESS ON AND OFF THE SURVEYED TRACT OF LAND. THE ONLY ALLOWING ACCESS TO THIS PROPERTY IS LOCATED AT THE ENTRANCE OF THE PARKING LOT FOR THE REST AREA AND TRAILS JUST SOUTH OF SCHAEFER ROAD. THE PAVED ACCESS LOCATION HAS BEEN LOCATED AND SHOWN ON THE ATTACHED DRAWING.
- 4) THE LEGAL DESCRIPTIONS HEREON SHOWN ARE THE SAME LEGAL DESCRIPTIONS PROVIDED BY THE KENDALL COUNTY FOREST PRESERVE BASED ON DEEDS OF RECORD.
- 5) THERE IS NO RECORD OF FLOOD ZONES ON THE DESCRIBED PROPERTY ACCORDING TO THE FLOOD INSURANCE RATE MAP AVAILABLE AND DESIGNATED AS 17093C0040G, EFFECTIVE DATE OF 02/04/2009.

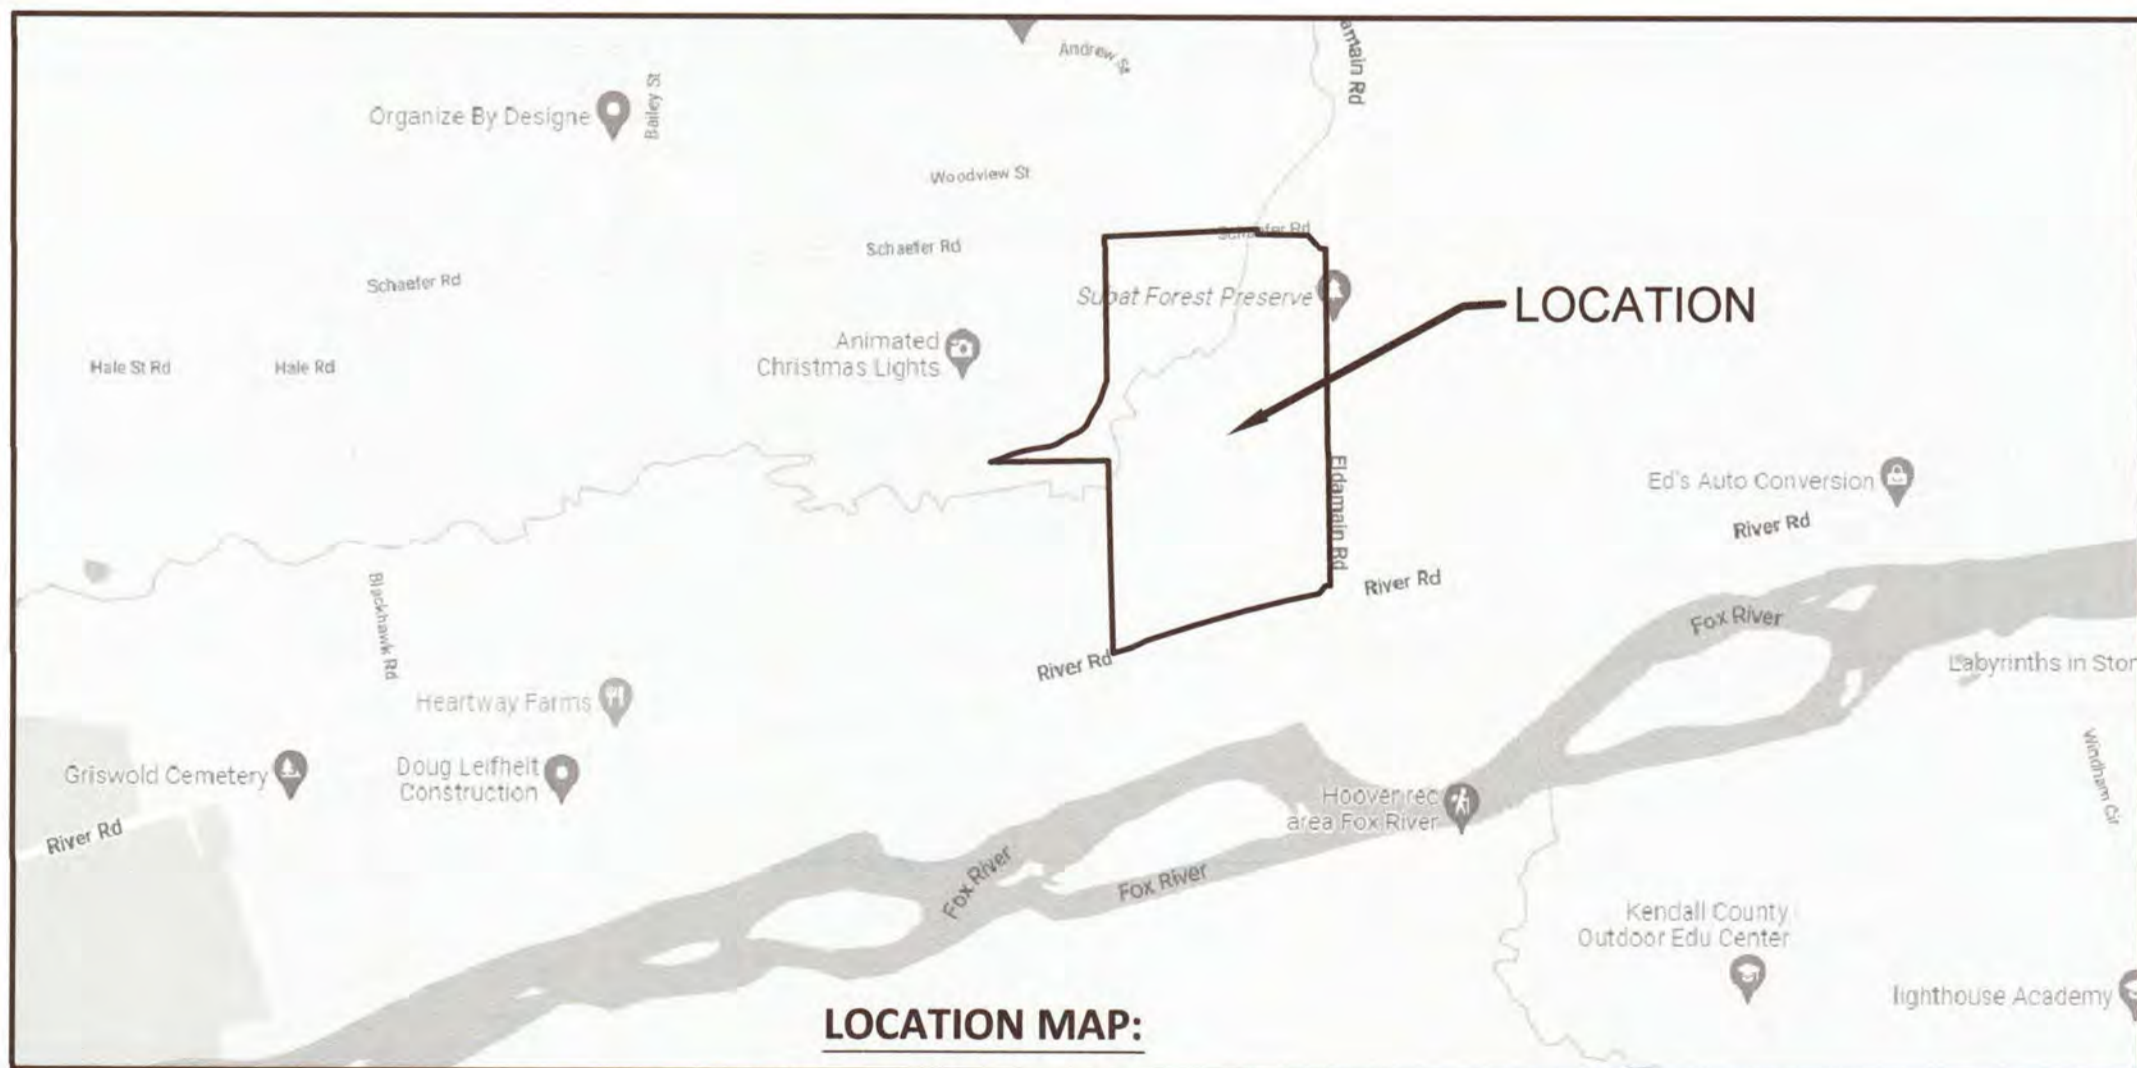

SURVEYOR'S CERTIFICATE

STATE OF ILLINOIS
COUNTY OF KENDALL

TO THE KENDALL COUNTY, ILLINOIS, FOREST PRESERVE DISTRICT.

THIS IS TO CERTIFY THAT THIS MAP OR PLAT AND THE SURVEY ON WHICH IT IS BASED WERE MADE IN ACCORDANCE WITH THE 2021 MINIMUM STANDARD DETAIL REQUIREMENTS FOR ALTA/NSPS LAND TITLE SURVEYS, JOINTLY ESTABLISHED AND ADOPTED BY ALTA AND NSPS, AND INCLUDE ITEMS 1, 2, 3, 4, 7(a), 8, 9, 11(VISIBILITIES), 13, AND 18 OF TABLE A THEREOF. THE FIELD WORK WAS COMPLETED ON THE 16th DAY OF JANUARY, 2023.

THE UNDERSIGNED HAS NOT RECEIVED A COPY OF A TITLE INSURANCE COMPANY'S COMMITMENT POLICY.

GIVEN UNDER MY HAND AND SEAL AT PLANO, ILLINOIS THIS 16th DAY OF JANUARY, 2023 A.D.

RONALD D. BAUER
ILLINOIS PROFESSIONAL LAND SURVEYOR #2352
REGISTRATION EXPIRES 11-30-2024

LEGEND:

- POWER POLE
- POWER POLE WIGWY WIRE
- LIGHT POLE
- SIGN
- FIBER OPTIC BOX
- FOUND IRON
- SET 1/2" IRON PIPE
- FOUND CONC ROW MONUMENT
- SET 1/2" IRON PIPE NEAR FD CONC ROW MONUMENT
- SET CROSS
- TRAFFIC LIGHT POST
- TRAFFIC LIGHT OVER HEAD
- STORM INLET


SCHAEFER ROAD

AREA = 68.10 ACRES

SUBJECT TO 1.437 AC. WITHIN R.O.W.

SUB LOT 13

PT. SUB LOT 1

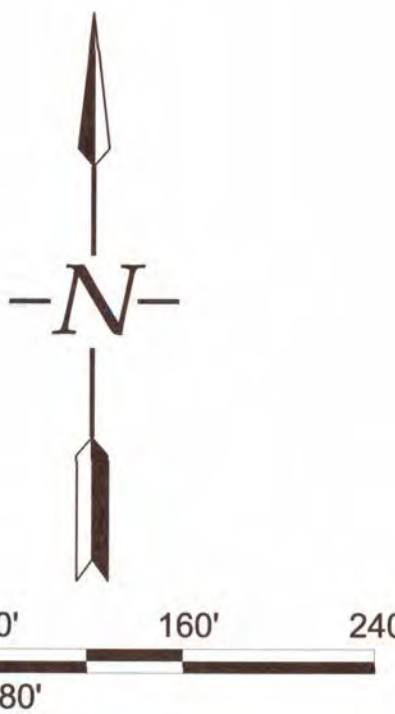

TOWNSHIP LITTLE ROCK BRISTOL

ELDA MAIN ROAD

ELDA MAIN ROAD

FUTURE ELDA MAIN ROAD

RB & ASSOCIATES CONSULTING, INC
4 W MAIN STREET
PLANO, IL 60545
(630) 552-7452

DESIGN FIRM #
184-004475
www.rb-associates.net



May 30, 2024

Mr. Matt Asselmeier
Kendall County Planning, Building, & Zoning
111 West Fox Street
Yorkville, IL 60560-1498

Subject: Subat Nature Center- WBK Project 19-102.CB

Dear Mr. Asselmeier:

We have received and reviewed the following information for the subject project:

- Subat Nature Center Construction Documents prepared by Kluber, Upland and ERA dated April 11, 2024 ad received May 15, 2024.
- Kendall County Comment Response Letter prepared by ERA dated May 14, 2024 and received May 15, 2024.
- Drainage Exhibits prepared by ERA not dated and received May 15, 2024.
- Stormwater Permit Cover Letter, Stormwater Permit and variance support documentation prepared by ERA dated May 7, 2024 and received May 15, 2024.


We have no objection to the issuance of a stormwater variance for this project based on the information submitted. We find the conditions to approve the variance have been met and the project has unique conditions warranting approval of the variance.

Furthermore, we find the stormwater report construction documents submitted to be in general conformance with the County stormwater ordinance. The stormwater permit and construction documents are approved conditioned on resolution of the following comments.

1. Stormwater report – The boardwalk spans a significant drainageway with an upstream area that appears to exceed one square mile. While this is not floodplain please verify the boardwalk will not have an adverse impact on Eldamain Road. (See attached Streamstats Rreport)
2. We have no objections to access to Eldamain Road. Please verify Kendall County Highway Department concurrence.
3. L401 – Verify adequate cover over the 12 “RCP at the northernmost access to Eldamain, Revise as necessary.
4. L501 – The Boardwalk detail depicts the 100 year flood elevation. We concur with the concept presented in the detail. Provide the 100 flow elevation as well as the basis for determining that elevation at the boardwalk.

The applicant's design professionals are responsible for performing and checking all design computations, dimensions, details, and specifications in accordance with all applicable codes and regulations, and obtaining all permits necessary to complete this work. In no way does this review relieve applicant's design professionals of their duties to comply with the law and any applicable codes and regulations, nor does it relieve the Contractors in any way from their sole responsibility for the quality and workmanship of the work and for strict compliance with the permitted plans and specifications. If you have any questions or comments, please contact us at (630) 443-7755.


Sincerely,

A black rectangular redaction box covering the signature of Greg Chismark.

Greg Chismark PE
WBK Engineering, LLC

StreamStats Report

Region ID: IL
Workspace ID: IL20240530210850045000
Clicked Point (Latitude, Longitude): 41.64580, -88.48983
Time: 2024-05-30 16:09:13 -0500

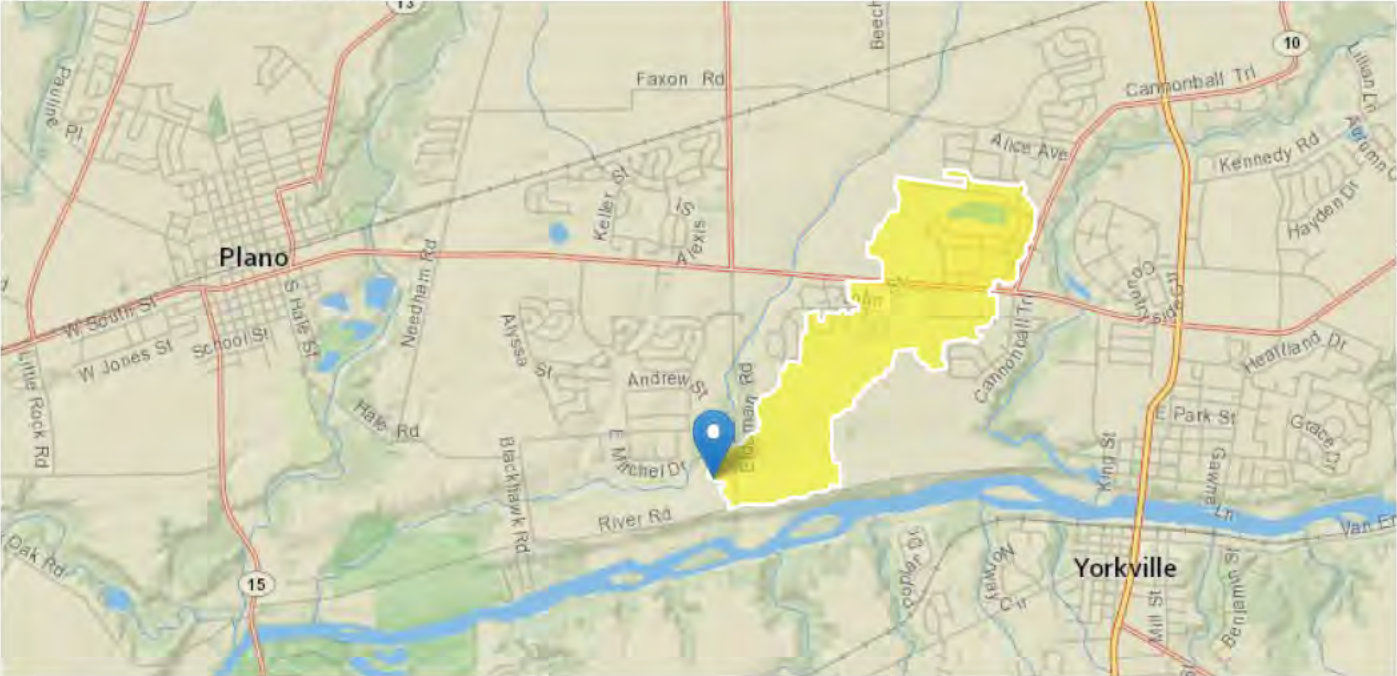

+ Collapse All

Basin Characteristics

Parameter Code	Parameter Description	Value	Unit
DRNAREA	Area that drains to a point on a stream	1.129	square miles
FLC16DVLHM	Fraction of drainage area that is in low to high developed land use classes 22-24 from NLCD 2016	0.3	decimal fraction
FSSURGDC78	Fraction of land area that is in very poorly drained and unknown likely water drainage classes 7 and 8 from SSURGO	0.003	decimal fraction
RELRELF	Basin relief divided by basin perimeter	5.54	feet per mi

➤ Peak-Flow Statistics

Peak-Flow Statistics Parameters [IL Peakflow Region 2 ICT-23-014]

Parameter Code	Parameter Name	Value	Units	Min Limit	Max Limit
DRNAREA	Drainage Area	1.129	square miles	0.07031	1352
FLC16DVLHM	Frac_Lo_Med_Hi_Developed_from_NLCD2016	0.3	decimal fraction	0.002045	0.9692
FSSURGDC78	Fraction_SSURGO_Drainage_Classes_7_and_8	0.003	decimal fraction	0	0.2506
RELRELF	Relative Relief	5.54	feet per mi	0.8122	35.97

Peak-Flow Statistics Flow Report [IL Peakflow Region 2 ICT-23-014]

PIL: Lower 90% Prediction Interval, PIU: Upper 90% Prediction Interval, ASEp: Average Standard Error of Prediction, SE: Standard Error (other -- see report)

Statistic	Value	Unit	PIL	PIU	ASEp
50-percent AEP flood	77.4	ft ³ /s	36.3	165	46.9
20-percent AEP flood	127	ft ³ /s	58.7	275	47.9
10-percent AEP flood	164	ft ³ /s	73.6	365	49.9
4-percent AEP flood	214	ft ³ /s	92.1	497	52.8
2-percent AEP flood	253	ft ³ /s	105	611	55.6
1-percent AEP flood	294	ft ³ /s	118	734	58
0.5-percent AEP flood	335	ft ³ /s	129	867	60.5
0.2-percent AEP flood	392	ft ³ /s	146	1050	63.4

Peak-Flow Statistics Citations

Over, T.M., Marti, M.K., O'Shea, P.S., Sharpe, J.B. 2023, Estimating peak-flow quantiles for selected annual exceedance probabilities in Illinois (Report No. FHWA-ICT-23-014). Illinois Center for Transportation. (<https://doi.org/10.36501/0197-9191/23-019>)

USGS Data Disclaimer: Unless otherwise stated, all data, metadata and related materials are considered to satisfy the quality standards relative to the purpose for which the data were collected. Although these data and associated metadata have been reviewed for accuracy and completeness and approved for release by the U.S. Geological Survey (USGS), no warranty expressed or implied is made regarding the display or utility of the data for other purposes, nor on all computer systems, nor shall the act of distribution constitute any such warranty.

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USGS Product Names Disclaimer: Any use of trade, firm, or product names is for descriptive purposes only and does not imply endorsement by the U.S. Government.

Application Version: 4.20.1

StreamStats Services Version: 1.2.22

NSS Services Version: 2.2.1

ORDINANCE NUMBER 2024 - _____

**GRANTING A VARIANCE TO THE KENDALL COUNTY
STORMWATER MANAGEMENT ORDINANCE FOR THE PROPERTY IDENTIFIED BY
PARCEL IDENTIFICATION NUMBERS 01-25-400-009, 01-36-200-022, AND 01-36-200-025,
LOCATED AT 4845 ELDAMAIN ROAD IN LITTLE ROCK TOWNSHIP AND OWNED BY
THE KENDALL COUNTY FOREST PRESERVE DISTRICT AND ALSO KNOWN AS THE
SUBAT FOREST PRESERVE**

WHEREAS, Section 900 of the Kendall County Stormwater Management Ordinance allows the County to grant variances from strict compliance with specific provisions of said Ordinance when such compliance is impossible or impracticable; and

WHEREAS, Section 906 of the Kendall County Stormwater Management Ordinance allows the County to impose conditions or limitations on the granting of a variance; and

WHEREAS, on or about May 17, 2024, the Kendall County Forest Preserve District submitted an application for a variance to Section 203 of the Kendall County Stormwater Management Ordinance regarding applicability of site runoff storage requirements; and

WHEREAS, the property impacted by the variance, hereinafter referred to as “the subject property” is identified by parcel identification numbers 01-25-400-009, 01-36-200-022, and 01-36-200-025 and is located at 4845 Eldamain Road in Little Rock Township, and is also known as the Subat Forest Preserve; the legal description of the property is attached hereto as Exhibit A; and

WHEREAS, the property is owned by the Kendall County Forest Preserve District and shall hereinafter be referred to as “the Petitioner”; and

WHEREAS, the Petitioner desires to create trail that will create new impervious surface totaling 19,930 square feet which they would like not included in the total development area of 36,850 square feet at the subject property; and

WHEREAS, the proposed development is for public use and the development of the forest preserve is planned, funded and facilitated as a public forest preserve by the Petitioner; and

WHEREAS, the Petitioner desires to protect avoid unnecessary disturbance of restored prairie habitats and native trees that reside within the subject property; and

WHEREAS, following due and proper notice by publication in the Kendall County Record on May 23, 2024, due and proper notification of the United City of Yorkville on May 20, 2024, due and proper notification to the City of Plano on May 20, 2024, due and proper notification to the Village of Sugar Grove on May 20, 2024, and due and proper notification to all of the property owners of record owning property within two hundred fifty feet of the subject property on May 20, 2024, the Kendall County Stormwater Management Oversight Committee conducted a public hearing on June 18, 2024, at 9:00 a.m., in the County Office Building at 111 W. Fox Street in Yorkville, at which the Petitioner’s representatives presented evidence, testimony, and exhibits in support of the requested variance and **zero**

member of the public testified in favor of the request and **zero** members of the public testified in opposition to the request; and

WHEREAS, based on the evidence, testimony, and exhibits, the Kendall County Stormwater Management Oversight Committee has made their Findings of Fact and recommended **approval** of the variance with **conditions** as set forth in the Findings of Fact and Recommendation of the Kendall County Stormwater Management Oversight Committee, dated June 18, 2024, a true and correct copy of which is attached hereto as Exhibit B; and

WHEREAS, this variance shall be treated as a covenant running with the land and is binding on the successors, heirs, and assigns as to the same special use conducted on the property; and

WHEREAS, the Kendall County Board has considered the standards and finds that said petition is in conformance with the provisions and intent of the Kendall County Stormwater Management Ordinance.

NOW, THEREFORE, BE IT ORDAINED, BY THE COUNTY BOARD OF KENDALL COUNTY, ILLINOIS, as follows:

1. The Findings of Fact and Recommendation of the Kendall County Stormwater Management Oversight Committee attached hereto as Exhibit B is hereby accepted and the Findings of Fact set forth therein are hereby adopted as the Findings of Fact and Conclusions of this Kendall County Board.
2. The Kendall County Board hereby grants approval of the Petitioner's petition for a variance to Section 203 of the Kendall County Stormwater Management Ordinance regarding applicability of site runoff storage requirements subject to the following conditions:
 - A. The site shall be developed substantially in accordance with the attached site plan, attached hereto as Exhibit C.
 - B. The property owner shall follow all applicable Federal, State, and Local laws related to the development of this property as a forest preserve.
 - C. Failure to comply with one or more of the above conditions or restrictions could result in the amendment or revocation of this variance
 - D. If one or more of the above conditions is declared invalid by a court of competent jurisdiction, the remaining conditions shall remain valid.

IN WITNESS OF, this Ordinance has been enacted by majority vote of the Kendall County Board this 18th day of June, 2024.

State of Illinois
County of Kendall

Petition 24-15

Attest:

Debbie Gillette
Kendall County Clerk

Matt Kellogg
Kendall County Board Chairman

EXHIBIT A:
SUBAT FOREST PRESERVE LEGAL DESCRIPTION
KENDALL COUNTY FOREST PRESERVE DISTRICT, KENDALL COUNTY, ILLINOIS

SOUTHERLY PARCEL

THAT PART OF THE NORTHEAST QUARTER OF SECTION 36, TOWNSHIP 37 NORTH, RANGE 6 EAST OF THE THIRD PRINCIPAL MERIDIAN, BEING DESCRIBED AS FOLLOWS: COMMENCING AT THE NORTHEAST CORNER OF SAID SECTION 36; THENCE SOUTH 00 DEGREES 00 MINUTES 19 SECONDS WEST ALONG THE EAST LINE OF SAID QUARTER SECTION, 699.00 FEET FOR THE POINT OF BEGINNING; THENCE NORTH 89 DEGREES 49 MINUTES 17 SECONDS WEST, 1279.78 FEET; THENCE SOUTH 00 DEGREES 37 MINUTES 43 SECONDS EAST, 610.73 FEET TO THE CENTERLINE OF RIVER ROAD; THENCE NORTH 75 DEGREES 28 MINUTES 49 SECONDS EAST ALONG SAID CENTERLINE, 1315.05 FEET TO SAID EAST LINE OF SECTION 36; THENCE NORTH 00 DEGREES 00 MINUTES 19 SECONDS EAST ALONG SAID EAST LINE, 277.00 FEET TO THE POINT OF BEGINNING ALL IN THE TOWNSHIP OF LITTLE ROCK, KENDALL COUNTY, ILLINOIS.

NORTHERLY PARCEL

THAT PART OF THE SOUTHEAST QUARTER OF SECTION 25 AND PART OF THE NORTHEAST QUARTER OF SECTION 36, TOWNSHIP 37 NORTH, RANGE 6 EAST OF THE THIRD PRINCIPAL MERIDIAN BY BEING DESCRIBED BY BEGINNING AT THE SOUTHEAST CORNER OF SAID SECTION 25; THENCE NORTH 00 DEGREES 00 MINUTES 39.5 SECONDS WEST ALONG THE EAST LINE OF SAID QUARTER SECTION, 1212.83 FEET TO THE CENTERLINE OF SCHAEFER ROAD; THENCE SOUTH 88 DEGREES 03 MINUTES 05 SECONDS WEST ALONG SAID CENTERLINE, 1285.48 FEET TO THE WEST LINE OF SUB LOT 13 OF SAID SECTION 25 AS SHOWN ON PAGE 36 OF PLAT BOOK 4; THENCE SOUTH 00 DEGREES 02 MINUTES 47 SECONDS WEST ALONG SAID WEST LINE, 1301.73 FEET MORE OR LESS TO A POINT LYING 136.62 FEET SOUTH OF THE NORTH LINE OF SAID SECTION 36, SAID POINT BEING THE SOUTHEAST CORNER OF SUB LOT 2 OF SAID SECTION 36 AS SHOWN ON PAGE 36 OF PLAT BOOK 4; THENCE SOUTH 00 DEGREES 37 MINUTES 43 SECONDS EAST PARALLEL WITH THE EAST LINE OF SAID SUB LOT 3 OF SAID SECTION 36, 562.50 FEET; THENCE SOUTH 89 DEGREES 49 MINUTES 17 SECONDS EAST, 1279.78 FEET TO A POINT ON THE EAST LINE OF SAID SECTION 36; THENCE NORTH 00 DEGREES 00 MINUTES 19 SECONDS EAST ALONG SAID EAST LINE, 699.00 FEET TO THE POINT OF BEGINNING IN THE TOWNSHIP OF LITTLE ROCK, KENDALL COUNTY, ILLINOIS.

Exhibit B

The Kendall Stormwater Management Planning Committee approved the following Findings of Fact and Recommendation at their meeting on June 18, 2024, by a vote of ten (10) in favor and zero (0) in opposition.

FINDINGS OF FACT

The variance will not increase the probability of flood damage or create an additional threat to the public health, safety or welfare.

The variance requested is the minimum relief necessary to accomplish the objectives of the development without compromising the objectives of Section 102 of the Kendall Stormwater Management Ordinance.

The variance will not result in a reduction of water quality benefits as compared to compliance with ordinance requirements.

The variance is not requested solely for the purpose of reducing site runoff storage requirements.

The variance shall not cause conveyance of stormwater from the project to increase peak discharges beyond design capacity of existing offsite conveyance facilities for any storm event from the 2-year to the 100-year recurrence frequency.

RECOMMENDATION

Approval with the following conditions and restrictions:

1. The site shall be developed substantially in accordance with the submitted site plan.
2. The property owner shall follow all applicable Federal, State, and Local laws related to the development of this property as a forest preserve.
3. Failure to comply with one or more of the above conditions or restrictions could result in the amendment or revocation of this variance.
4. If one or more of the above conditions is declared invalid by a court of competent jurisdiction, the remaining conditions shall remain valid.

GENERAL NOTES			DETAIL CALLOUT DETAIL NUMBER DRAWING NUMBER		8 A1224															
ALL CONSTRUCTION SHALL BE IN ACCORDANCE WITH THE REQUIREMENTS SET FORTH BY IBC 2018 EDITION AND SHALL CONFORM TO ALL OTHER APPLICABLE MUNICIPAL, STATE, AND FEDERAL REGULATIONS INCLUDING THE ILLINOIS ACCESSIBILITY CODE (2018) AND THE AMERICANS WITH DISABILITIES ACT.			EXTERIOR ELEVATION ELEVATION NUMBER DRAWING NUMBER		23 A719															
A. GENERAL NOTES			INTERIOR ELEVATION ELEVATION NUMBER DRAWING NUMBER		2 A916 5															
1. ALL CONTRACTORS ARE REQUIRED TO VISIT THE SITE AND BE KNOWLEDGEABLE REGARDING EXISTING CONDITIONS AND THEIR EFFECT ON THE PROPOSED WORK. CONTRACTORS SHALL VERIFY AND BE RESPONSIBLE FOR, ANY CONDITIONS REQUIRING MODIFICATION BEFORE PROCEEDING WITH THE PROJECT.			SECTION REFERENCE SECTION NUMBER DRAWING NUMBER		1 A605															
2. NOTIFY THE OWNER'S REPRESENTATIVE A MINIMUM OF 72 HOURS PRIOR TO THE INTERRUPTION OF ANY UTILITY.			COLUMN NO.		26															
3. PROTECT AND KEEP IN SERVICE ACTIVE UNDERGROUND UTILITIES, PIPES, OR CONDUITS, WHETHER INDICATED ON THE DRAWINGS OR NOT, UNLESS SPECIFICALLY CALLED FOR TO BE REMOVED, RELOCATED, OR DISCONNECTED AND ABANDONED.			REFERENCE LINE NO.		26															
4. CONTRACTORS AND SUBCONTRACTORS SHALL COORDINATE THEIR WORK WITH THAT OF OTHER TRADES.			LOCATION ELEVATION		1/1ST FLR. 100'-0"															
5. NO WORK WILL BE PERMITTED TO BE INSTALLED WITHOUT RECEIPT AND SUBSEQUENT REVIEW OF FULL AND COMPLETE SUBMITTALS BY THE ARCHITECT/ENGINEER.			ROOM NUMBER		204															
6. DO NOT SCALE DRAWINGS, DIMENSIONS INDICATED TAKE PRECEDENCE OVER SCALE.			DOOR NO. NEW DOOR NO. EXISTING		203.2 203.1X															
7. VERIFY ALL DIMENSIONS AND ELEVATIONS IN THE FIELD. WHERE DISCREPANCIES ARE FOUND BETWEEN DIMENSIONS OR ELEVATIONS SHOWN AND ACTUAL FIELD CONDITIONS, NOTIFY ARCHITECT/ENGINEER.			NOMINAL THICKNESS CONSTRUCTION TYPE SPECIAL CONDITION		480															
8. WHERE CONFLICTS MAY EXIST BETWEEN THE REQUIREMENTS OF PORTIONS OF THE CONTRACT DOCUMENTS, THE GREATER QUANTITY, HIGHER QUALITY OR MORE STRINGENT REQUIREMENT SHALL GOVERN. THEREFORE, BY EXECUTING A CONTRACT FOR CONSTRUCTION, THE CONTRACTOR AGREES THAT, IF IT RAISED NO QUESTIONS REGARDING SUCH CONFLICTS DURING THE BIDDING PROCESS, AND IN THE ABSENCE OF A CLARIFYING ADDENDUM ISSUED DURING THE BIDDING PROCESS, IT HAS VOLUNTEERED TO COMPLY WITH THE MORE EXPENSIVE REQUIREMENT AS PART OF ITS BASE BID AND IS NOT ENTITLED TO ANY ADDITIONAL COMPENSATION TO RESOLVE THE CONFLICT.			KEYNOTE IDENTIFICATION		7.531															
9. THE CONTRACT DOCUMENTS REQUIRE THE CONTRACTOR TO FURNISH AND INSTALL COMPLETE PRODUCTS, SYSTEMS AND SERVICES. BY EXECUTING A CONTRACT FOR CONSTRUCTION, THE CONTRACTOR AGREES THAT THE DRAWINGS SET FORTH THE DESIGN INTENT AND, THEREFORE, MAY NOT EXPRESSLY DEPICT EVERY LENGTH, SEGMENT, PIECE, PART, COMPONENT OR UNIT OF A PRODUCT, SYSTEM OR SERVICE. THE CONTRACTOR FURTHER AGREES THAT, AS PART OF ITS BID, IT MUST FURNISH AND INSTALL EVERY LENGTH, SEGMENT, PIECE, PART, COMPONENT OR UNIT OF A PRODUCT, SYSTEM OR SERVICE AND, CONSEQUENTLY, THE CONTRACTOR IS NOT ENTITLED TO ANY ADDITIONAL COMPENSATION FOR ANY LENGTH, SEGMENT, PIECE, PART COMPONENT OR UNIT OF A PRODUCT, SYSTEM OR SERVICE BECAUSE IT IS NOT EXPRESSLY DEPICTED HEREIN.			WINDOW TYPE IDENTIFICATION		X															
10. THE CONTRACT DOCUMENTS REQUIRE THE CONTRACTOR TO INSTALL A CONTINUOUS AIR BARRIER THROUGHOUT THE BUILDING ENVELOPE, IN COMPLIANCE WITH THE 2018 INTERNATIONAL ENERGY CONSERVATION CODE (IECC), SECTION C402.5 - AIR LEAKAGE. CONTRACTOR AND ITS SUBCONTRACTORS AGREE TO BE JOINTLY AND SEPARATELY RESPONSIBLE FOR COORDINATING AND VERIFYING THAT ALL SOURCES OF AIR LEAKAGE IN THE BUILDING THERMAL ENVELOPE ARE CAULKED, GASKETED, WEATHER STRIPPED, OR OTHERWISE APPROPRIATELY SEALED AIR-TIGHT USING CODE-COMPLIANT ALTERNATIVES AS APPROPRIATE FOR EACH MATERIAL AND CONDITION/LOCATION. PROVIDE AIR BARRIER MATERIALS HAVING AN AIR PERMEABILITY NO GREATER THAN 0.004 cm ³ /ft ² (L/gm ²) UNDER PRESSURE DIFFERENTIAL OF 0.3 INCHES WATER GAUGE (75 Pa) WHEN TESTED IN ACCORDANCE WITH ASTM E2178, AND COMPLY WITH IECC 2018 SECTION C402.5.1.2.1 - MATERIALS.			TOILET ACCESSORY IDENTIFICATION		A															
STANDARD ABBREVIATIONS			SPOT ELEVATION		1/1ST FLR. 100'-0"															
© A B ABR ACOP ACT AFF AFG ACOU ADDN ADDL ADJ AL ALT ANCHR AP APPROX ASPH AUTO AVG BSMT B/ BD BET BIT BLDG BLKG BM B.M. BRG BRKT BRK BT STL PL CJ CAB CEM PL-(1) CT PAV-(1) CIP CLG CLR C.O. CMU COL COMB CONC CONC OPNG COND CONT CONTR CPT-(1) CT-(1) CTR CTR SK CTRS CUH CUV DIA DIM DN DO DR DWGS DTL DWL'S EA EJ EL ELEC ELEC CONTR ELEV EMBED EMER EP EQ EW EW			AT ANCHOR BOLT ABRASIVE ACOUSTICAL CEILING PANEL ACOUSTICAL CEILING TILE ABOVE FINISH FLOOR ABOVE FINISH GRADE ACOUSTIC ADDITION ADDITIONAL ADJACENT OR ADJUSTABLE ALUMINUM ALTERNATE ANCHOR ACCESS PANEL APPROXIMATE ASPHALT AUTOMATIC AVERAGE BASEMENT BOTTOM OF BOARD BETWEEN BITUMINOUS BUILDING BLOCKING (WOOD) BEAM BENCH MARK BEARING BRACKET BRICK BENT STEEL PLATE CONSTRUCTION OR CONTRACTION JOINT CABINET CEMENT PLASTER (TYPE) CERAMIC PAVER TILE (TYPE) CAST-IN-PLACE CEILING CLEAR CLEAN-OUT CONCRETE MASONRY UNIT COLUMN COMBINATION COMPRESSIBLE OR COMPACTED CONCRETE CONCRETE OPENING CONDITION CONTINUOUS CONTRACT(OR) CARPET (TYPE) CERAMIC TILE (TYPE) COUNTER COUNTER SINK CENTER(S) CABINET UNIT HEATER CABINET UNIT VENTILATOR DIAMETER DIMENSION DOWN DOOR OPENING DOOR DRAWINGS DETAIL DOWELS EACH EXPANSION JOINT ELEVATION ELECTRIC/ELECTRICAL ELECTRICAL CONTRACTOR ELEVATOR OR ELEVATION EMBEDMENT EMERGENCY EPOXY EQUAL EACH WAY ELECTRIC WATER COOLER			EWH EXIST EXP EXP CONST FD FDN FNDN FE FEC FHC FIN FLR FRT FUR CHN'L FTG GA GALV GEN CONTR GC GL GYP BD-(1) GYP PL-(1) H HD HDNR HD WD-(1) HDWR HT HM HP HORIZ HTG HVAC IN ID INCL INSUL JT KD L LAM LAV LH LP LT WT LL LLH LLV LVR MO MT MAS MATL MAX MB (16) MECH MECH CONTR MFR MIN MISC MSB MT(D) MTL NIC NOM NTS NO OA OC OD OF OPNG OPP PSF PS PT			ELECTRIC WATER HEATER EXISTING EXPANSION EXPOSED CONSTRUCTION FLOOR DRAIN FOUNDATION FOUNDATION FIRE EXTINGUISHER FIRE EXTINGUISHER CABINET FIRE HOSE CABINET FINISH FLOOR FIRE RETARDANT TREATED FURRING CHANNEL FOOTING GAUGE GALVANIZED GENERAL CONTRACTOR GENERAL CONTRACTOR GLASS GYPSUM WALL BOARD (TYPE) GYPSUM PLASTER (TYPE) HIGH HEAVY DUTY OR HARD HARDENER HARD WOOD (TYPE) HARDWARE HEIGHT HOLLOW METAL HIGH POINT HORIZONTAL HEATING HEATING/VENTILATING/AIR CONDITIONING INSIDE DIAMETER INCLUDE/INCLUDING/INCLUDED INSULATION/INSULATING/INSULATED JOINT KNOCK DOWN LONG LAMINATE/LAMINATING/LAMINATED LAVATORY LEFT HAND LOW POINT LIGHTWEIGHT LIVE LOAD LONG LEG HORIZONTAL LONG LEG VERTICAL LOUVER MASONRY OPENING METAL THRESHOLD MASONRY MATERIAL MAXIMUM MARKERBOARD (LENGTH IN FEET) MECHANICAL MECHANICAL CONTRACTOR MANUFACTURER MINIMUM OR MINUTE(S) MISCELLANEOUS MOP SERVICE BASIN (SINK) MOUNT(ED) METAL NOT IN CONTRACT NOMINAL NOT TO SCALE NUMBER OVERALL OR OUTSIDE AIR ON CENTER OUTSIDE DIAMETER OUTSIDE FACE OR OPPOSITE FACE OPENING OPPOSITE OR OPPOSITE HAND POUNDS PER SQUARE FOOT POUNDS PER SQUARE INCH PRESSURE TREATED OR PAINT			PTN PVMT PC PL PLAM PL PLB'G PLB'G CONTR PLYWD PNT PO PVC PL-(1) R R OR RAD RD RO RF (1) RH REF REINF REQ'D RM SF SI SK SS SSK SQ SCHED SEAL/HARDENER SEC SHT SIM SOG SPEC(S) SPC'G SPK'R STD STD WT STL STRUCT SUSP SYM T T&G T/BEAM T/BEAM T/C T/FDN T/STL T/WALL TB (4) T/MAS TYP UD UNO VBC VBS VCT VEN PL (1) VERT W W/ W/O WCG WD WDW WT WP WWF WSB			PARTITION PAVEMENT PIECE PLATE PLASTIC LAMINATE(D) PLASTER PLUMBING PLUMBING CONTRACTOR PLYWOOD PAINT PRECAST (CONCRETE) OPENING POLYVINYL CHLORIDE GYPSUM PLASTER (TYPE) RISER RADIUS ROOF DRAIN ROUGH OPENING RUBBER FLOORING (TYPE) RIGHT HAND REFERENCE REINFORCE/REINFORCING/REINFORCED REQUIRED ROOM SQUARE FOOT SQUARE INCH SINK STAINLESS STEEL SERVICE SINK SQUARE SCHEDULE SEALER/HARDENER SECTION SHEET SIMILAR SLAB ON GRADE SPECIFICATION(S) SPACING SPEAKER STANDARD STANDARD WEIGHT STEEL STRUCTURE OR STRUCTURAL SUSPEND(ED) SYMMETRICAL TREAD TONGUE AND GROOVE TOP OF TOP OF BEAM TOP OF CURB TOP OF FOUNDATION TOP OF STEEL TOP OF WALL TACKBOARD (LENGTH IN FEET) TOP OF MASONRY TYPICAL (WINDOW) UNIT DIMENSION UNLESS NOTED OTHERWISE VINYL BASE COVERED VINYL BASE STRAIGHT VINYL COMPOSITION TILE VENEER PLASTER (TYPE) VERTICAL WIDE OR WIDTH WITH WITHOUT WALL CORNER GUARD WOOD WINDOW WEIGHT WATER PROOF WELDED WIRE FABRIC WALL SERVICE BASIN			FIRE-RATING 1-HOUR 2-HOUR CONCRETE BRICK MASONRY IN PLAN CONCRETE MASONRY IN PLAN (RUNNING BOND) CONCRETE MASONRY IN PLAN (STACK BOND) STONE MASONRY IN PLAN RAKED JOINT IN PLAN CTRL./EXP. JOINT IN PLAN BRICK MASONRY IN SECTION DETAIL CONCRETE MASONRY IN SECTION DETAIL STONE MASONRY IN SECTION DETAIL STEEL IN SECTION DETAIL DISCONTINUOUS ROUGH WOOD BLOCKING IN SECTION CONTINUOUS ROUGH WOOD FRAMING/BLOCKING IN SECTION FINISHED WOOD IN SECTION DETAIL RIGID BOARD INSULATION BATT INSULATION GYPSUM BOARD ACOUSTICAL CEILING PANEL BITUMINOUS CONCRETE (ASPHALT) PAVING IN SECTION AGGREGATE BALLAST, FILL OR BACKFILL IN SECTION UNDISTURBED EARTH EARTH BACKFILL		
THE MATERIALS, ABBREVIATIONS, AND DRAFTING SYMBOLS LEGEND ARE EACH AN ALL INCLUSIVE MASTER LIST USED BY THIS FIRM. THE INCLUSION OF THESE LEGENDS INTO THESE DOCUMENTS DOES NOT IMPLY THAT ALL THE SYMBOLS OR MATERIALS INCLUDED IN THESE LEGENDS ARE INCORPORATED INTO THIS PROJECT. ABBREVIATIONS MAY APPEAR WITH PERIODS OR OTHER PUNCTUATION SEPARATING CHARACTERS ON THE DRAWINGS; THE MEANING REMAINS THE SAME.			PROJECT																	
OWNER			SUBAT NATURE CENTER ELDAMAIN RD. PLANO, IL 60545																	
ARCHITECT/ ENGINEER			KENDALL COUNTY FOREST PRESERVE 110 W MADISON ST YORKVILLE, IL 60560																	
REQUIRED CODE COMPLIANCE INFORMATION			KLUBER ARCHITECTS + ENGINEERS 41 W BENTON STREET AURORA, ILLINOIS 60506 TEL (630) 406-1213 FAX (630) 406-9472 www.kluberinc.com																	
APPLICABLE CODES			2018 INTERNATIONAL BUILDING CODE 2018 INTERNATIONAL MECHANICAL CODE 2018 INTERNATIONAL FUEL AND GAS CODE 2006 INTERNATIONAL FIRE CODE 2017 NATIONAL ELECTRICAL CODE LOCAL AMENDMENTS TO THE ABOVE CODES 2014 ILLINOIS PLUMBING CODE 2021 ILLINOIS ENERGY CONSERVATION CODE (2021 INTERNATIONAL ENERGY CONSERVATION CODE W/STATE AMENDMENTS) 2018 ILLINOIS ACCESSIBILITY CODE																	
SEALS & CERTIFICATIONS			I HAVE PREPARED, OR CAUSED TO BE PREPARED UNDER MY DIRECT SUPERVISION, THE ATTACHED PLANS AND SPECIFICATIONS AND STATE THAT TO THE BEST OF MY KNOWLEDGE AND BELIEF, AND TO THE EXTENT OF MY CONTRACTUAL OBLIGATION, THEY ARE IN COMPLIANCE WITH IBC 2018 EDITION, THE ENVIRONMENTAL BARRIERS ACT AND THE ILLINOIS ACCESSIBILITY CODE. KLUBER, INC. ILLINOIS PROFESSIONAL DESIGN FIRM LICENSE #184-001284																	
ISSUED DATE OWNER REVIEW DATE BID DOCUMENTS			ARCHITECT'S SEAL LICENSED ARCHITECT CHRISTOPHER J. HANSEN STATE OF ILLINOIS expires 11-30-20 24 signature April 11, 2024 date "G" SERIES, "A" SERIES																	
JOB NO. 23-429-1495 DRAWN SKF CHECKED CJH APPROVED CJH SHEET TITLE COVER SHEET, GENERAL NOTES, SYMBOLS AND DRAWING INDEX SHEET NUMBER			CIVIL ENGINEER'S SEAL JOHN F. MAHER REGISTERED PROFESSIONAL ENGINEER OF STATE OF ILLINOIS EXPIRES 11/30/25 signature April 11, 2024 date "G" SERIES, "L" SERIES																	
STRUCTURAL ENGINEER'S SEAL JEFFREY M. BRUNS REGISTERED PROFESSIONAL ENGINEER OF STATE OF ILLINOIS EXPIRES 11-30-20 24 signature April 11, 2024 date "G" SERIES, "S" SERIES			G100																	

KLUBER

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SUBAT NATURE CENTER

KENDALL COUNTY FOREST PRESERVE DISTRICT

4675 ELDAMAIN ROAD

PLANO, IL 60545

ISSUED

DATE

OWNER REVIEW

DATE

BID DOCUMENTS

23-429-1495

SKF


CJH

CJH

COVER SHEET, GENERAL NOTES, SYMBOLS AND DRAWING INDEX

G100

NOTE: SCALES DEPICTED ON THIS DRAWING ARE NOT CORRECT UNLESS PLOTTED SHEET SIZE IS 30 X 42 INCHES.

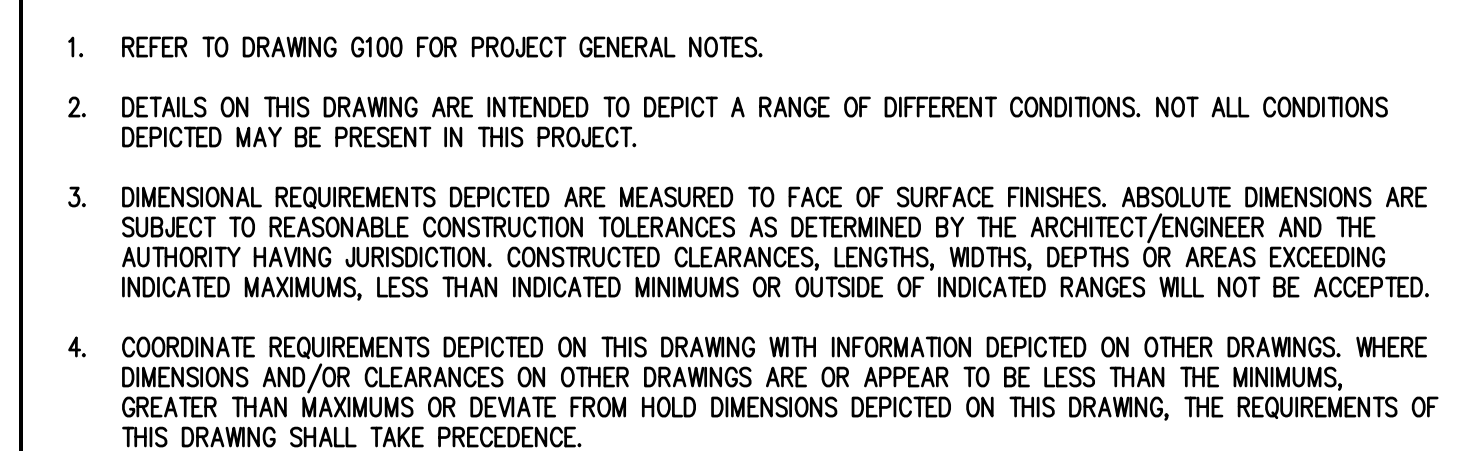


JOB NO.	23-429-1495
DRAWN	SKF
CHECKED	CDH
APPROVED	CJH

SHEET NUMBER	
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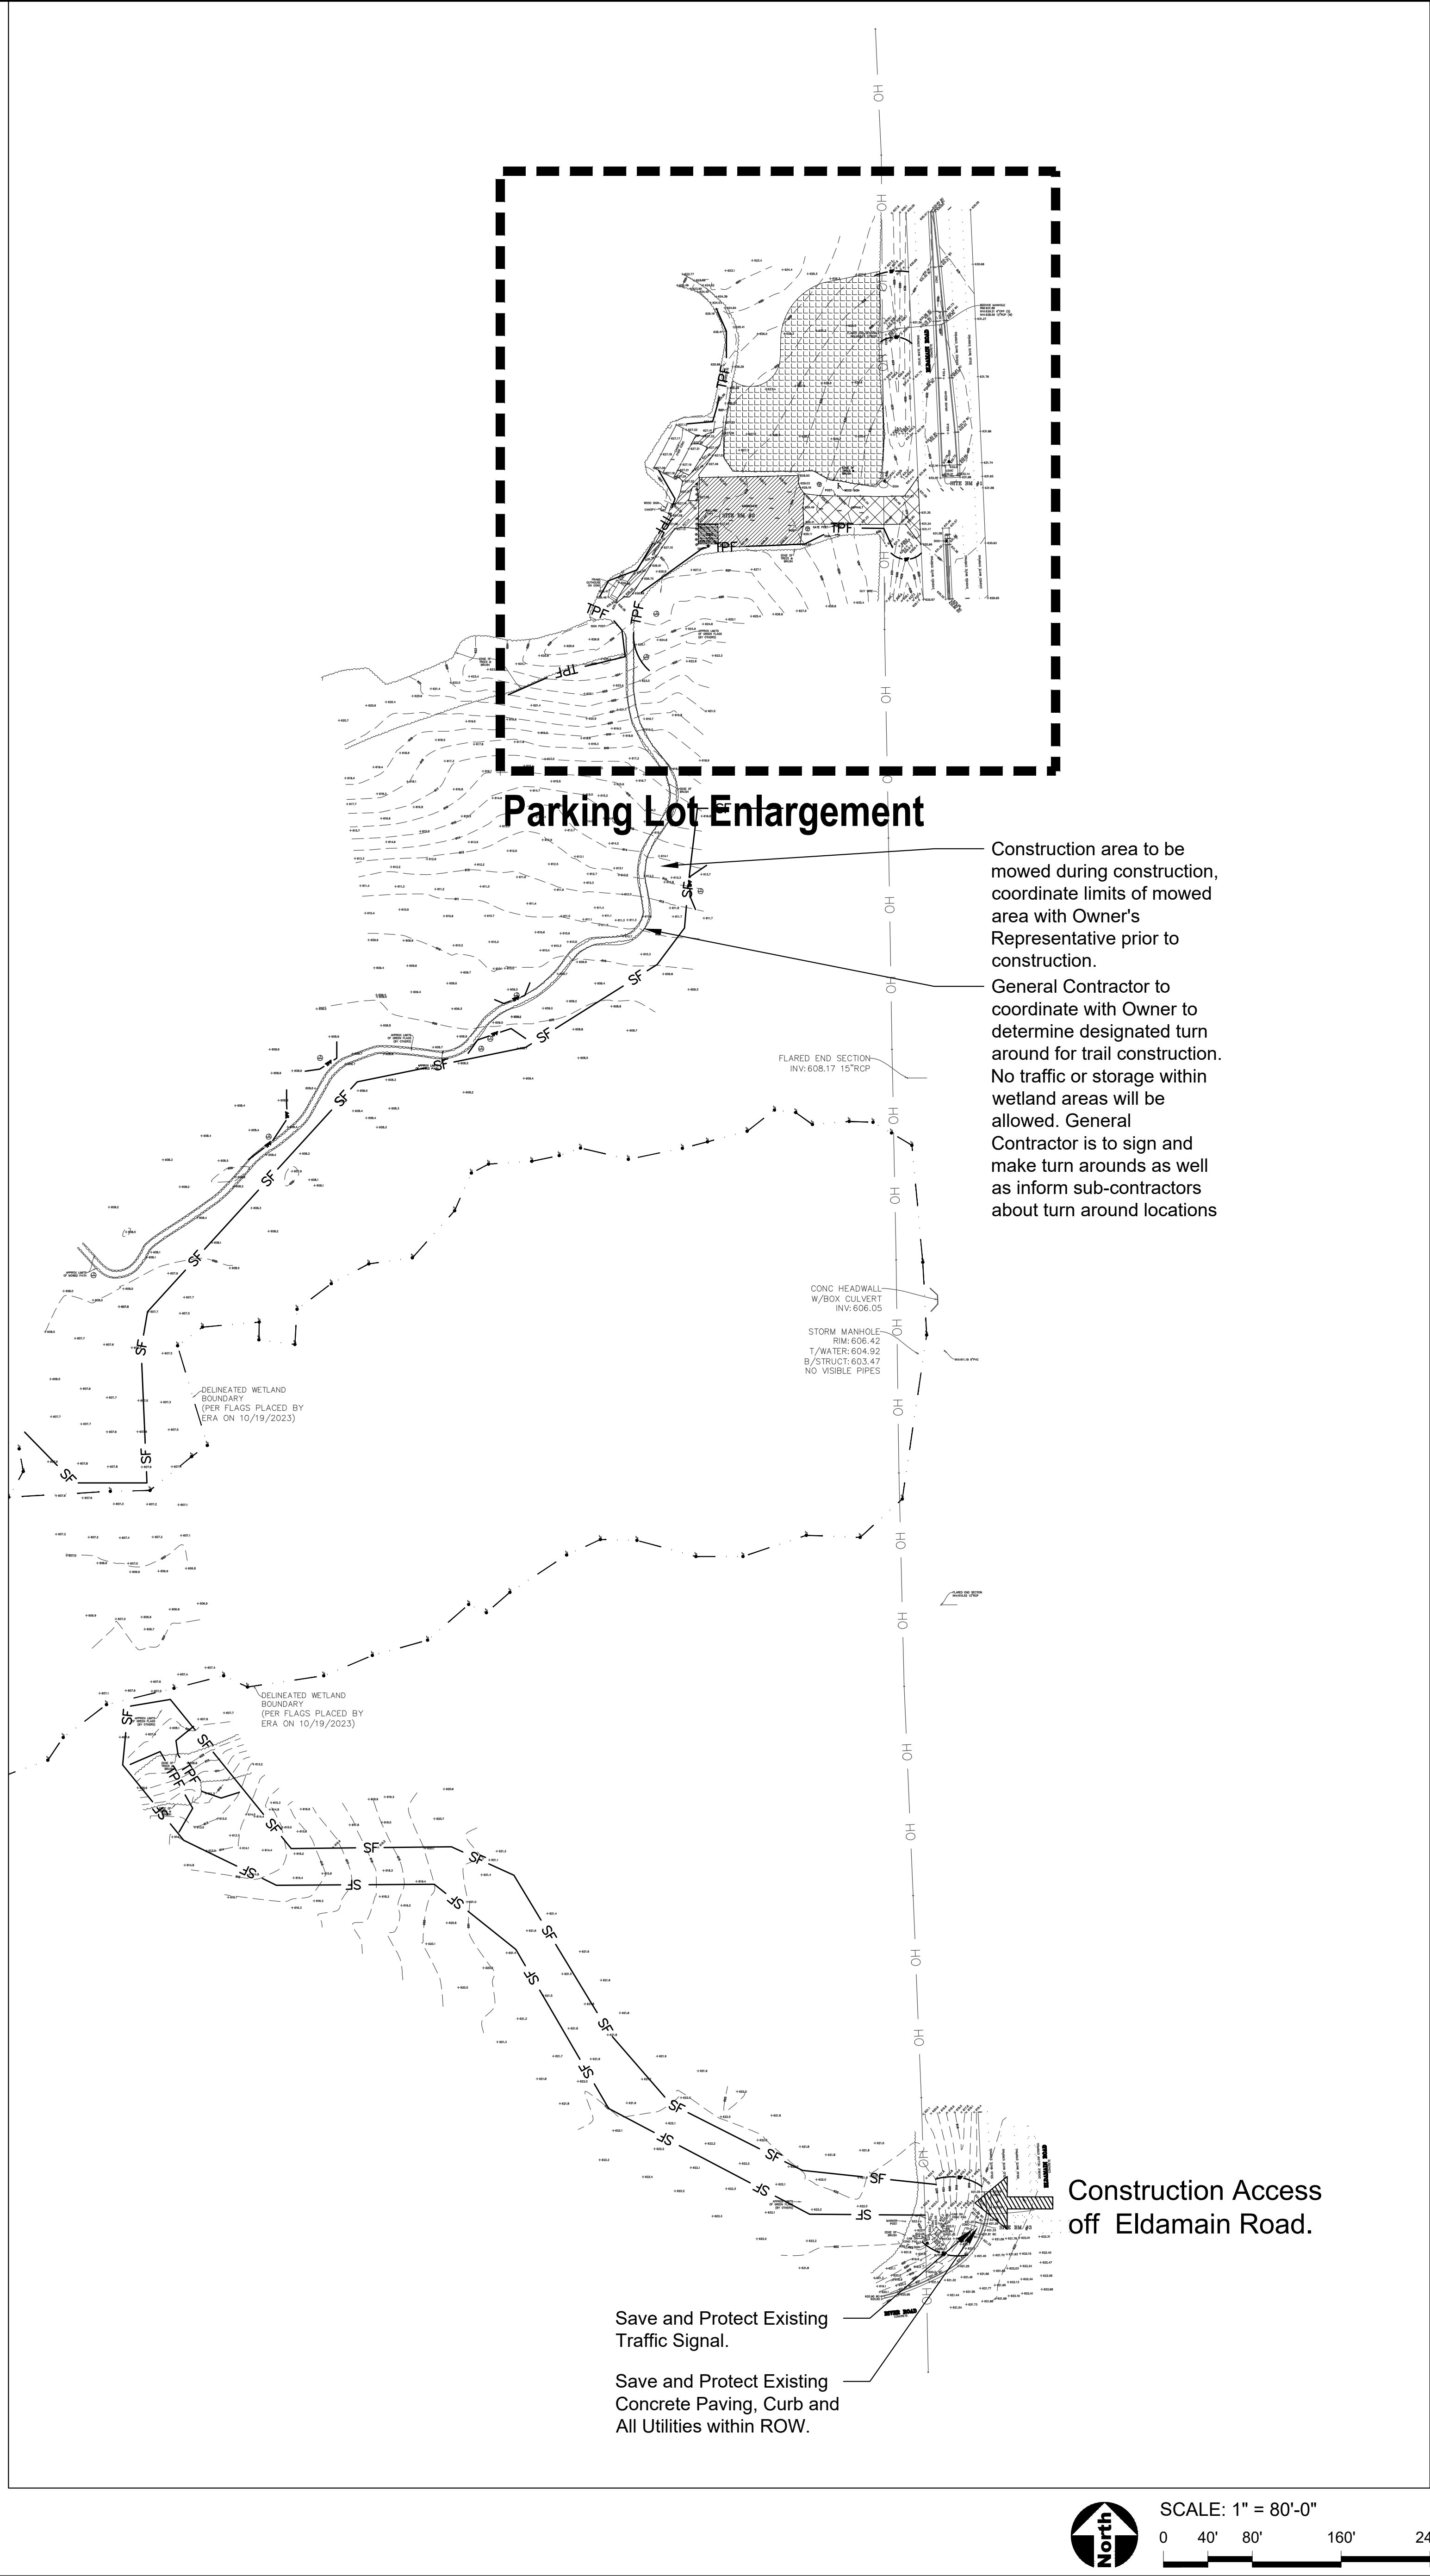
G201



DOOR CLEARANCES 4
SCALE: NONE

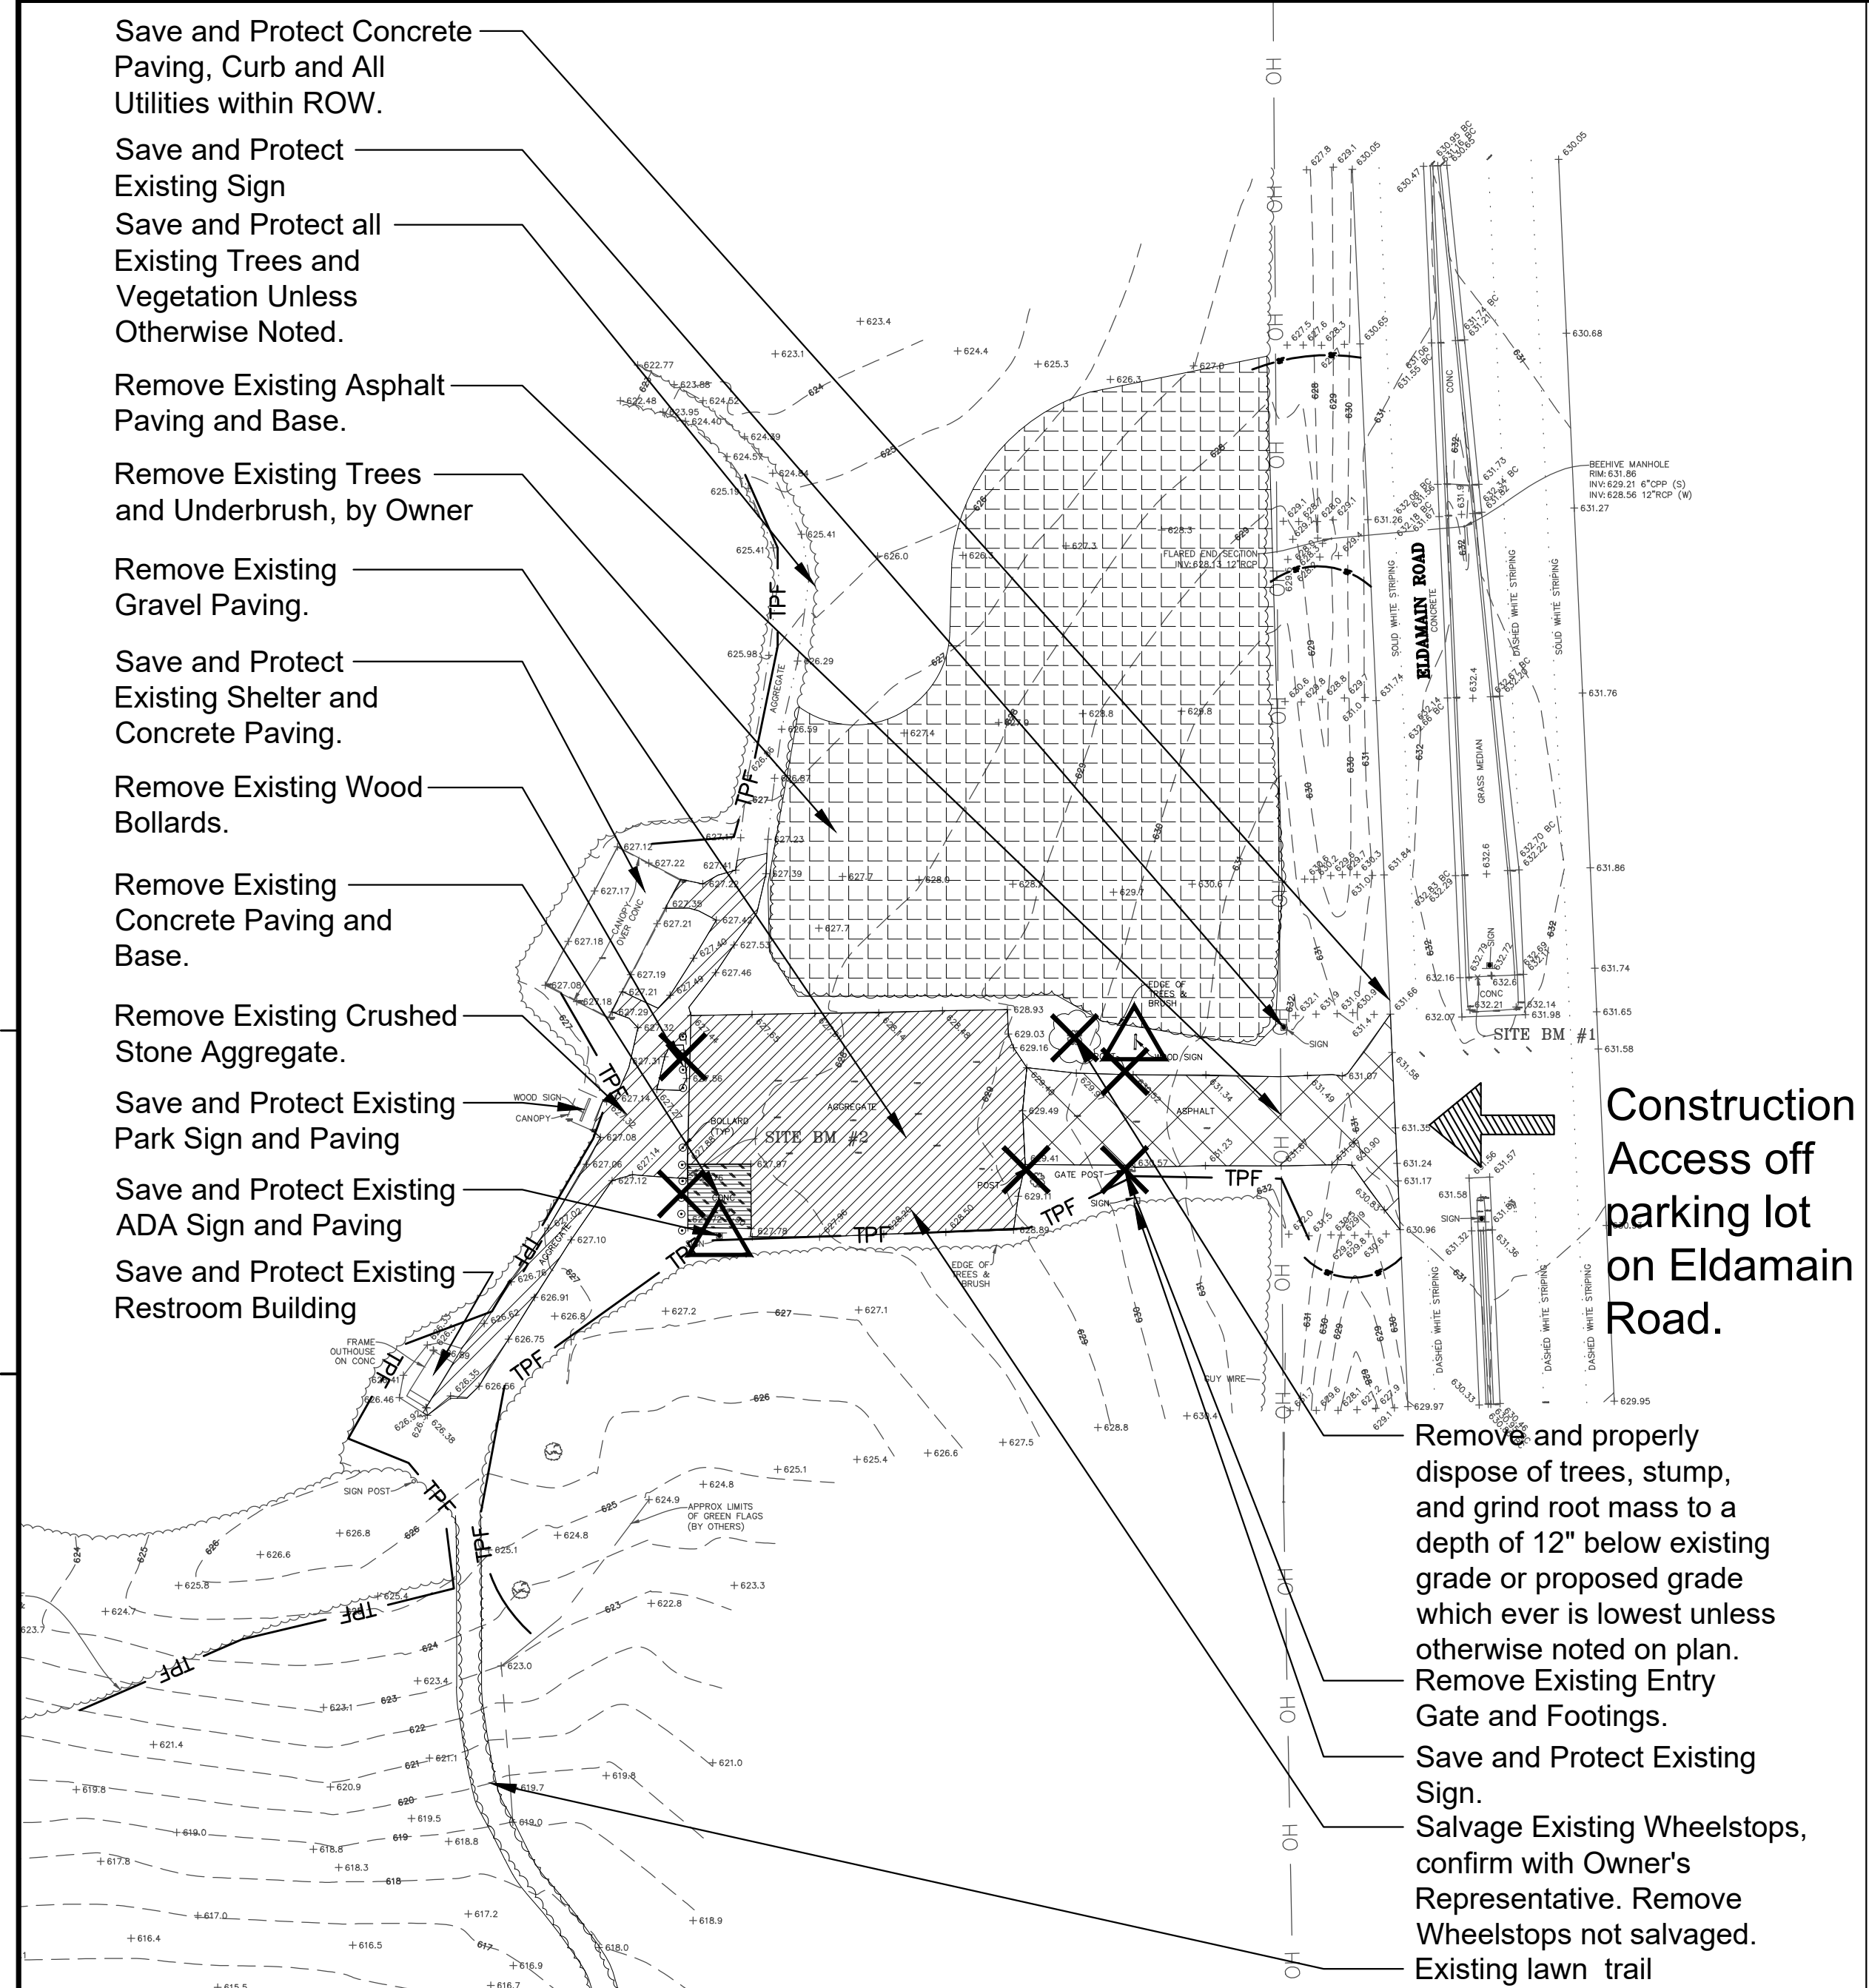

Parking Lot Enlargement



GENERAL NOTES: EXISTING CONDITIONS & REMOVALS

- The Contractor is to locate all utilities, public and private, prior to beginning construction. Contractor will be responsible for any damages to utilities caused by their work. Contact J.L.L. 12 hours prior to construction at 1-800-982-0123 or (811) for location of utilities and contractor shall be responsible for protection of the same.
- Site conditions are shown based upon available information, contractor to verify all existing conditions prior to bidding.
- The contractor shall be responsible for the protection of all private utilities even though they may not be shown on the plans. Any utility damaged during the construction shall be repaired or replaced to the satisfaction of the Owner at the contractor's expense. No tree shall be planted within 10 lateral feet of any underground waterline, sewer line, transmission line or other utility.
- Contours and elevations shown hereon are referenced to the North American vertical datum of 1988 (navd83)
- A Topographic Survey was completed for the Owner by:
JLH Land Surveying, Inc.
910 Geneva Street
Shorewood, Illinois 60404 Phone: 815-729-4000
- The Contractor shall walk the site prior to submitting a bid to be fully familiar with site conditions.
- The Contractor shall protect and preserve all section, property or survey reference markers.
- Tree Protection Fence to be installed as shown on plans and details prior to beginning construction, (incidental to cost). Do not drive, store equipment or materials within dripline of existing trees that are to be saved. Hold necessary disturbance to a minimum.
- Contractor will be held responsible for damage to items not scheduled for removal.
- Contractor shall repair or replace all damaged sidewalks, curbs or paving to remain in place that were damaged as a result of work stated in contract documents.
- No excavations are to be left open to foul weather, rain, snow, etc. which would necessitate further excavation and additional sub grade materials.
- Work site safety is the responsibility of the Contractor.
- Vehicular Construction access shall be at one location to minimize damage. Construction access shall be approved by the Owner's representative.
- Construction Limits: Construction Limits are as noted on plans. Do not store equipment or stockpile materials outside of construction limits. Any areas disturbed as a result of construction shall be restored to lawn or other surface by contractor to match pre-construction condition.
- Topsil may be stockpiled for redistribution as needed. Excess topsoil, debris and plant material to be removed off site and disposed of legally.
- Construction fence shall be installed prior to beginning construction. Construction fence to be free standing chainlink. (incidental to contract).
- Place erosion control measures as required to eliminate sedimentation into non-construction areas and as shown on plans and details prior to beginning construction.
- Before beginning work at the site and throughout the course of the work contractor to inspect and verify the location and condition of every item affected by the work under this contract and report discrepancies to the Owner's Representative before beginning work.
- Should discrepancies appear among the contract documents or between the contract documents and existing conditions, the contractor shall request an interpretation from the Owner's Representative before bidding. If the contractor fails to make such requests, it is presumed that both provisions were included in the bid, and the Owner's Representative shall determine which of the conflicting requirements shall govern. The contractor shall perform the work at no additional cost to the Owner in accordance with the Owner's Representative determination. Where conflicts exists between or within the contract documents between and applicable standards, codes, ordinances or manufacturers recommendations, and clarification has not been requested from the Owner's Representative prior to bidding as provided for above, the more stringent or higher quality standard shall prevail. Large scale drawings shall take precedence over small scale drawings, figured dimensions on the drawings over scaled dimensions and noted material over graphic representations.
- The contractor shall provide all work and materials which any section or part of the drawings, specifications or conditions require them to provide, regardless of whether such requirement is or is not faithfully repeated in other parts of the documents thereof to which the provisions might be appropriate.
- All necessary site work permits will be obtained by Owner. Contractor and all subcontractors shall register and pay associated fees to the Building Department. Contractor is responsible for following permit requirements including coordination of inspections and/or reinspections and associated fees.
- Contractor shall follow all permit requirements as part of the project.

PROJECT BENCHMARK

- SITE BENCHMARK #1
Set out cross on concrete median in Eldamain Road near the entrance of Subat Forest Preserve.
Elevation: 632.78 (NAVD 88)
- SITE BENCHMARK #2
Set out cross at the Northwest corner of concrete pad in aggregate parking area off the entrance to Subat Forest Preserve.
Elevation: 627.86 (NAVD 88)
- SITE BENCHMARK #3
Set out cross at the Northwest corner of concrete pad near the ADA ramp located at the Northwest corner of Eldamain Road and River Road.
Elevation: 621.28 (NAVD 88)

REMOVALS LEGEND

- Remove Existing Asphalt Paving
- Remove Existing Concrete Paving
- Remove Existing Gravel Paving
- Remove Existing Crushed Aggregate Paving
- Remove Existing Vegetation
- Remove and properly dispose of trees, stump, and grind root mass to a depth of 12" below existing grade or proposed grade which ever is lowest unless otherwise noted on plan.
- Remove and Dispose of Item as Marked
- Salvage and Relocate Item as Marked
- Construction Limits
- Tree Protection Fence
- Silt Fence

SURVEY LEGEND

- PROPERTY LINE
- LOT LINE/PARCEL LINE
- EX. SANITARY LINE
- EX. STORM LINE
- EX. WATER LINE
- EX. FENCE
- EX. OVERHEAD WIRE (APPROXIMATE LOCATION)
- EX. CONCRETE CURB & GUTTER
- EX. CONTOURS
- EX. FIRE HYDRANT
- EX. SPOT ELEVATION
- EX. CONIFEROUS TREE W/TRUNK SIZE IN INCHES
- EX. DECIDUOUS TREE W/TRUNK SIZE IN INCHES
- EX. BUSH


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SUBAT NATURE CENTER
KENDALL CO FOREST PRESERVE
ELDAMAIN RD
PLAINFIELD, IL 60545

CIVIL ENGINEER
Engineering Resource Associates
35701 West Avenue, Suite 150
Warrenville, Illinois 60555
IL License 184-001186



ISSUED	DATE	BY	DESCRIPTION
04/11/24			BID DOCUMENTS

JOB NO.	23-429-1495
DRAWN	EM
CHECKED	MK
APPROVED	MK

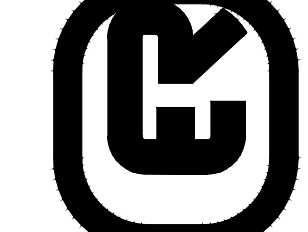SHEET TITLE

EXISTING CONDITIONS & REMOVALS PLAN

SHEET NUMBER

L100

STORM WATER POLLUTION PREVENTION PLAN

THE FOLLOWING PLAN IS ESTABLISHED AND INCORPORATED IN THE PROJECT TO DIRECT THE CONTRACTOR IN THE PLACEMENT OF TEMPORARY EROSION AND SEDIMENT CONTROL SYSTEMS AND TO PROVIDE A STORM WATER POLLUTION PREVENTION PLAN FOR COMPLIANCE UNDER NPDES.

THE PURPOSE OF THIS PLAN IS TO MINIMIZE EROSION WITHIN THE CONSTRUCTION SITE AND TO LIMIT SEDIMENT FROM LEAVING THE CONSTRUCTION SITE BY UTILIZING PROPER TEMPORARY EROSION AND SEDIMENT CONTROL SYSTEMS AND PROVIDING GROUND COVER WITHIN A REASONABLE AMOUNT OF TIME.

CERTAIN SEDIMENT CONTROL FACILITIES SHALL BE INSTALLED BY THE CONTRACTOR AT THE BEGINNING OF CONSTRUCTION. OTHER ITEMS SHALL BE INSTALLED BY THE CONTRACTOR AS DIRECTED BY THE ENGINEER ON A CASE BY CASE SITUATION DEPENDING ON THE CONTRACTOR'S SEQUENCE OF ACTIVITIES, TIME OF YEAR, AND EXPECTED WEATHER CONDITIONS.

THE CONTRACTOR SHALL INSTALL PERMANENT EROSION CONTROL SYSTEMS AND SEEDING WITHIN A TIME FRAME SPECIFIED HEREIN AND AS DIRECTED BY THE ENGINEER, THEREFORE MINIMIZING THE AMOUNT OF AREA SUSCEPTIBLE TO EROSION AND REDUCING THE AMOUNT OF TEMPORARY SEEDING. THE ENGINEER WILL DETERMINE IF ANY TEMPORARY EROSION CONTROL SYSTEMS SHOWN IN THE PLAN CAN BE DELETED AND IF ANY ADDITIONAL TEMPORARY EROSION CONTROL SYSTEMS, WHICH ARE NOT INCLUDED IN THIS PLAN, SHALL BE ADDED. THE CONTRACTOR SHALL PERFORM ALL WORK AS DIRECTED BY THE ENGINEER AND AS SHOWN IN IDOT STANDARD 280001.

SECTION 280, TEMPORARY EROSION CONTROL, OF THE STANDARD SPECIFICATIONS ADDITIONALLY SUPPLEMENTS THIS PLAN.

SITE DESCRIPTION DESCRIPTION OF CONSTRUCTION ACTIVITY:

1. THE PROJECT IS LOCATED IN SUBAT FOREST PRESERVE, KENDALL COUNTY, IL

2. THE SUBAT FOREST PRESERVE PROJECT SHALL GENERALLY CONSIST OF THE FOLLOWING:

- 1.) INSTALLATION OF NEW ASPHALT AND LIMESTONE WALKING PATHS;
- 2.) REMOVAL AND REPLACEMENT/EXPANSION OF A PARKING LOT;
- 3.) INSTALLATION OF PARKING LOT ENTRANCES ALONG ELDAMAIN ROAD;
- 4.) CULVERT INSTALLATION WITHIN THE ROADSIDE DITCH ALONG ELDAMAIN ROAD AND THE NORTHWEST CORNER OF THE INTERSECTION OF ELDAMAIN ROAD AND RIVER ROAD;
- 5.) INSTALLATION OF A NATURE CENTER PAVILION AND ASSOCIATED CONCRETE PAD; AND
- 6.) INSTALLATION OF A BOARDWALK

DESCRIPTION OF INTENDED SEQUENCE FOR MAJOR CONSTRUCTION ACTIVITIES WHICH WILL DISTURB SOILS FOR MAJOR PORTION OF THE CONSTRUCTION SITE:

1. INSTALL SILT FENCING, TREE PROTECTION FENCING, STABILIZED CONSTRUCTION ENTRANCE, AND TEMPORARY CONCRETE WASHOUT.
2. INSTALL FLARED END PROTECTION IMMEDIATELY FOLLOWING INSTALLATION OF CULVERTS.
3. SITE SHALL BE TEMPORARILY STABILIZED IMMEDIATELY FOLLOWING GRADING COMPLETION.
4. THE SITE SHALL BE SEEDING AND STABILIZED WITH EROSION CONTROL MAT UPON COMPLETION OF GRADING.
5. TEMPORARY EROSION CONTROL MEASURES WILL BE REMOVED FOLLOWING FINAL STABILIZATION.

AREA OF CONSTRUCTION SITE:

APPROXIMATELY 1.65 ACRES WILL BE DISTURBED BY EXCAVATION, GRADING, AND OTHER ACTIVITIES.

OTHER REPORTS, STUDIES AND PLANS, WHICH AID IN THE DEVELOPMENT OF THE STORM WATER POLLUTION PREVENTION PLAN AS REFERENCED DOCUMENTS:

1. INFORMATION OF THE SOILS AND TERRAIN WITHIN THE SITE WAS OBTAINED FROM TOPOGRAPHIC SURVEYS AND SOIL SURVEYS THAT WERE UTILIZED FOR THE DEVELOPMENT OF THE PROPOSED TEMPORARY EROSION AND SEDIMENT CONTROL SYSTEMS.
2. PROJECT PLAN DOCUMENTS, SPECIFICATIONS AND SPECIAL PROVISIONS, AND PLAN DRAWINGS INDICATING DRAINAGE PATTERNS AND APPROXIMATE SLOPES ANTICIPATED AFTER GRADING ACTIVITIES WERE UTILIZED FOR THE PROPOSED PLAN OF THE TEMPORARY EROSION CONTROL SYSTEMS.

DRAINAGE TRIBUTARIES AND SENSITIVE AREAS RECEIVING RUNOFF FROM THIS CONSTRUCTION SITE:

1. ON-SITE WETLANDS

THIS PLAN HAS BEEN PREPARED TO COMPLY WITH THE PROVISIONS OF THE NPDES PERMIT NUMBER ILR10 ISSUED BY THE ILLINOIS ENVIRONMENTAL PROTECTION AGENCY FOR STORM WATER DISCHARGES FROM CONSTRUCTION SITE ACTIVITIES.

I CERTIFY UNDER PENALTY OF LAW THAT THIS DOCUMENT AND ALL ATTACHMENTS WERE PREPARED UNDER MY DIRECTION OR SUPERVISION IN ACCORDANCE WITH A SYSTEM DESIGNED TO ASSURE THAT QUALIFIED PERSONNEL, PROPERLY GATHERED AND EVALUATED THE INFORMATION SUBMITTED, BASED ON MY INQUIRY OF THE PERSON OR PERSONS WHO MANAGE THE SYSTEM, OR THOSE PERSONS DIRECTLY RESPONSIBLE FOR GATHERING THE INFORMATION, THE INFORMATION SUBMITTED IS TO THE BEST OF MY KNOWLEDGE AND BELIEF, TRUE, ACCURATE AND AWARE THAT THERE ARE SIGNIFICANT PENALTIES FOR SUBMITTING FALSE INFORMATION, INCLUDING THE POSSIBILITY OF FINE AND IMPRISONMENT FOR KNOWING VIOLATIONS.

ENGINEER: _____

DATE: _____

SEDIMENT EROSION CONTROL AND POLLUTION PREVENTION NOTES:

1. DURING CONSTRUCTION, AREAS OUTSIDE THE CONSTRUCTION LIMITS SHALL BE PROTECTED.
2. THE CONTRACTOR SHALL NOT USE THIS AREA FOR STAGING, PARKING OF VEHICLES OR CONSTRUCTION EQUIPMENT, STORAGE OF MATERIALS OR OTHER CONSTRUCTION RELATED ACTIVITIES.
3. CONSTRUCTION EQUIPMENT SHALL BE STORED AT DESIGNATED LOCATIONS. ALL NECESSARY MEASURES SHALL BE TAKEN TO CONTAIN ANY FUEL OR OTHER POLLUTANT IN ACCORDANCE WITH EPA WATER QUALITY REGULATIONS.
4. LEAKING EQUIPMENT OR SUPPLIES SHALL BE IMMEDIATELY REPAIRED OR REMOVED FROM THE SITE.
5. TEMPORARY SEDIMENT CONTROL SYSTEMS SHALL BE LEFT IN PLACE WITH PROPER MAINTENANCE UNTIL PERMANENT EROSION CONTROL IS IN PLACE AND WORKING PROPERLY AND ALL PERMANENT VEGETATION IS GROWING AND THRIVING.
6. EROSION CONTROL MEASURES SHALL BE INSTALLED PRIOR TO START OF CONSTRUCTION.
7. ALL EROSION CONTROL MEASURES MUST BE INSPECTED WEEKLY AND AFTER EACH 1/2" RAIN EVENT.
8. THE EROSION CONTROL, BLANKET AND/OR STRAW MULCH WITH NETTING (DEPENDENT ON SLOPE, SLOPE LENGTH AND FLOW RATES) SHALL BE INSTALLED ON ALL SLOPES AND IN CRITICAL AREAS (I.E. POND PERIMETER, BERMS, ETC.) IMMEDIATELY UPON FINAL GRADING.
9. IN AREAS WHERE WORK IS COMPLETE, PERMANENT STABILIZATION SHALL OCCUR WITHIN 7 DAYS OF COMPLETION, AND IN AREAS WHERE WORK HAS TEMPORARILY CEASED FOR 14 DAYS OR MORE, TEMPORARY STABILIZATION SHALL OCCUR BY THE 7TH DAY AFTER WORK HAS CEASED.
10. WINTER SHUTDOWNS SHALL BE ADDRESSED EARLY IN THE FALL GROWING SEASON SO THAT SLOPES AND OTHER BARE EARTH AREAS MAY BE STABILIZED WITH TEMPORARY AND/OR PERMANENT VEGETATIVE COVER FOR PROPER EROSION AND SEDIMENT CONTROL.
11. ALL ADJACENT STREETS MUST BE KEPT CLEAR OF DEBRIS, INSPECTED DAILY, AND CLEANED WHEN NECESSARY AND AS DIRECTED BY ENGINEER.
12. UNLESS OTHERWISE INDICATED, ALL VEGETATIVE AND STRUCTURAL EROSION AND SEDIMENT CONTROL PRACTICES WILL BE CONSTRUCTED ACCORDING TO MINIMUM STANDARDS AND SPECIFICATIONS IN THE MOST RECENT ILLINOIS URBAN MANUAL.
13. THE COUNTY MUST BE NOTIFIED ONE WEEK PRIOR TO THE PRE-CONSTRUCTION CONFERENCE, ONE WEEK PRIOR TO THE COMMENCEMENT OF LAND DISTURBING ACTIVITIES, AND ONE WEEK PRIOR TO THE FINAL INSPECTION.
14. A COPY OF THE APPROVED EROSION AND SEDIMENT CONTROL PLAN SHALL BE MAINTAINED ON THE SITE AT ALL TIMES.
15. PRIOR TO COMMENCING LAND-DISTURBING ACTIVITIES IN AREAS OTHER THAN INDICATED ON THESE PLANS (INCLUDING BUT NOT LIMITED TO, ADDITIONAL PHASES OF DEVELOPMENT AND OFF-SITE BORROW OR WASTE AREAS) A SUPPLEMENTARY EROSION CONTROL PLAN SHALL BE SUBMITTED TO THE OWNER FOR REVIEW BY THE COUNTY.
16. THE CONTRACTOR IS RESPONSIBLE FOR INSTALLATION OF ANY ADDITIONAL EROSION CONTROL MEASURES NECESSARY TO PREVENT EROSION AND SEDIMENTATION AS DETERMINED BY THE COUNTY.
17. NO WORK SHALL BE PERFORMED IN FLOWING WATER, WORK IN AND NEAR THE CRITICAL AREAS SHOULD BE ISOLATED FROM CONCENTRATED FLOWS OR STREAM FLOW. ONCE WORK IN THIS AREA BEGINS, PRIORITY SHALL BE GIVEN TO THE COMPLETION OF THE WORK AND FINAL STABILIZATION OF ALL DISTURBED AREAS.
18. IT IS THE RESPONSIBILITY OF THE LANDOWNER AND/OR GENERAL CONTRACTOR TO INFORM ANY SUB-CONTRACTOR(S) WHO MAY PERFORM WORK ON THIS PROJECT, OF THE REQUIREMENTS IN IMPLEMENTING AND MAINTAINING THESE EROSION CONTROL PLANS AND ASSURE COMPLIANCE WITH ALL APPLICABLE LOCAL, STATE AND FEDERAL REGULATIONS.
19. EXCAVATED AREAS SHALL BE PERMANENTLY SEEDED IMMEDIATELY AFTER FINAL GRADING. IF NOT, THEY SHALL BE TEMPORARILY SEEDED IF NO CONSTRUCTION ACTIVITY IN THE AREA IS PLANNED FOR SEVEN (7) DAYS.
20. TEMPORARY EROSION CONTROL SEEDING SHALL BE APPLIED AT A RATE OF 50 LBS/ACRES.
21. CONSTRUCTION IS COMPLETE AFTER ACCEPTANCE BY THE OWNER. MAINTENANCE UP TO THIS DATE WILL BE BY THE CONTRACTOR.
22. SEDIMENT COLLECTED DURING CONSTRUCTION BY THE VARIOUS TEMPORARY SEDIMENT CONTROL SYSTEMS SHALL BE DISPOSED OF ON THE SITE ON A REGULAR BASIS, AS DIRECTED BY THE ENGINEER. THE COST OF THIS MAINTENANCE SHALL BE PAID FOR AT THE CONTRACT UNIT PRICE PER CUBIC YARD FOR EARTH EXCAVATION.
23. ALL TEMPORARY EROSION AND SEDIMENT CONTROL MEASURES SHALL BE REMOVED WITHIN 30 DAYS AFTER FINAL STABILIZATION IS ACHIEVED. TRAPPED SEDIMENT RESULTING FROM TEMPORARY MEASURES SHALL BE PROPERLY DISPOSED OF PRIOR TO PERMANENT STABILIZATION.
24. ALL EROSION AND SEDIMENT CONTROL PRODUCTS FURNISHED SHALL BE SPECIFICALLY RECOMMENDED BY THE MANUFACTURER FOR THE USE SPECIFIED IN THE EROSION AND SEDIMENT CONTROL PLAN. PRIOR TO THE APPROVAL AND USE OF THE PROJECT, THE CONTRACTOR SHALL SUBMIT TO THE ENGINEER A NOTARIZED CERTIFICATION BY THE PRODUCER STATING THE INTENDED USE OF THE PRODUCT AND THAT THE PHYSICAL PROPERTIES REQUIRED FOR THIS APPLICATION ARE MET OR EXCEEDED. THE CONTRACTOR SHALL PROVIDE MANUFACTURER INSTALLATION PROCEDURES TO FACILITATE THE ENGINEER IN CONSTRUCTION INSPECTION.
25. THE DRAWINGS, SPECIFICATIONS AND SPECIAL PROVISIONS WILL ENSURE THAT EXISTING VEGETATION IS PRESERVED WHERE ATTAINABLE AND DISTURBED PORTIONS OF THE SITE WILL BE STABILIZED. STABILIZATION PRACTICES INCLUDE TEMPORARY SEEDING, PERMANENT SEEDING, MULCHING, PROTECTION OF TREES, PRESERVATION OF NATURAL VEGETATION, AND OTHER APPROPRIATE MEASURES AS DIRECTED BY THE ENGINEER. STABILIZATION MEASURES SHALL BE INITIATED AS SOON AS PRACTICABLE IN PORTIONS OF THE SITE WHERE CONSTRUCTION ACTIVITIES HAVE TEMPORARILY OR PERMANENTLY CEASED, BUT IN NO CASE MORE THAN 7 DAYS AFTER THE CONSTRUCTION ACTIVITY IN THAT PORTION OF THE SITE HAS TEMPORARILY OR PERMANENTLY CEASED.
26. AREAS OF EXISTING VEGETATION, WOOD AND GRASSLANDS, OUTSIDE THE PROPOSED CONSTRUCTION LIMITS SHALL BE IDENTIFIED BY THE ENGINEER FOR PRESERVING AND SHALL BE PROTECTED FROM CONSTRUCTION ACTIVITIES.
27. DEAD, DISEASED, OR UNSUITABLE VEGETATION WITHIN THE SITE SHALL BE REMOVED AS DIRECTED BY THE ENGINEER.
28. BARE AND SPARSELY VEGETATED GROUND IN HIGH EROSION AREAS AS DETERMINED BY THE ENGINEER SHALL BE TEMPORARILY SEEDED AT THE BEGINNING OF CONSTRUCTION WHERE NO CONSTRUCTION ACTIVITIES ARE EXPECTED WITHIN SEVEN (7) DAYS.
29. THE SITE SHOULD BE PHASED IN A WAY THAT REDUCES THE AMOUNT OF STRIPPED, UNSTABILIZED AREAS WITHIN THE SITE AT ANY ONE TIME. MASS GRADING THE ENTIRE SITE SHOULD BE AVOIDED AS TO PREVENT EROSION ON SITE AND SEDIMENTATION ISSUES DOWNSTREAM.
30. BARRIER PROTECTION SHALL BE PLACED AT THE LIMITS OF SOIL DISTURBANCE FOR ALL UNDISTURBED WETLAND AREAS.

CONTRACTOR'S CERTIFICATION:

"I CERTIFY UNDER PENALTY OF LAW THAT I UNDERSTAND THE TERMS AND CONDITIONS OF THE GENERAL NATIONAL POLLUTANT DISCHARGE ELIMINATION SYSTEM (NPDES) PERMIT TO ASSURE THAT QUALIFIED PERSONNEL, PROPERLY GATHERED AND EVALUATED THE INFORMATION SUBMITTED, BASED ON MY INQUIRY OF THE PERSON OR PERSONS WHO MANAGE THE SYSTEM, OR THOSE PERSONS DIRECTLY RESPONSIBLE FOR GATHERING THE INFORMATION, THE INFORMATION SUBMITTED IS TO THE BEST OF MY KNOWLEDGE AND BELIEF, TRUE, ACCURATE AND COMPLETE. I AM AWARE THERE ARE SIGNIFICANT PENALTIES FOR SUBMITTING FALSE INFORMATION, INCLUDING THE POSSIBILITY OF FINE AND IMPRISONMENT FOR KNOWING VIOLATIONS."

GENERAL CONTRACTOR
SIGNATURE _____ TITLE _____ DATE _____
COMPANY _____

OWNER'S CERTIFICATION:

"I CERTIFY UNDER PENALTY OF LAW THAT THIS DOCUMENT AND ALL ATTACHMENTS WERE PREPARED UNDER MY DIRECTION OR SUPERVISION IN ACCORDANCE WITH A SYSTEM DESIGNED TO ASSURE THAT QUALIFIED PERSONNEL, PROPERLY GATHERED AND EVALUATED THE INFORMATION SUBMITTED, BASED ON MY INQUIRY OF THE PERSON OR PERSONS WHO MANAGE THE SYSTEM, OR THOSE PERSONS DIRECTLY RESPONSIBLE FOR GATHERING THE INFORMATION, THE INFORMATION SUBMITTED IS TO THE BEST OF MY KNOWLEDGE AND BELIEF, TRUE, ACCURATE AND COMPLETE. I AM AWARE THERE ARE SIGNIFICANT PENALTIES FOR SUBMITTING FALSE INFORMATION, INCLUDING THE POSSIBILITY OF FINE AND IMPRISONMENT FOR KNOWING VIOLATIONS."

OWNER
SIGNATURE _____ TITLE _____ DATE _____
COMPANY _____



REMOVALS LEGEND

- TPF Tree Protection Fence
- SF Silt Fence


- 2 Silt Fence
- 4 Temporary Concrete Washout
- 1 Tree Protection Fence
- 3 Soil Erosion Control Blanket - by Others

Stockpile excavated soils not used as backfill at nature center pad within designated boundary. Grade to maintain existing drainage direction (south/southwest). Excess/unusable soils shall not be placed within 50' of the delineated wetland boundary.


No traffic or storage within wetland areas will be allowed.

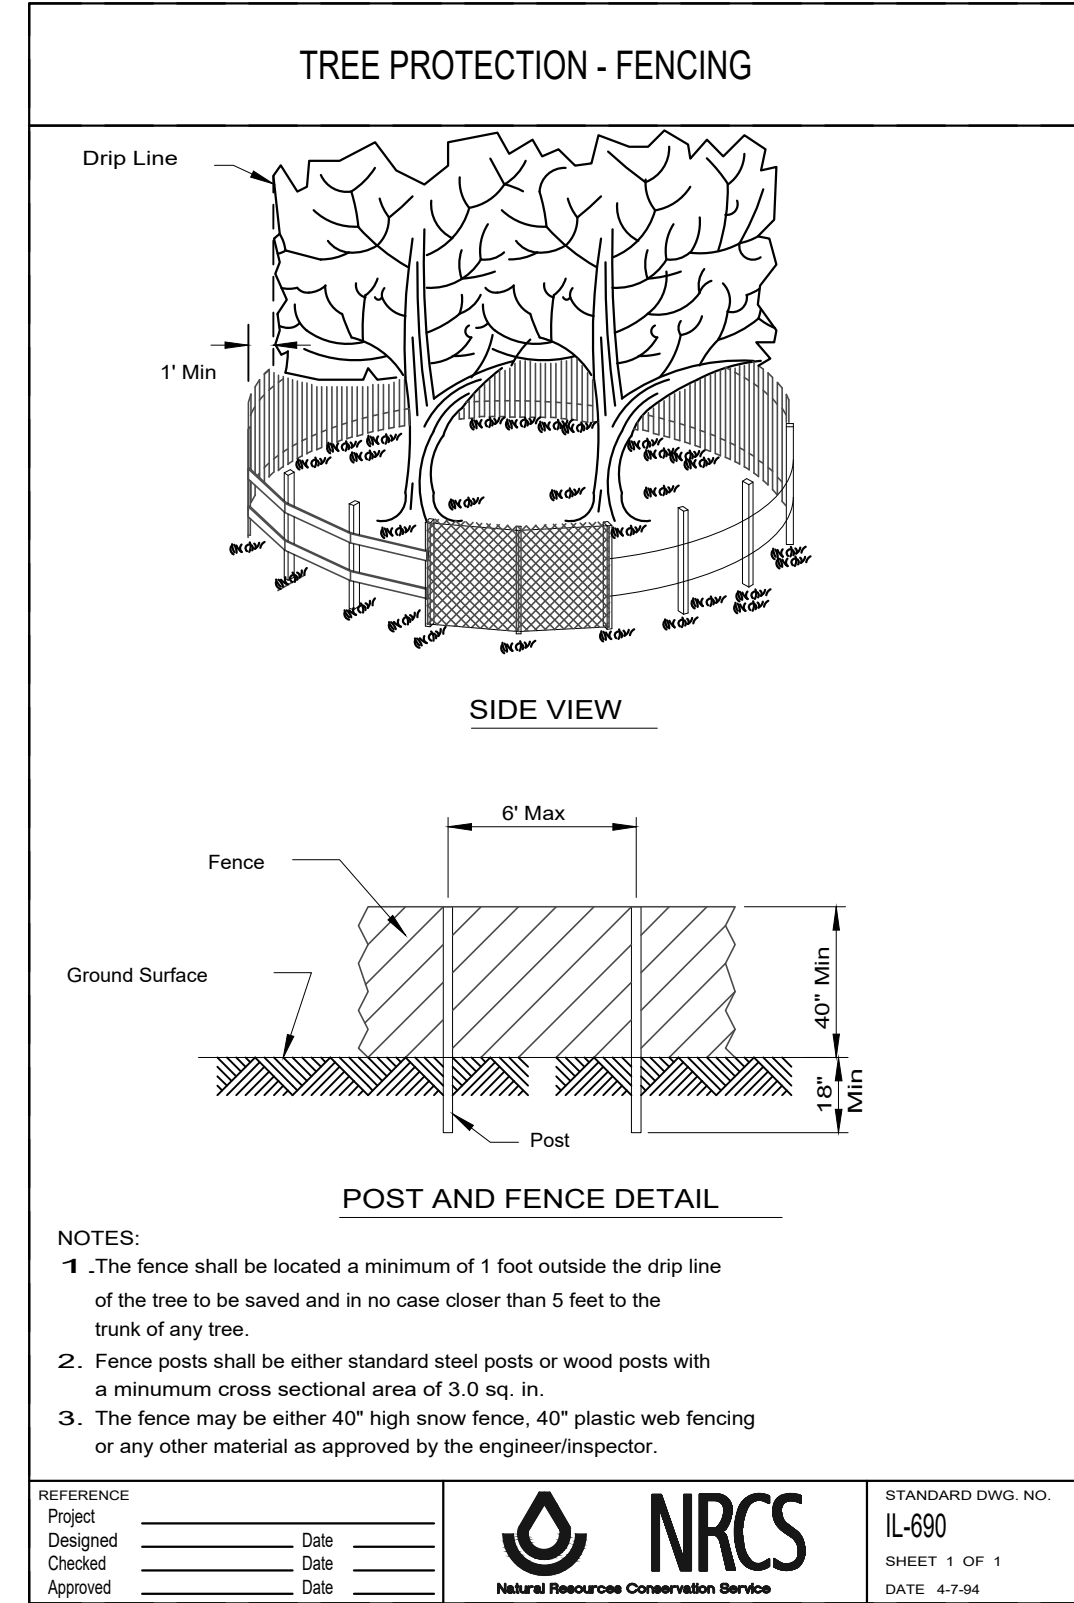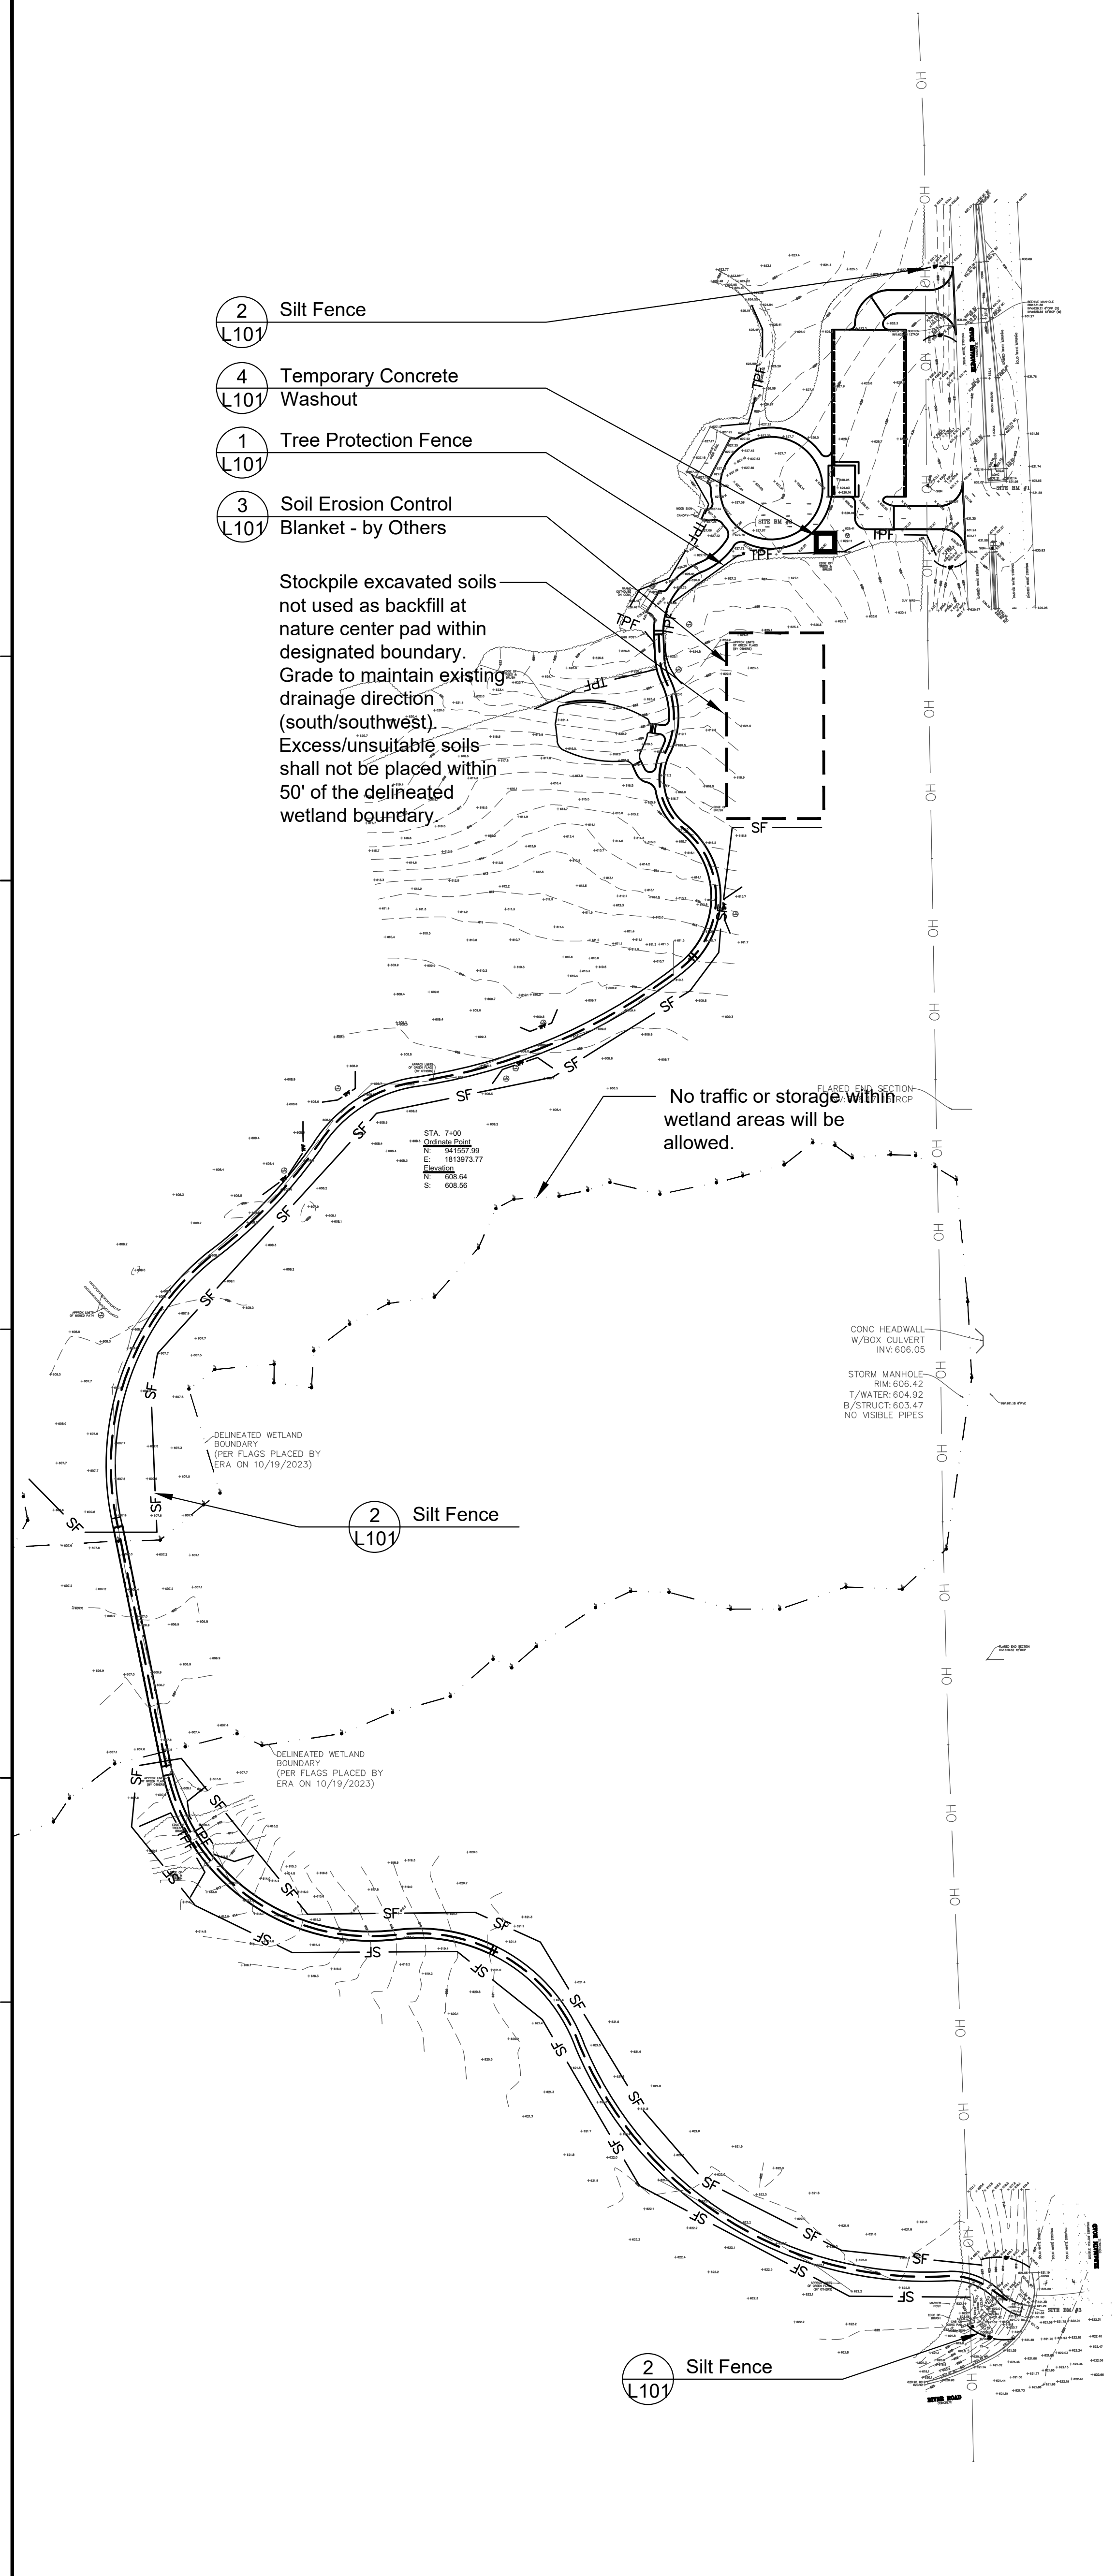



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4 Temporary Concrete Washout
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2 Silt Fence
SCALE: NTS d-IUM 620B-silt fence_12

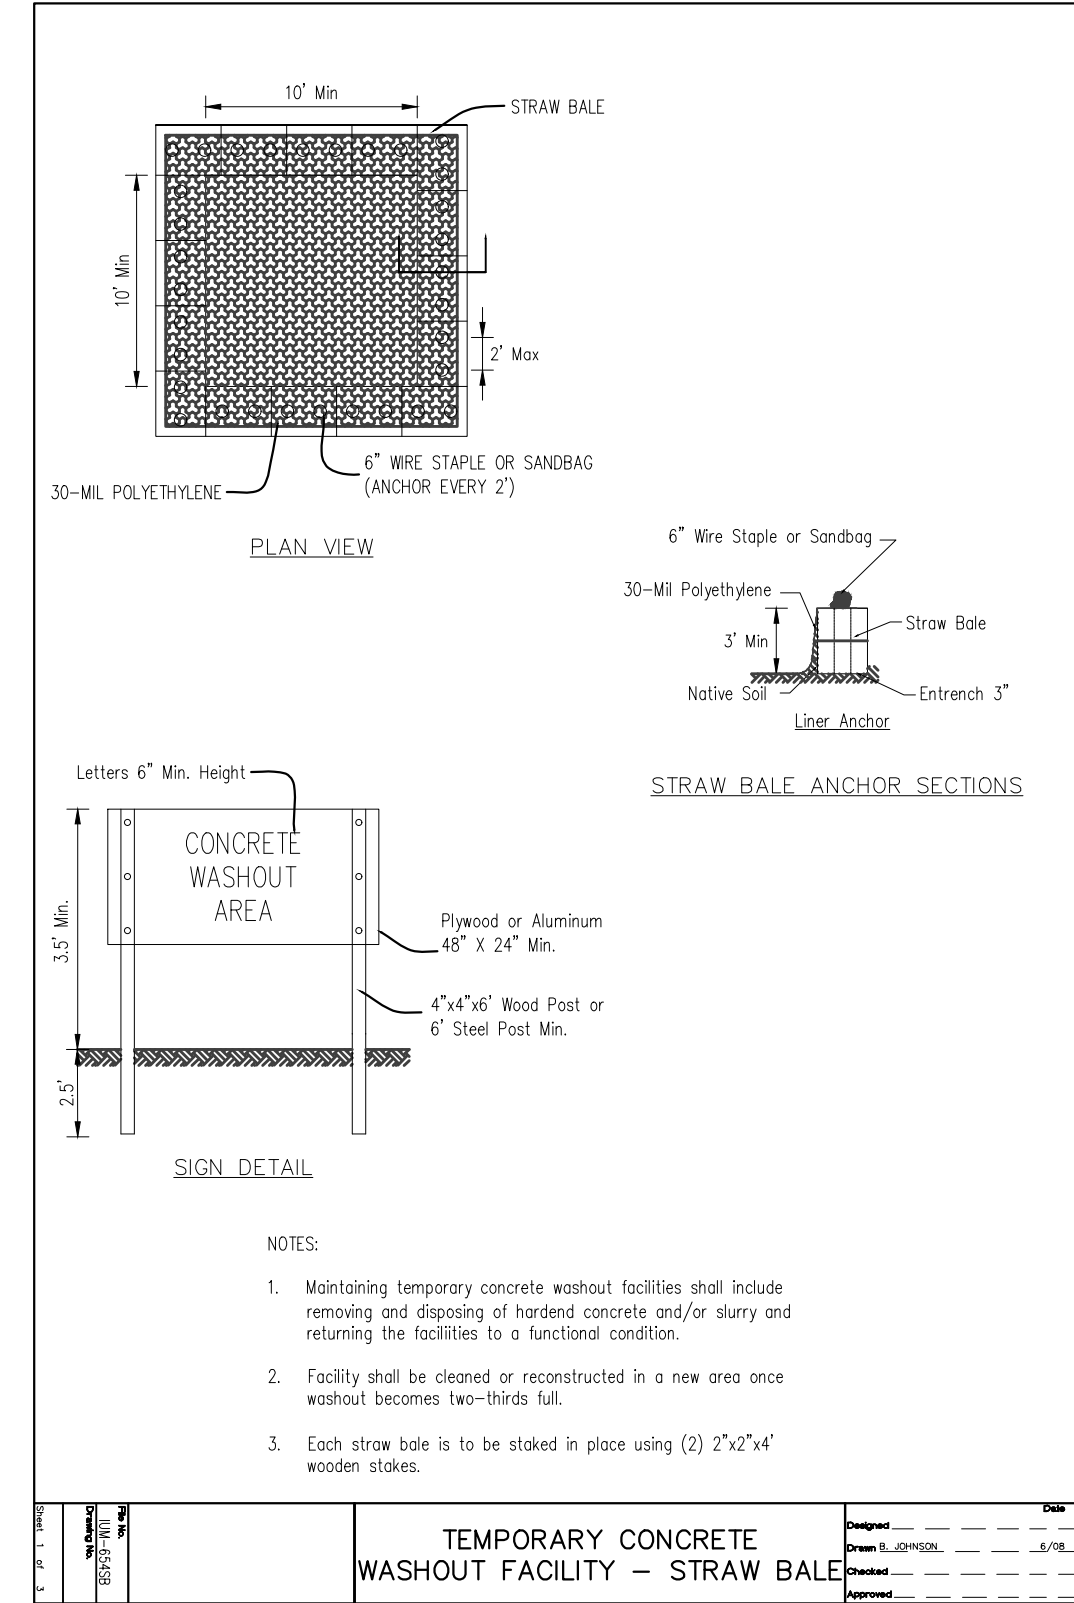

3 Erosion Control Blanket
SCALE: NTS d-IUM-530-erosion control blanket_12
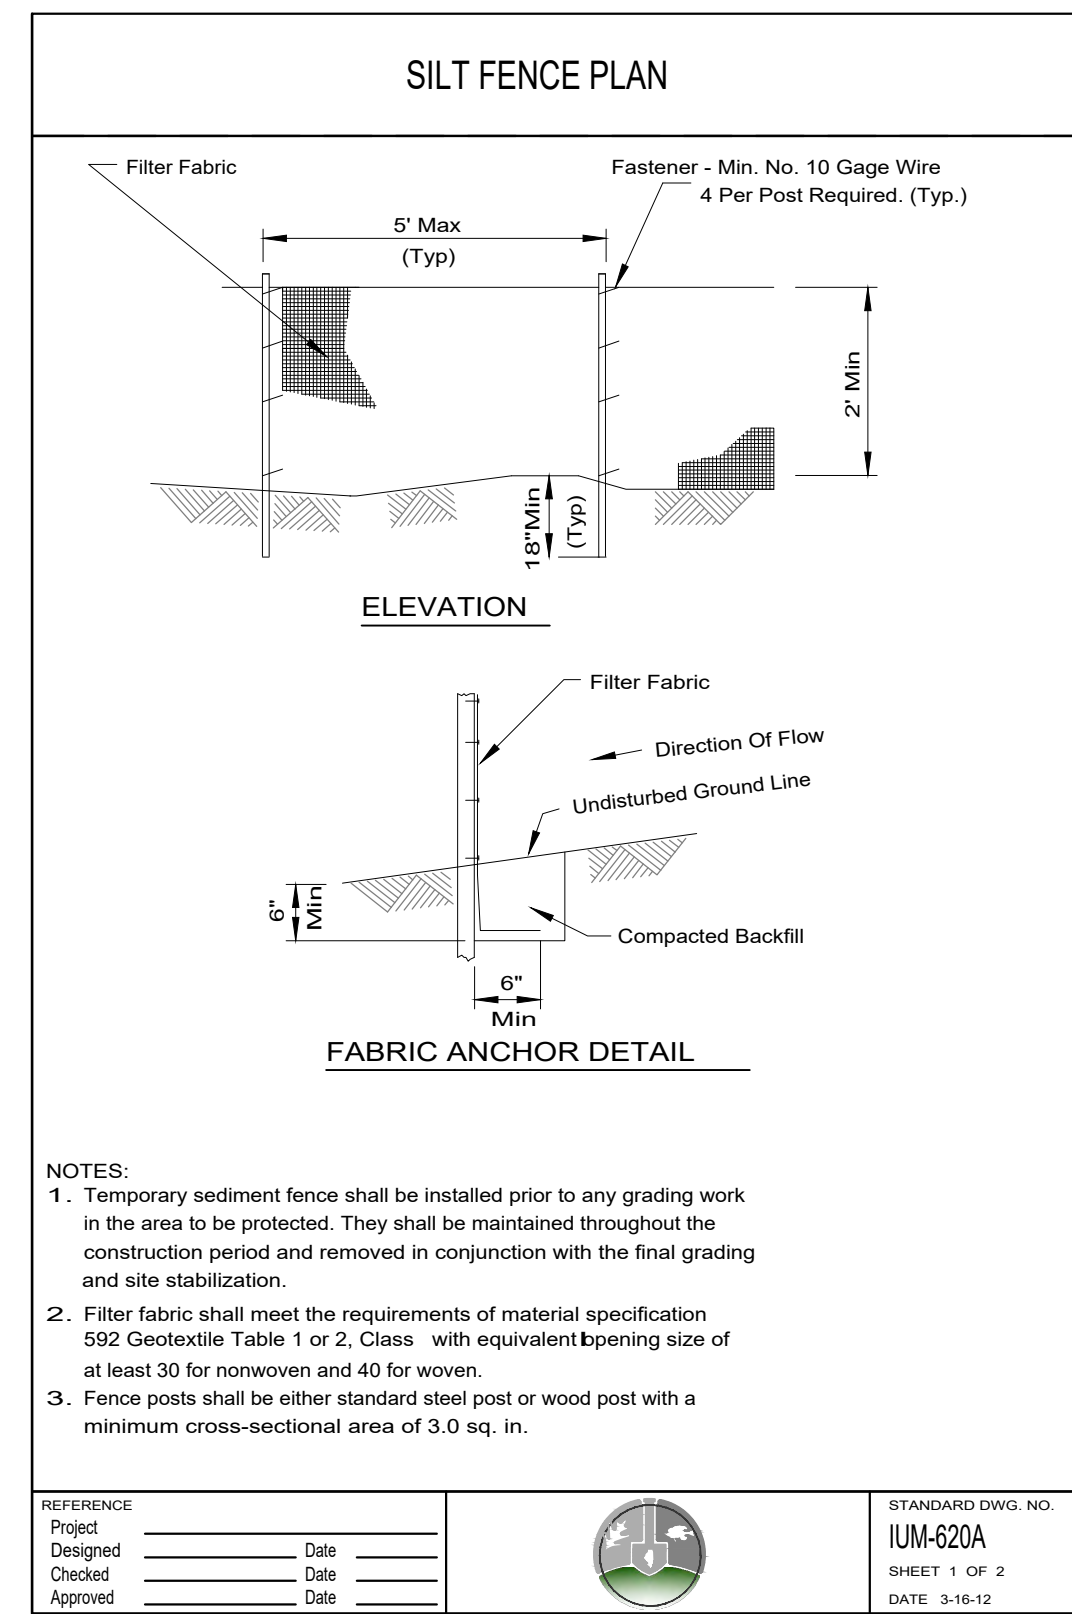
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ISSUED	BID DOCUMENTS
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2/15/24	2/15/24
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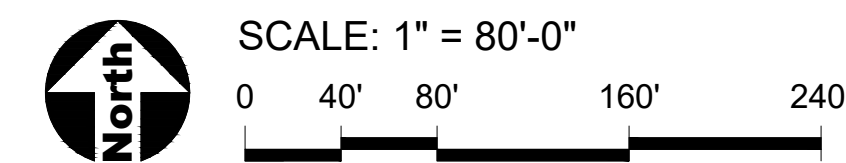
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APPROVED MK

SHEET TITLE

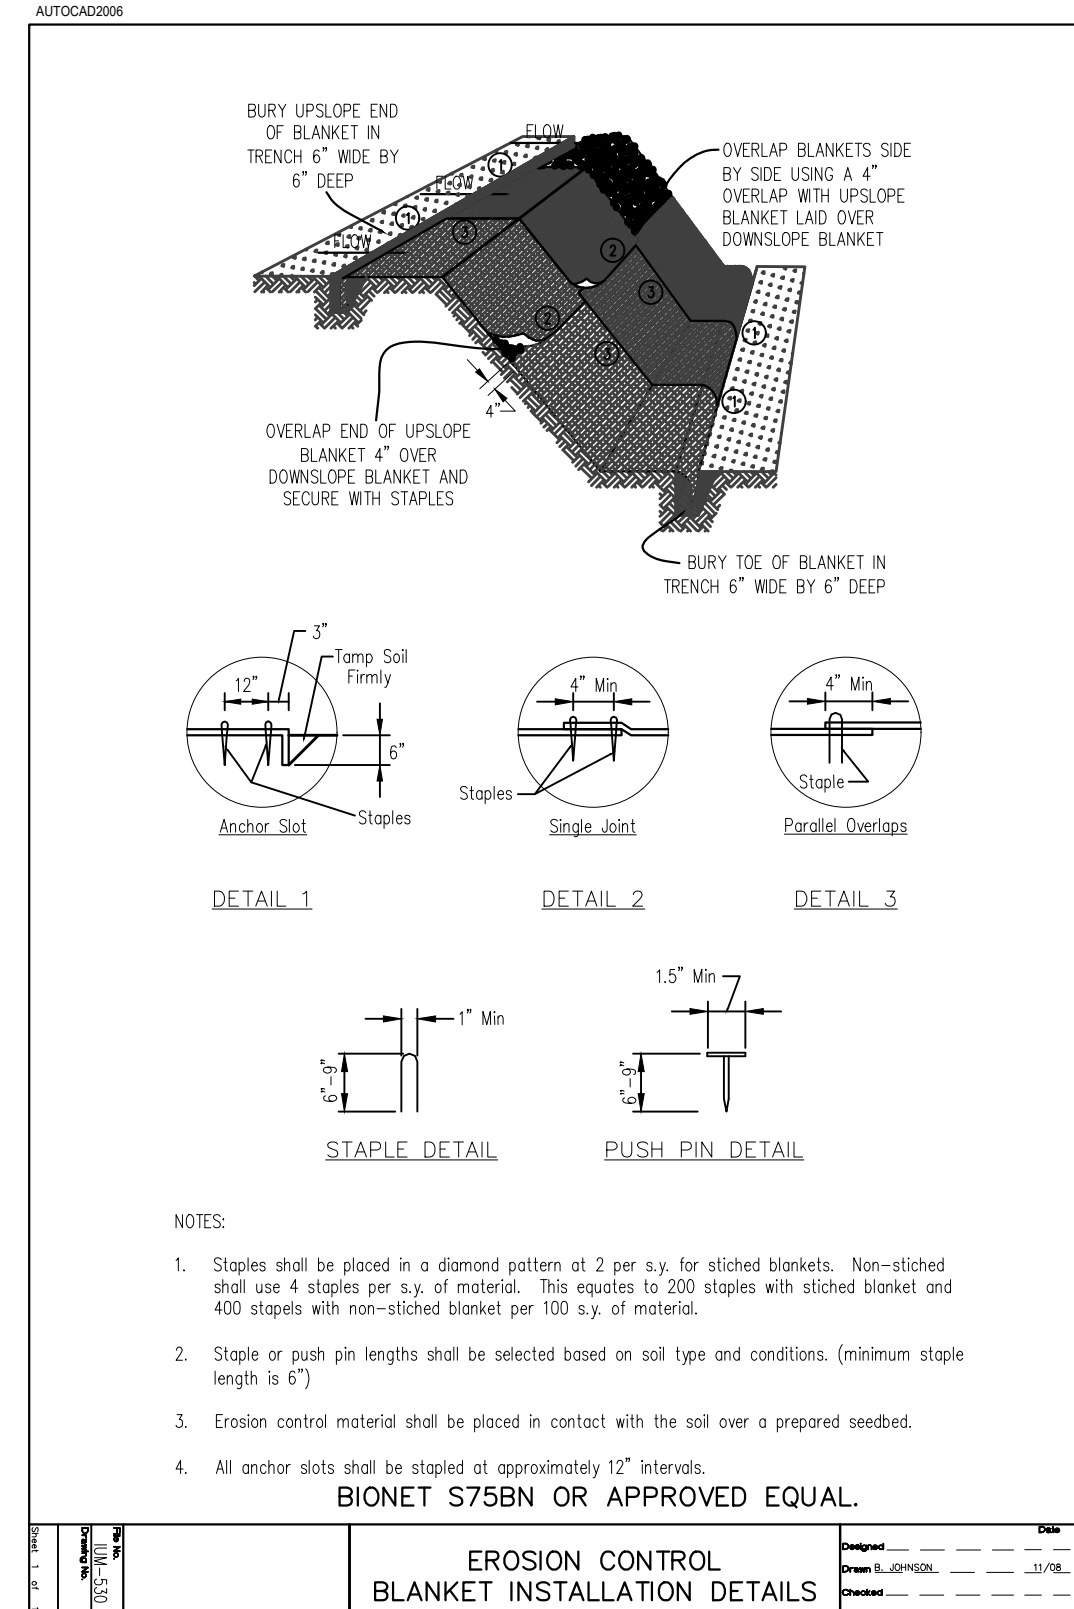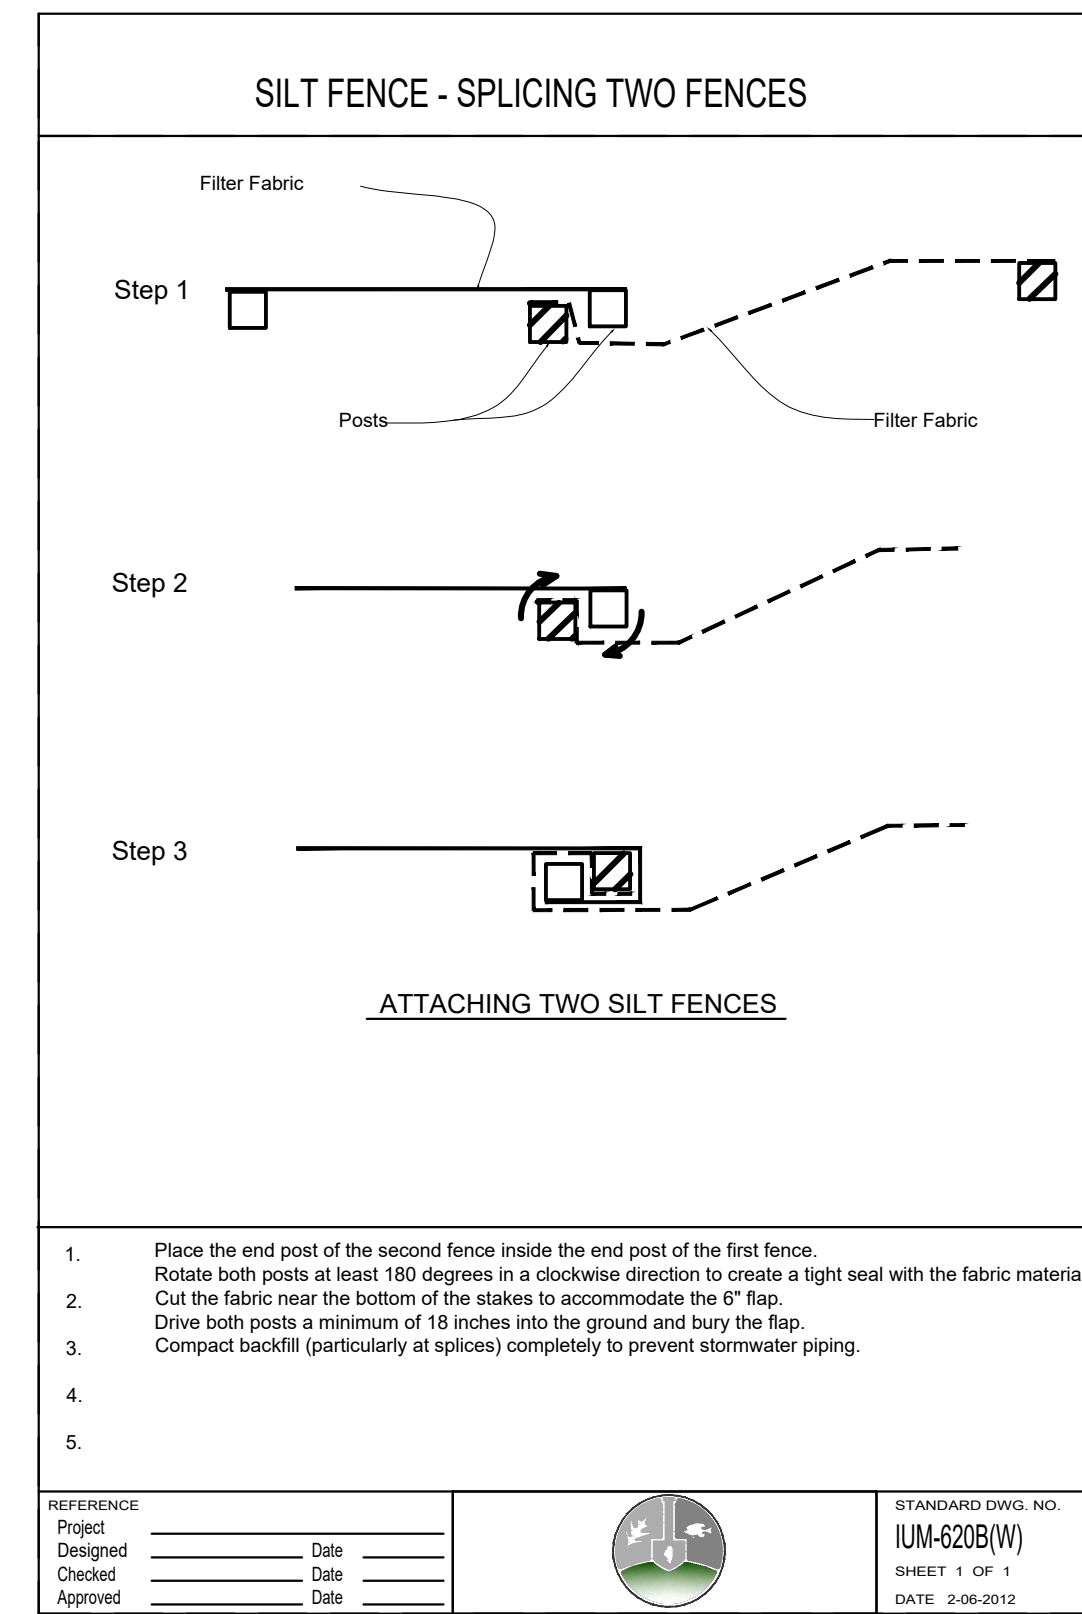STORMWATER POLLUTION PREVENTION PLAN

SHEET NUMBER

L101



NOTE: SCALES DEPICTED ON THIS DRAWING ARE NOT CORRECT UNLESS PLOTTED SHEET SIZE IS 30 X 42 INCHES.

1. It is the responsibility of the Contractor to perform layout of all project elements and points for review by Owner prior to construction. (This work is considered incidental to the project and not paid as a separate bid item).
2. The contractor shall be responsible for all materials and quantities as required to complete the work in accordance with the plans and specifications. The contractor will notify the Owner's Representative in writing of any discrepancies or changes required to complete the work before any action may be taken. All changes or change orders must be approved by the Owner's Representative and Owner before any changes are executed.

REFERENCED SPECIFICATIONS AND CODES

1. The Americans with Disabilities Act and the Illinois Accessibility Code.
2. The Illinois Procedures and Standards for Urban Soil Erosion and Sedimentation Control, and IEPA Standards and Specifications for Soil Erosion and Sedimentation Control.
3. U.S. Soil Conservation Service Field Engineering Handbook
4. All codes and ordinances of the City of Plant, United States Army Corp of Engineers, Illinois Department of Natural Resources, Kendall County Soil and Water Conservation Districts, and all agencies having jurisdiction.
5. All requirements of the Occupational Safety and Health Administration.
6. The cited standard specifications, codes and permits, with these construction plans and details, are all to be considered part of the work, incidental items or accessories necessary to complete this work may not be specifically noted but are considered a part of these improvements.
7. In case of conflict, the more restrictive provision shall apply.

1. Paving grid shall be formed completely and shall smoothly transition into tangents and adjoining lines. Dimensions are to face of curb and edge of pavement unless otherwise specified.
2. Dimensions are in feet or degrees. Dimensions are perpendicular & parallel unless otherwise noted.
3. See Layout Plan, Sheet L300 for additional general notes and referenced specifications and codes.
4. Contractor shall perform all construction layout for the project. Contractor will be provided with an electronic file in AutoCAD format to assist with layout. Neither the Owner nor their representative shall be responsible for setting additional layout points.

1. Finished surfaces to be smooth and even with no abrupt or awkward changes in grade. Paving to meet adjacent grades flush and smooth.
2. Contractor shall restore all areas disturbed as a result of construction.
3. All walks, drives and paved areas are to follow ADA per incorporated specifications. Any deviation shall be removed and reinstated to follow this law.
4. All Accessible Route paving shall not exceed 4.5% in any direction. Cross slopes shall be less than 2%. Contractor shall slope all walks and slabs to eliminate ponding. ADA Turning Radius paving shall be less than 2% in all directions.
5. This work shall include the excavation, stockpile, and placement of topsoil and suitable subgrade material.
6. Follow the Illinois Procedures and Standards for Urban Soil Erosion and Sedimentation Control, IEPA Standards and Specifications for Soil Erosion and Sedimentation Control, and U.S. Soil Conservation Service Field Engineering Handbook.
7. Transitions between paving types (i.e. concrete to asphalt) shall be smooth. Transitions not to exceed 1/4" vertical or horizontal difference.

	Asphalt Paving
	Concrete Paving
	Crushed Limestone Surfacing
	Gravel Surfacing
	Boardwalk
	EJ Concrete Expansion Joints
	Construction Limits / Construction Fence

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APPROVED	ME

SHEET TITLE

LAYOUT PLAN
- OVERALL

SHEET NUMBER

L200











1. See Sheet L200 for Grading Notes


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CONC HEADWALL
W/BOX CULVERT
INV: 606.05

STORM MANHOLE-
RIM: 606.42
T/WATER: 604.92
B/STRUCT: 603.47
NO VISIBLE PIPES

DELINEATED WETLAND
BOUNDARY
(PER FLAGS PLACED BY
ERA ON 10/19/2023)

	Centerline of Trail/Boardwalk
	Asphalt Paving
	Concrete Paving
	Crushed Limestone Surfacing
	Gravel Surfacing
	Boardwalk
	Concrete Expansion Joints
	Construction Limits / Construction Fence

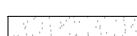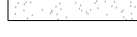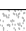

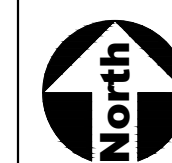SCALE: 1" = 30'-0"

0 15' 30' 60' 90'

A horizontal line with vertical tick marks at 0, 15', 30', 60', and 90'. The segments between 0 and 15', 15' and 30', 30' and 60', and 60' and 90' are shaded with diagonal lines.

NOTE: SCALES DEPICTED ON THIS DRAWING ARE NOT CORRECT UNLESS PLOTTED SHEET SIZE IS 30 X 42 INCHES

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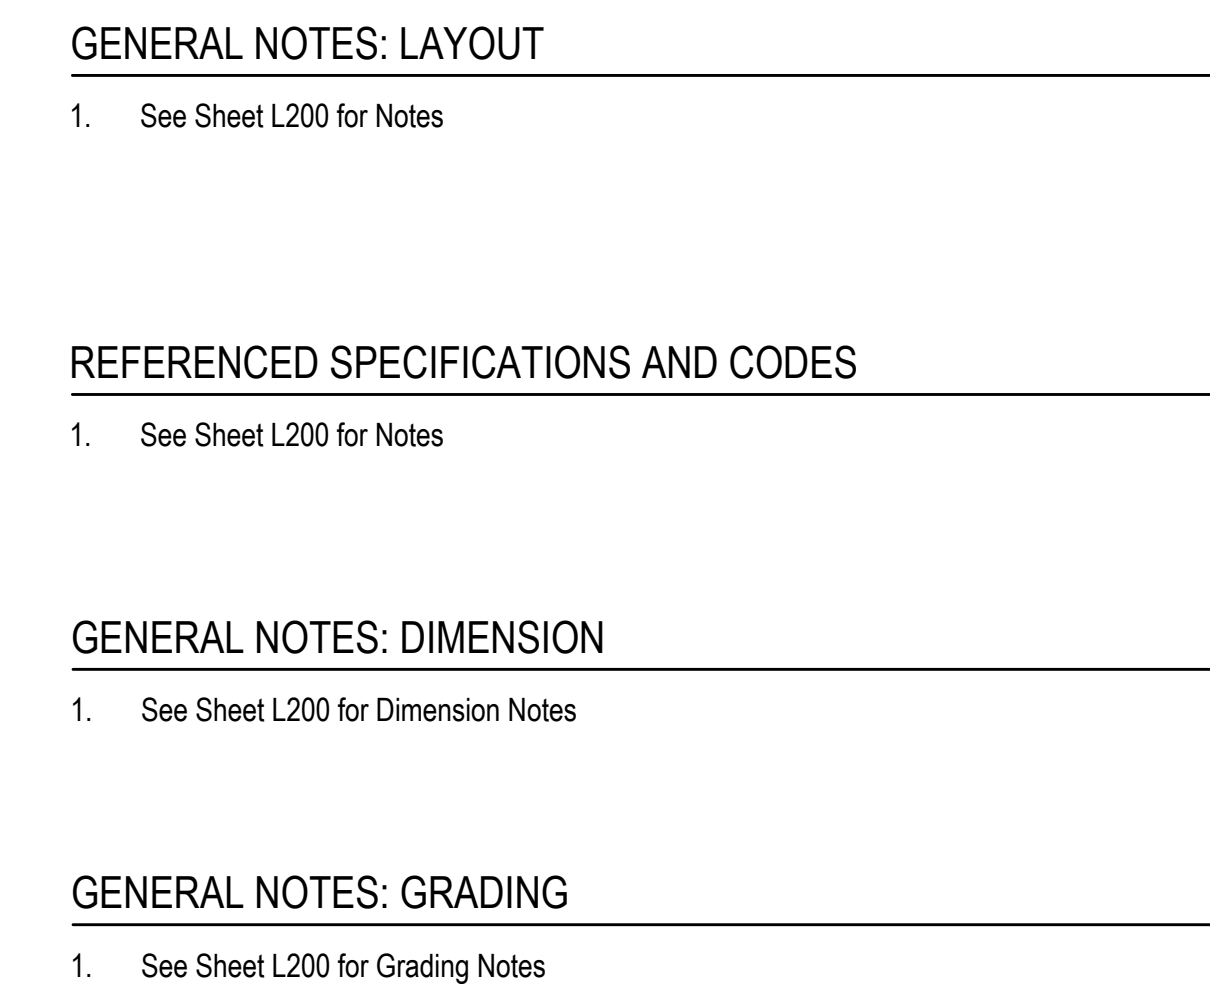
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






**LAYOUT, DIMENSIONS
& GRADING PLAN
- NORTH TRAIL**

SHEET NUMBER

L201



LEGEND

	Asphalt Paving
	Concrete Paving
	Crushed Limestone Surfing
	Gravel Surfacing
	Boardwalk
	Concrete Expansion Joints
	Construction Limits / Construction Fence

North

SCALE: 1" = 30'-0"

0 15' 30' 60' 90'

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**LAYOUT, DIMENSION
& GRADING PLAN
- SOUTH TRAIL**

SHEET NUMBER








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


1. See Sheet L200 for Referenced Specification and Codes

CONIC

SIC

	Asphalt Paving
	Concrete Paving
	Crushed Limestone Surfacing
	Gravel Surfacing
	Boardwalk
	EJ Concrete Expansion Joints
	Construction Limits / Construction Fence




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SHEET TITLE
LAYOUT PLAN - PARKING LOT ENLARGEMENT

SHEET NUMBER

L203


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1. See Sheet L200 for Notes

1. See Sheet L200 for Notes

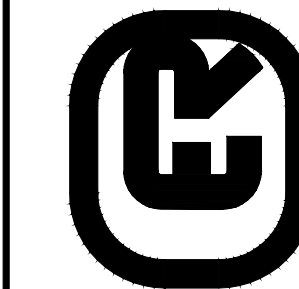
	Asphalt Paving
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NOTE: SCALES DEPICTED ON THIS DRAWING ARE NOT CORRECT UNLESS PLOTTED SHEET SIZE IS 30 X 42 INCHES.

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Warrenville, Illinois 60555
IL License 184-001186

[illegible]

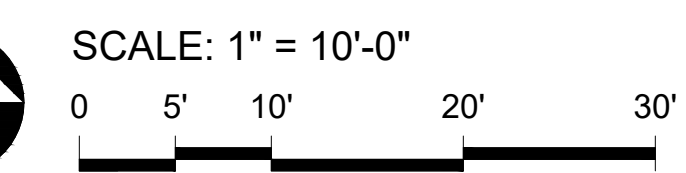JOB NO.	23-429-149
DRAWN	EM
CHECKED	MH
APPROVED	MH

SHEET TITLE







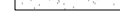
**LAYOUT PLAN
- NATURE CENTER
ENLARGEMENT**


SHEET NUMBER

L204



1. See Sheet L200 for Dimension Notes

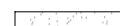	Asphalt Paving
	Concrete Paving
	Crushed Limestone Surfacing
	Gravel Surfacing
	Boardwalk
	EJ Concrete Expansion Joints
	CL Construction Limits / Construction Fence

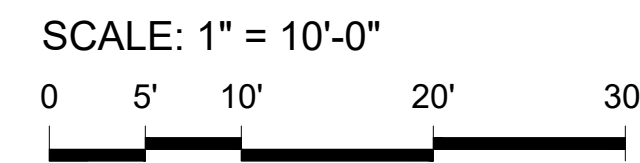


NOTE: SCALES DEPICTED ON THIS DRAWING ARE NOT CORRECT UNLESS PLOTTED SHEET SIZE IS 30 X 42 INCHES

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JOB NO.	23-429-14
DRAWN	
CHECKED	
APPROVED	

SHEET TITLE

**DIMENSION PLAN
- PARKING LOT
ENLARGEMENT**


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

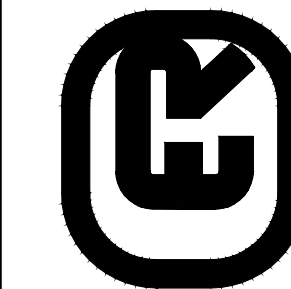


GENERAL NOTES: DIMENSION

1. See Sheet L200 for Dimension Notes

Point of beginning is the south corner of existing building. Layout Line C is parallel to the existing south edge of building. Layout Line D is perpendicular to Layout Line C.

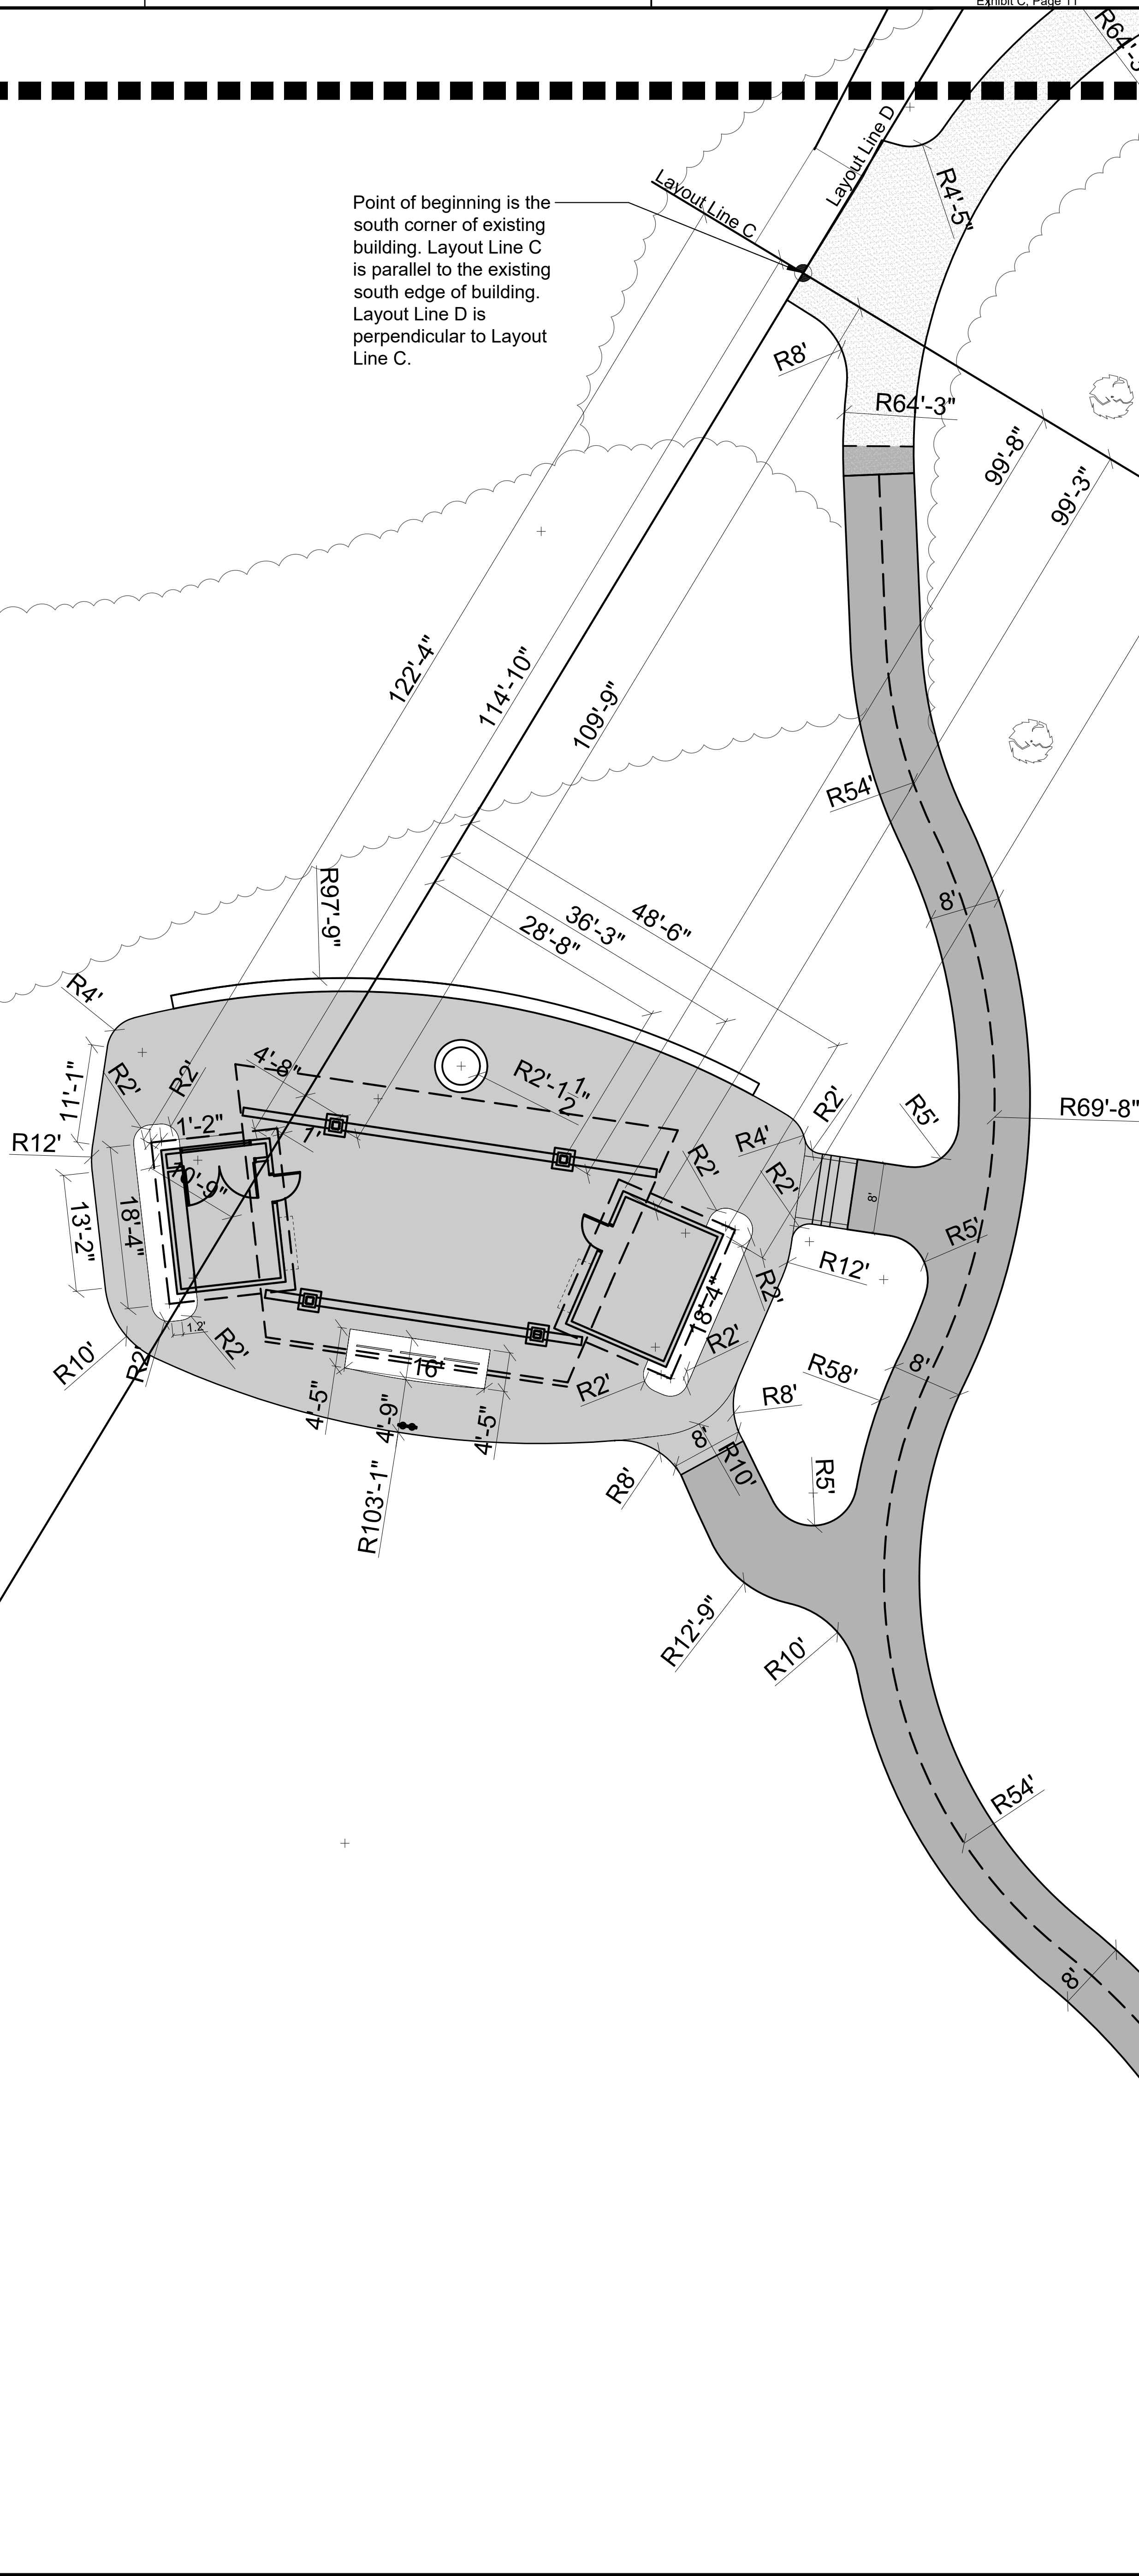

LEGEND

- | | |
|---------------------------------------------------------------------------------------|------------------------------------------|
|  | Asphalt Paving |
|  | Concrete Paving |
|  | Crushed Limestone Surfacing |
|  | Gravel Surfacing |
|  | Boardwalk |
| EJ | Concrete Expansion Joints |
| CL | Construction Limits / Construction Fence |



SCALE: 1" = 10'-0"



NOTE: SCALES DEPICTED ON THIS DRAWING ARE NOT CORRECT UNLESS PLOTTED SHEET SIZE IS 30 X 42 INCHES

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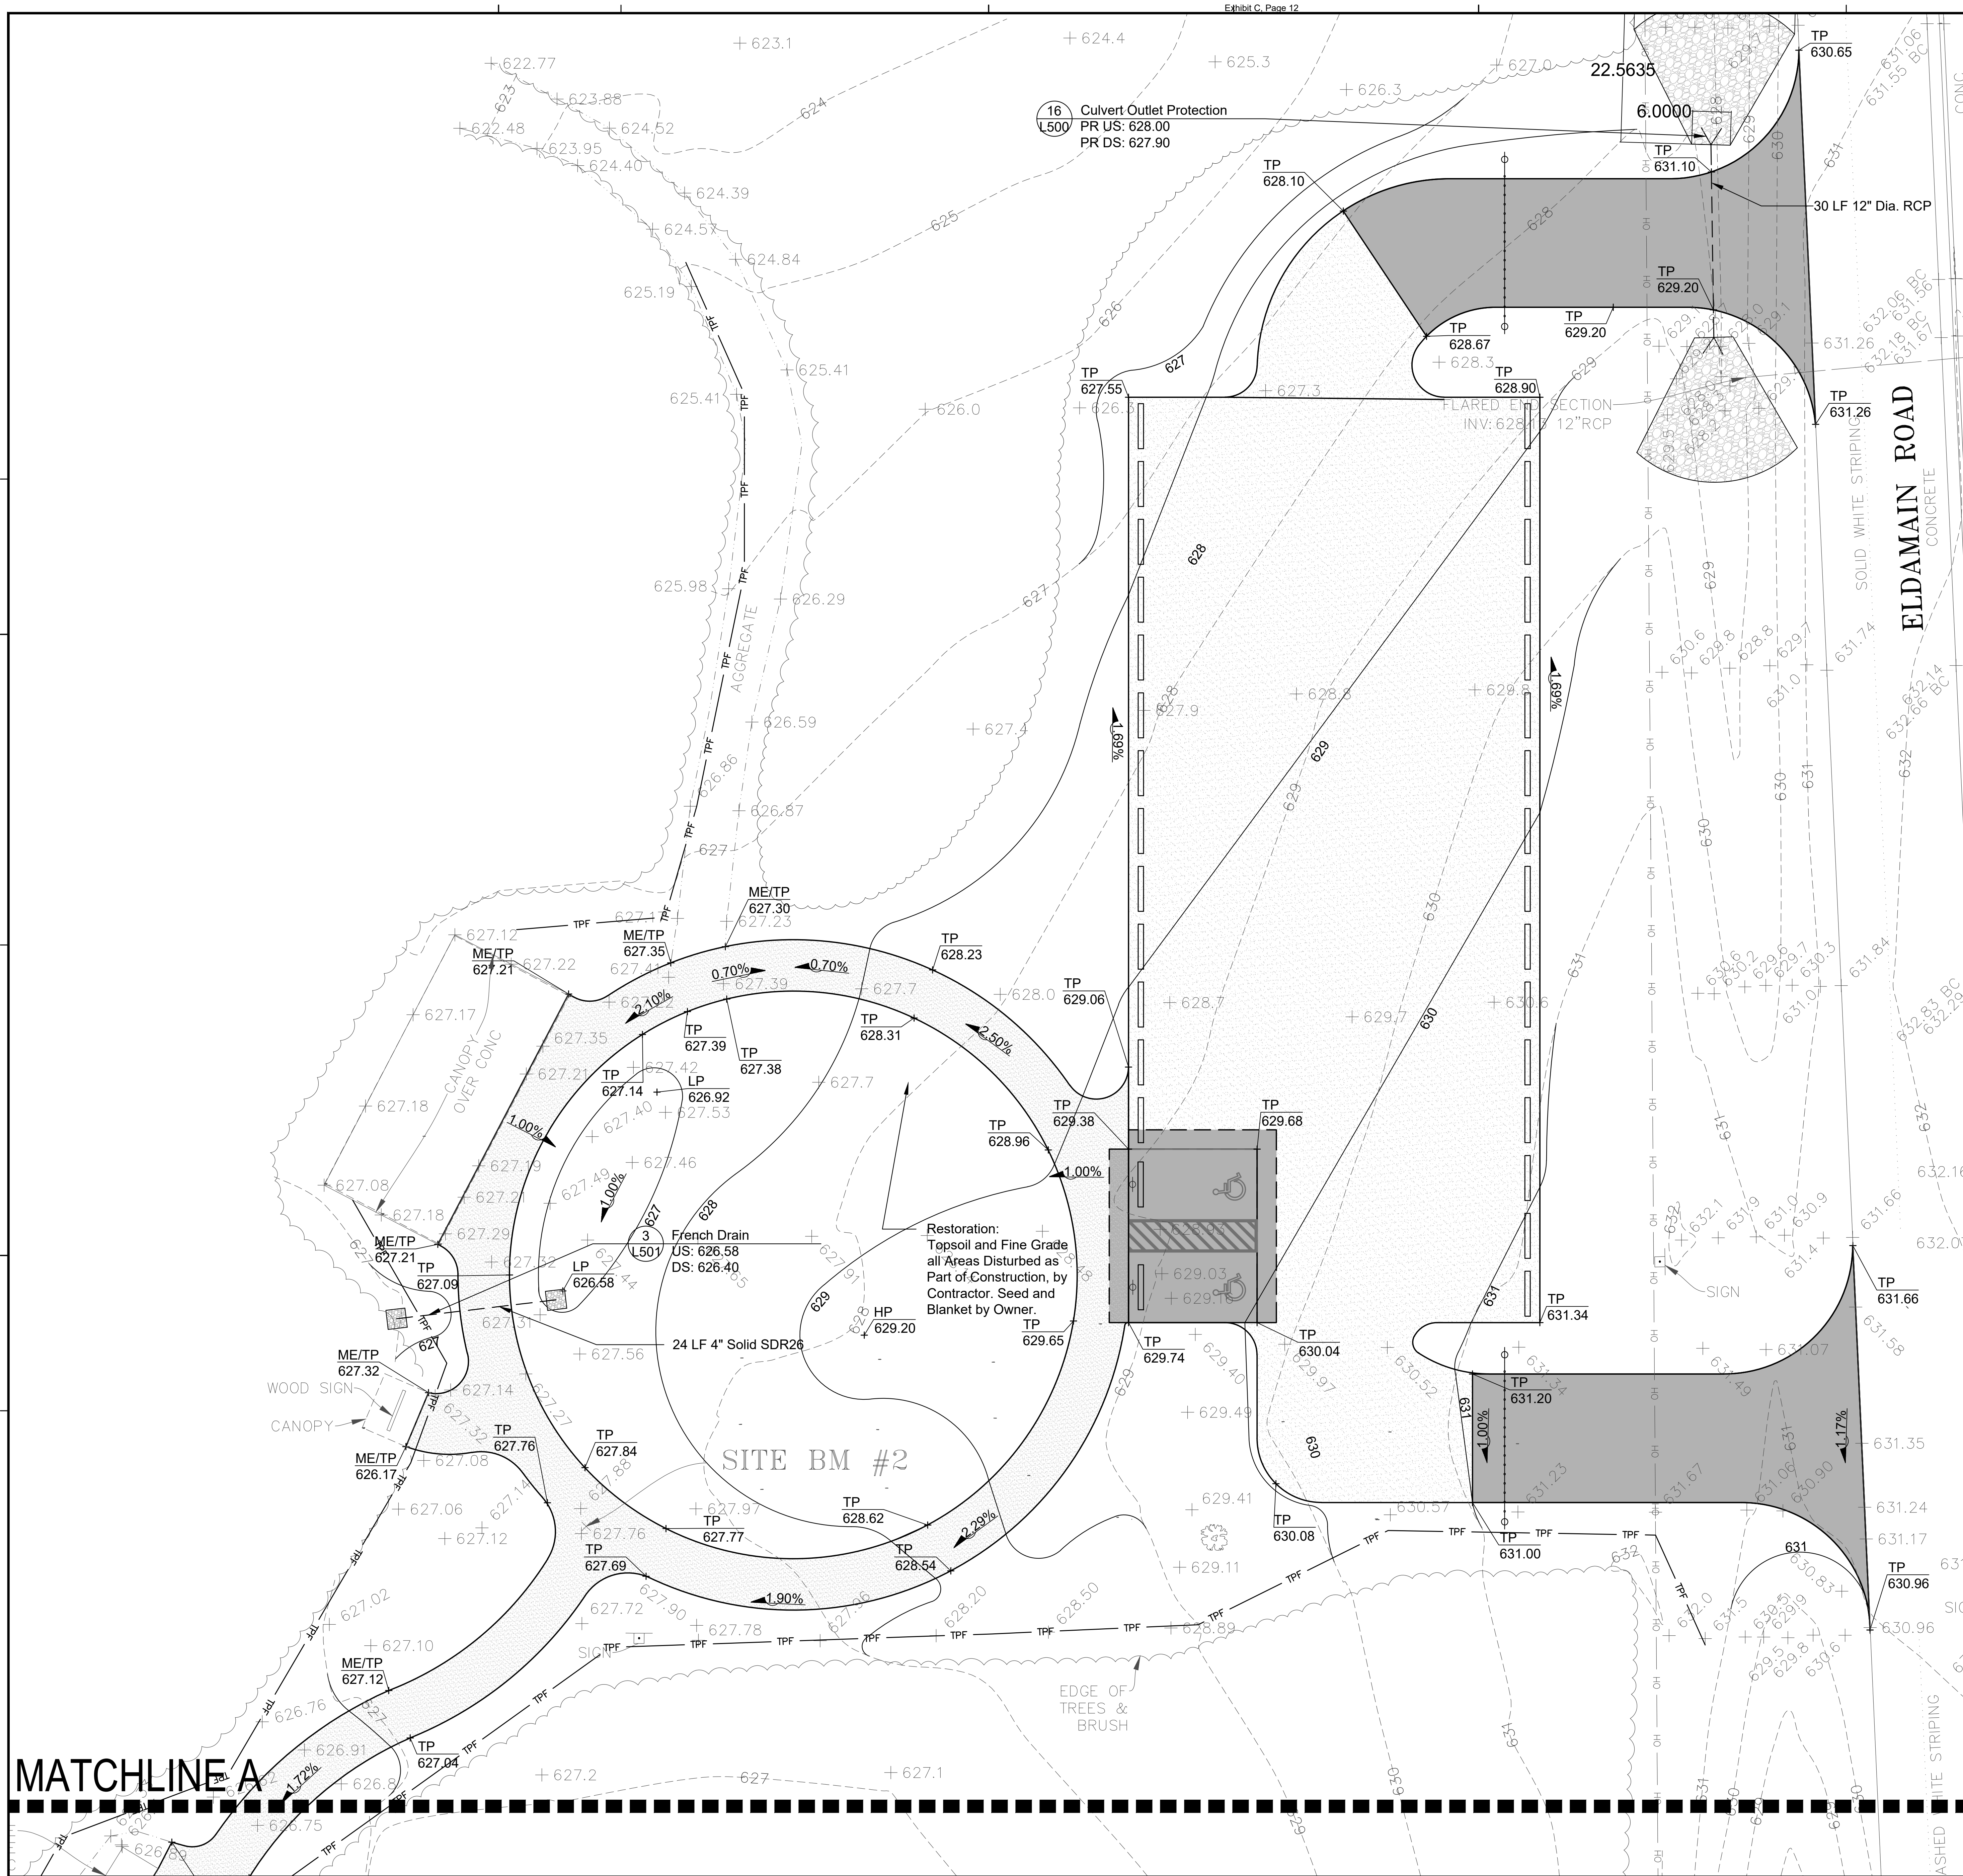
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DRAWN	E
CHECKED	M
APPROVED	M

SHEET TITLE

**DIMENSION PLAN
- NATURE CENTER
ENLARGEMENT**

SHEET NUMBER

L302



GENERAL NOTES: GRADING

- See Sheet L200 for Grading Notes.

LEGEND

- 681 Existing Contour Line
- 681 Proposed Contour Line
- + 685.35 Existing Spot Elevation
- + 689.66 Proposed Spot Elevation
- 2% Drainage Flow Direction
- CL Construction Limits / Construction Fence

INDEX OF ACRONYMS AND ABBREVIATIONS

- HP - High Point
- INV - Pipe Invert Elevation
- LP - Low Point
- ME - Match Existing Elevation
- RIM - Top of Rim Elevation
- TC - Top of Curb
- TP - Top of Pavement
- TW - Top of Wall



SCALE: 1" = 10'-0"

0 5' 10' 20' 30'

NOTE: SCALES DEPICTED ON THIS DRAWING ARE NOT CORRECT UNLESS PLOTTED SHEET SIZE IS 30 X 42 INCHES.

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DATE	DESCRIPTION
04/11/24	BID DOCUMENTS

JOB NO. 23-429-1495
DRAWN EM
CHECKED MK
APPROVED MK

SHEET TITLE

GRADING PLAN
- PARKING LOT
ENLARGEMENT







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L401




1. See Sheet L200 for Grading Notes

LEGEND

- | | |
|---------------------------------------------------------------------------------------|------------------------------------------|
|  | Existing Contour Line |
|  | Proposed Contour Line |
|  | Existing Spot Elevation |
|  | Proposed Spot Elevation |
|  | Drainage Flow Direction |
|  | Construction Limits / Construction Fence |

INDEX OF ACRONYMS AND ABBREVIATIONS

- HP - High Point
INV - Pipe Invert Elevation
LP - Low Point
ME - Match Existing Elevation
RIM - Top of Rim Elevation
TC - Top of Curb
TP - Top of Pavement
TW - Top of Wall

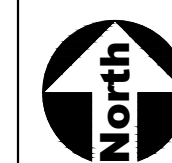

SCALE: 1" = 10'-0"



NOTE: SCALES DEPICTED ON THIS DRAWING ARE NOT CORRECT UNLESS PLOTTED SHEET SIZE IS 30 X 42 INCHES.

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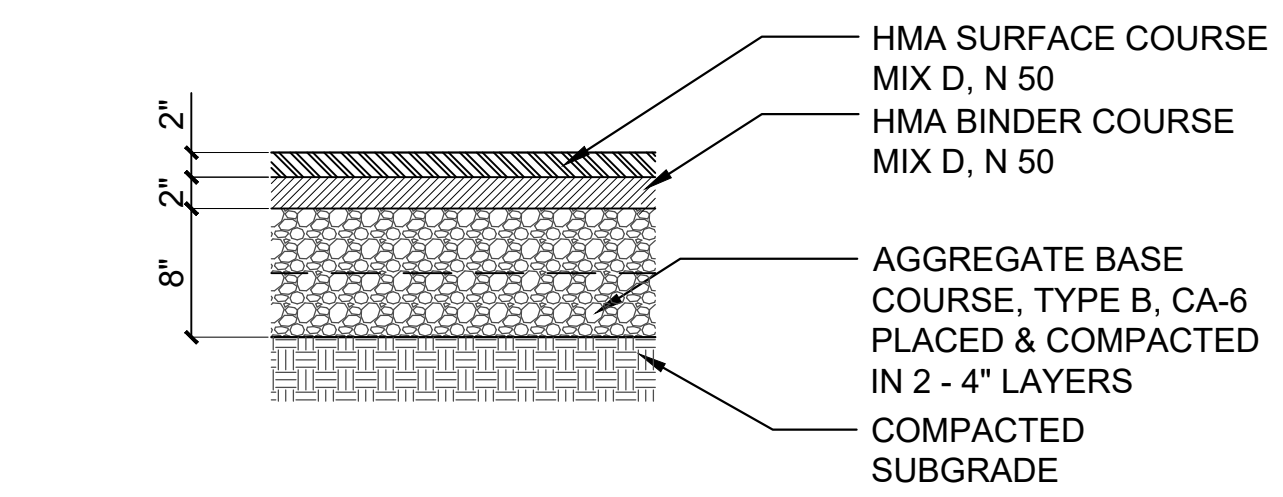
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APPROVED	MK

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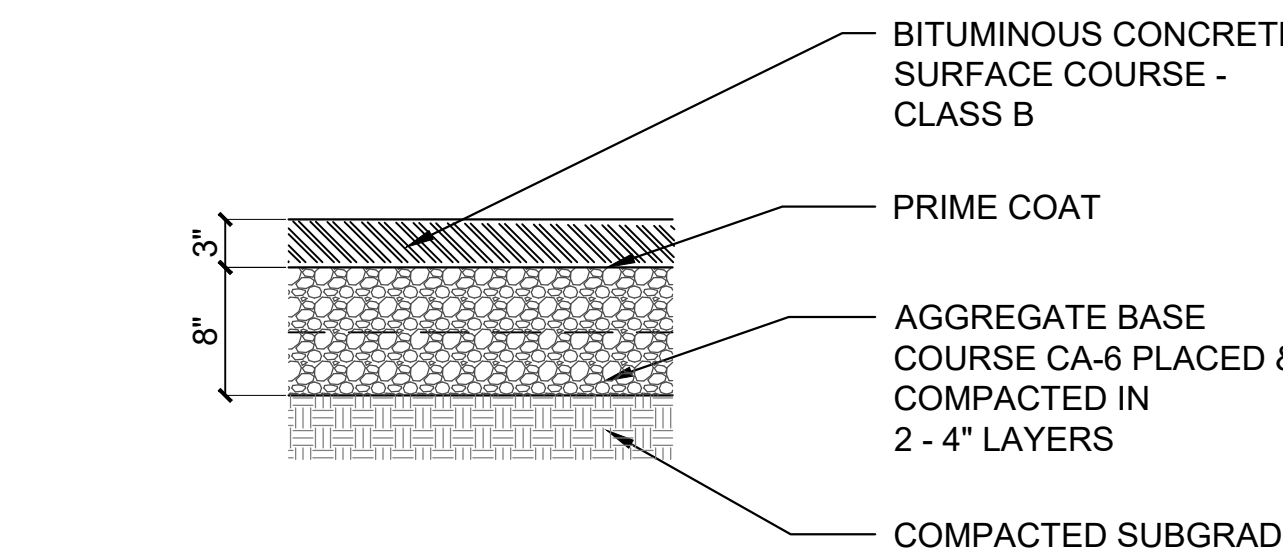
**GRADING PLAN
- NATURE CENTER
ENLARGEMENT**

SHEET NUMBER


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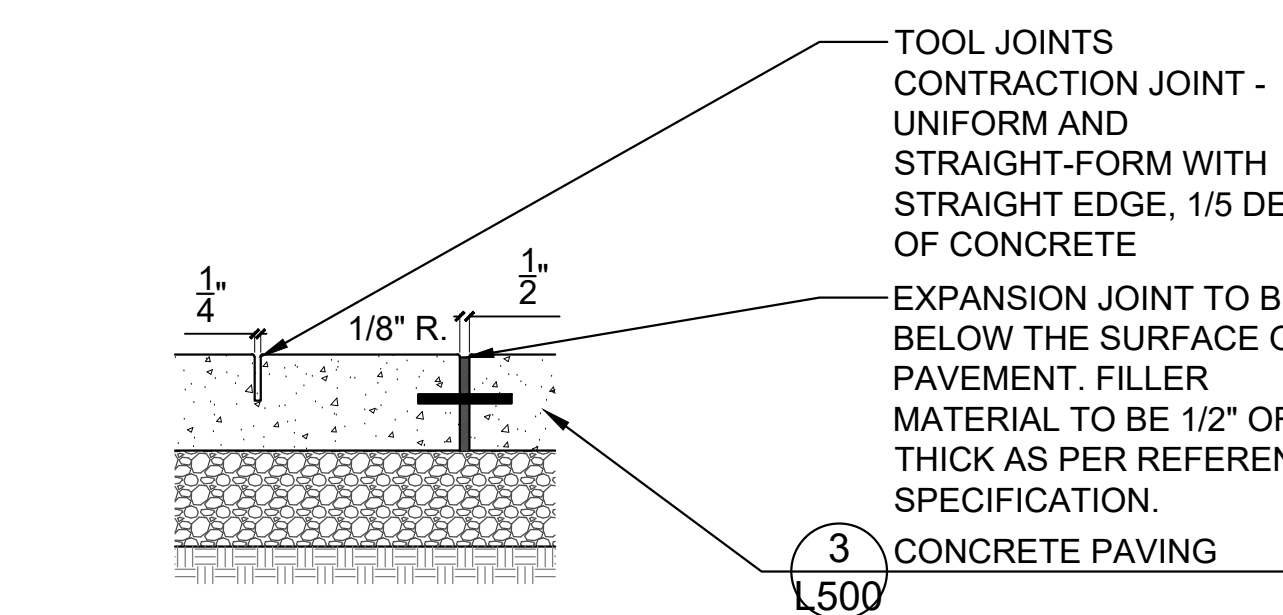
1 Asphalt Paving - Parking
SCALE: 1"=1'-0"
detail drawing sorted.dwg



2 Asphalt Paving - Trail
SCALE: 1"=1'-0"
d-asph_trail_12.dwg




3 Concrete Paving
SCALE: 1 1/2"=1'-0"
d-conc pav-5_8

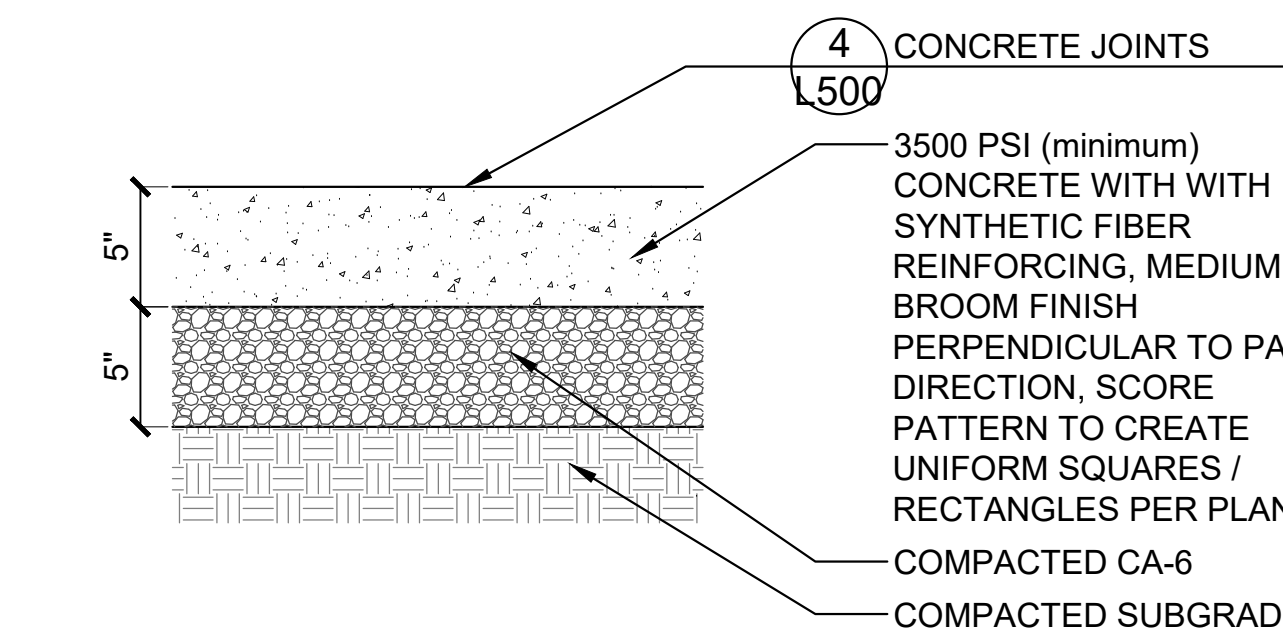


- NOTES:
- JOINTS PLAN TAKES PRIORITY OVER NOTES EXCEPT FOR MAXIMUM SPACING.
 - CONTRACTION JOINTS TO BE PLACED 10' O.C. MAXIMUM
 - EXPANSION JOINTS TO BE PLACED 30' O.C. MAXIMUM
 - PLACE EXPANSION JOINTS BETWEEN NEW CONCRETE POURS AND INSTALL 8" EPOXY COATED BARS, 12" O.C.
 - CURB JOINTS TO MATCH CONCRETE PAVING WHERE APPLICABLE
 - INSTALL SMOOTH DOWELS AT EXPANSION JOINTS
 - NO "CALIFORNIA JOINTS"

4 Concrete Joints
SCALE: 1 1/2"=1'-0"
d-conc_joints_8.dwg

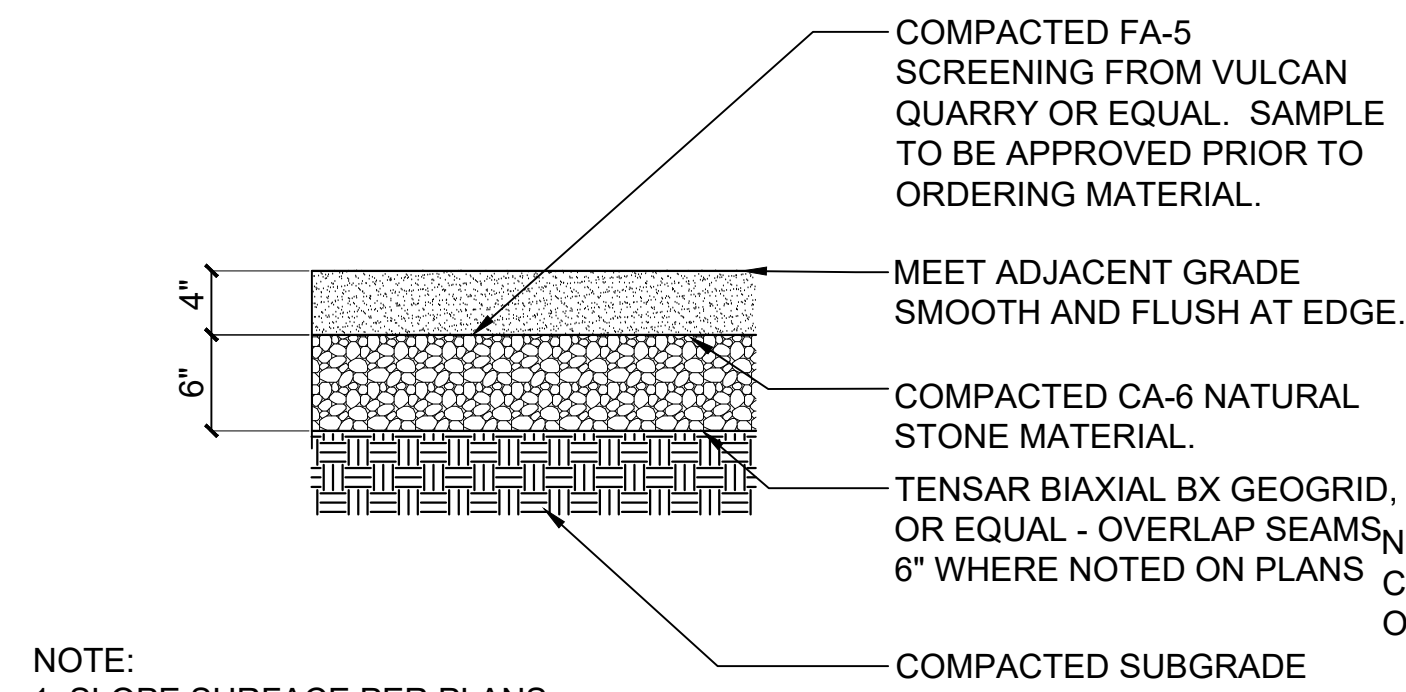


- NOTE:
- SLOPE SURFACE PER PLANS.
 - MAXIMUM CROSS SLOPE TO BE 1.5% MAXIMUM.
 - GEOTEXTILE PER BID QUANTITY - OR LESS IF NOT APPROVED BY OWNER'S REP; PLACE AT AREAS OF UNSUITABLE SUBGRADE.
 - COMPOSITION TO BE 90% MINIMUM.


5 Crushed Limestone Trail
SCALE: 1"=1'-0"
Limestone-FA5 A

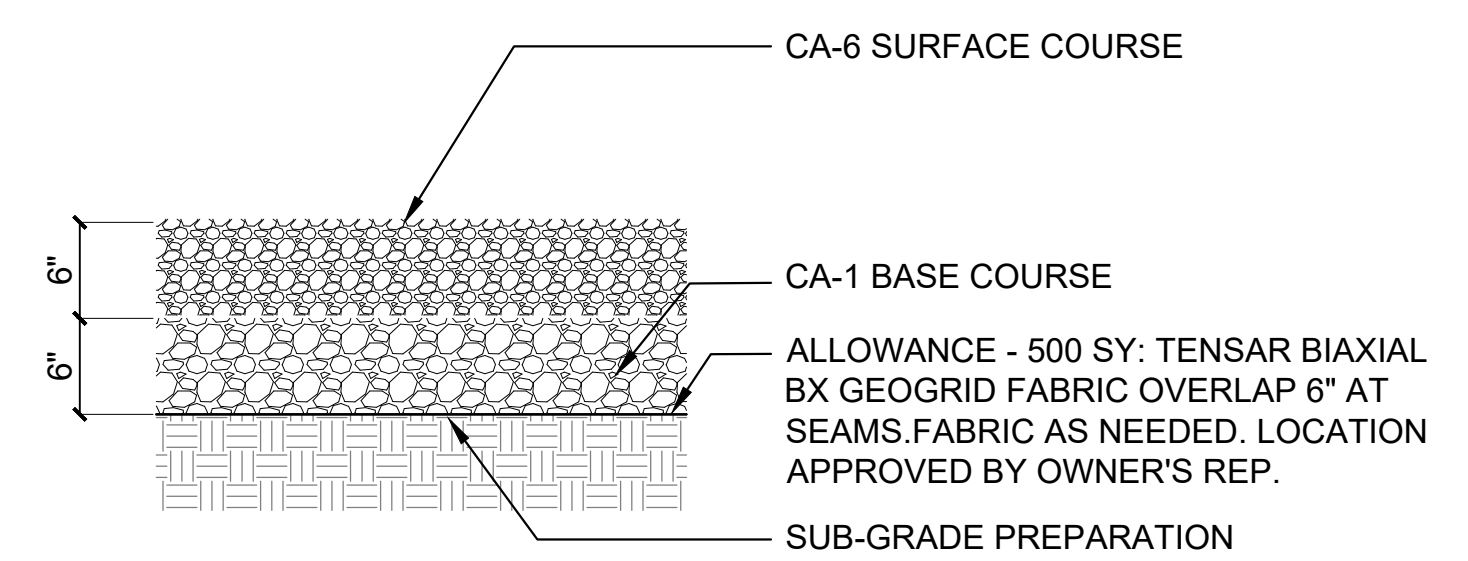


6 12" Gravel Parking Lot
SCALE: 1"=1'-0"
12 gravel CA6_1_12

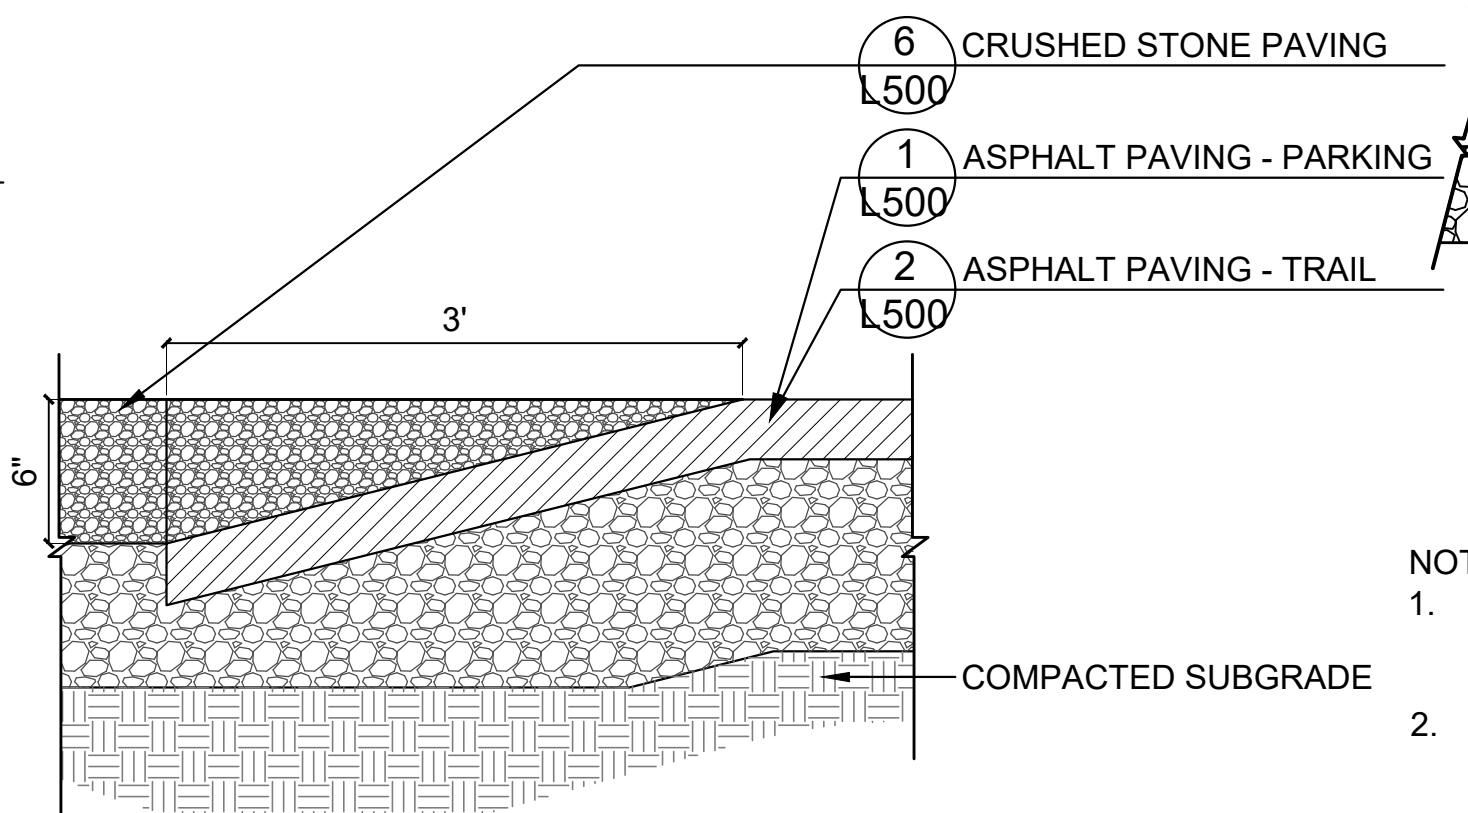


7 Asphalt to Stone Transition
SCALE: 1 1/2"=1'-0"
d-asph-gravel transition_8

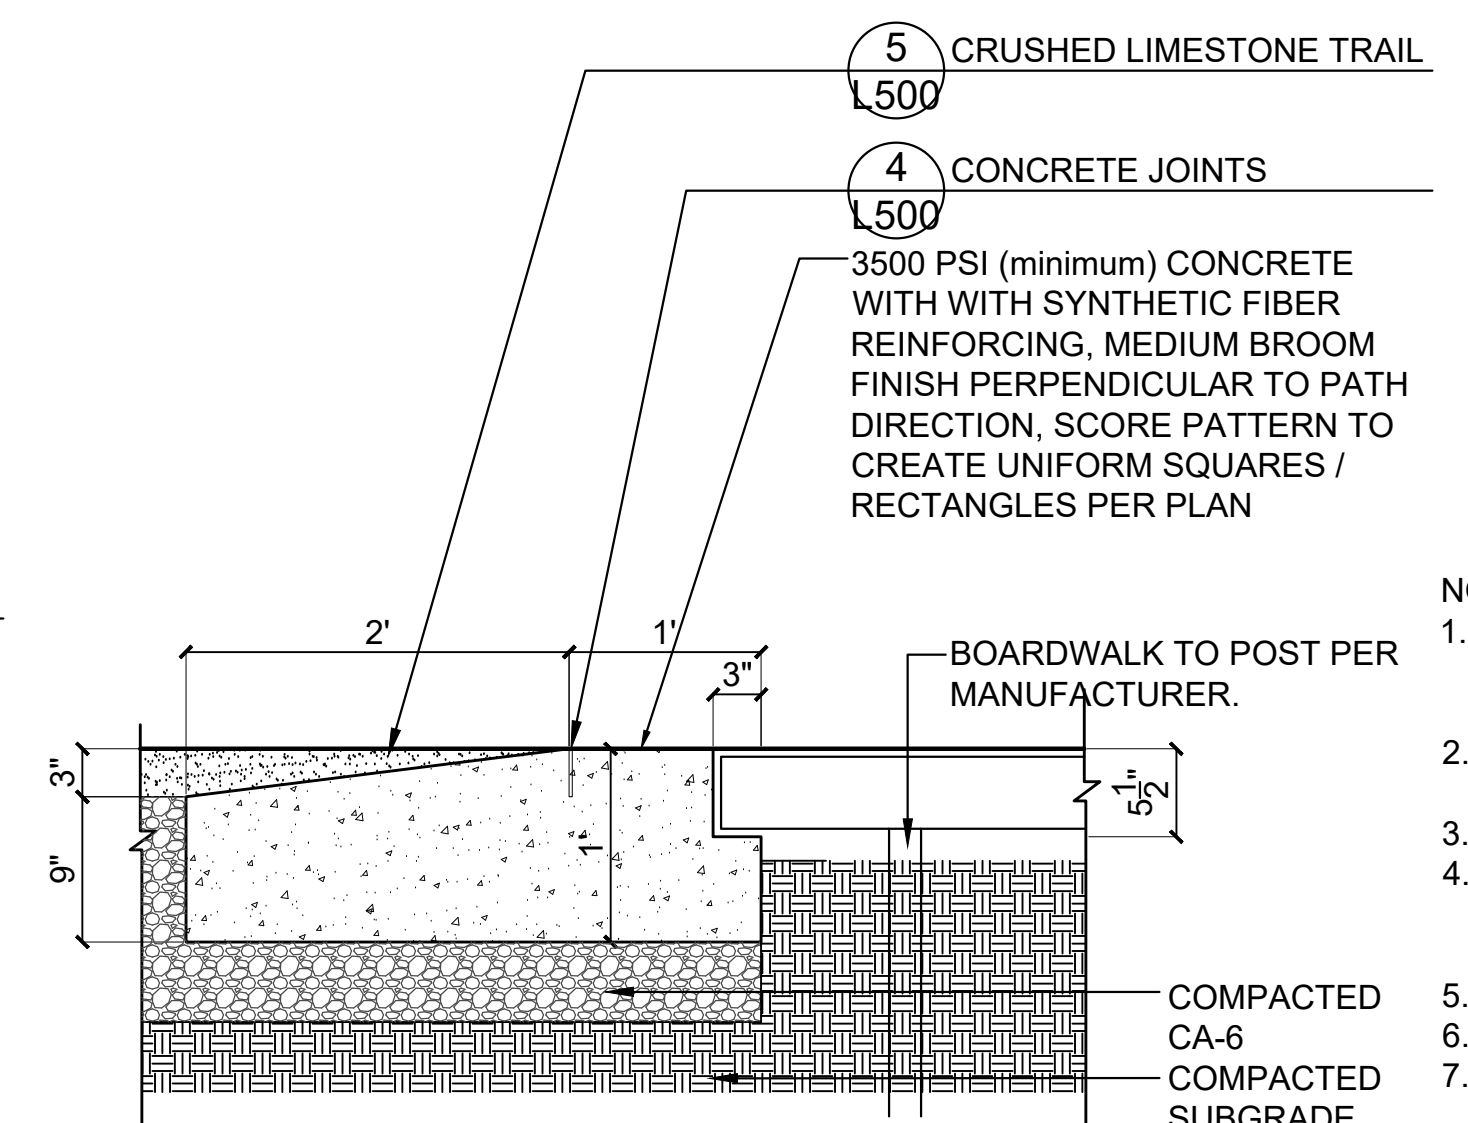


8 Boardwalk Transition
SCALE: Not to Scale
CRing-FirePit

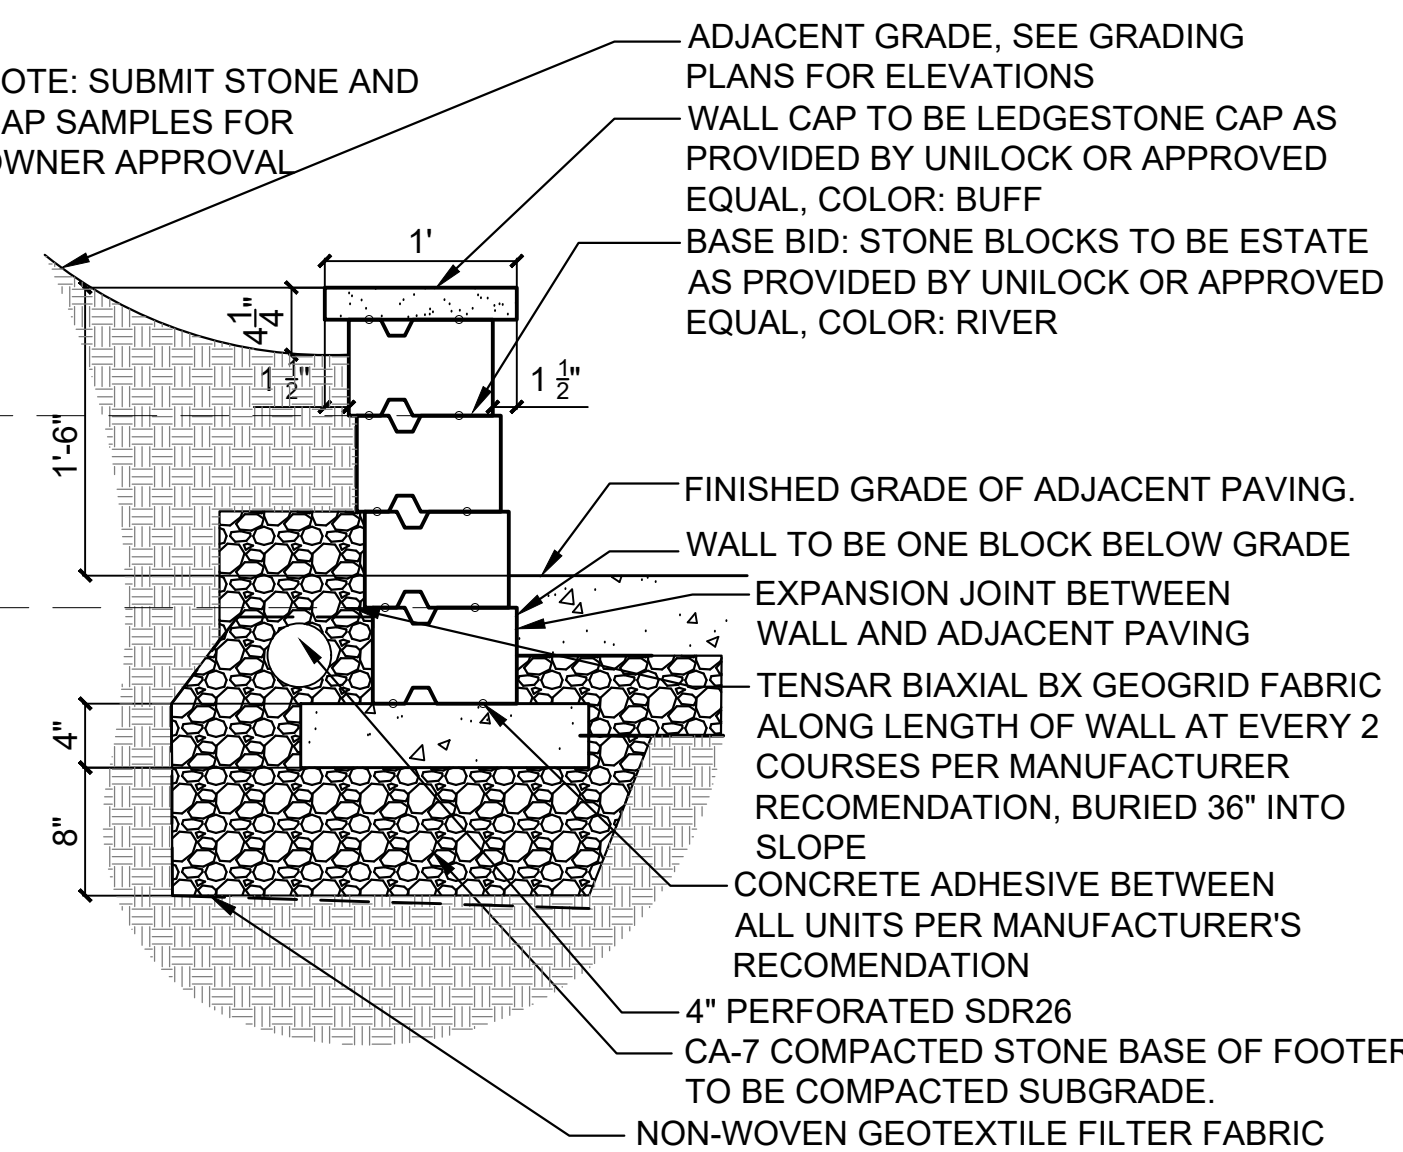

9 Unit Retaining Wall
SCALE: Not to Scale
d-limestone seat wall-2 sides

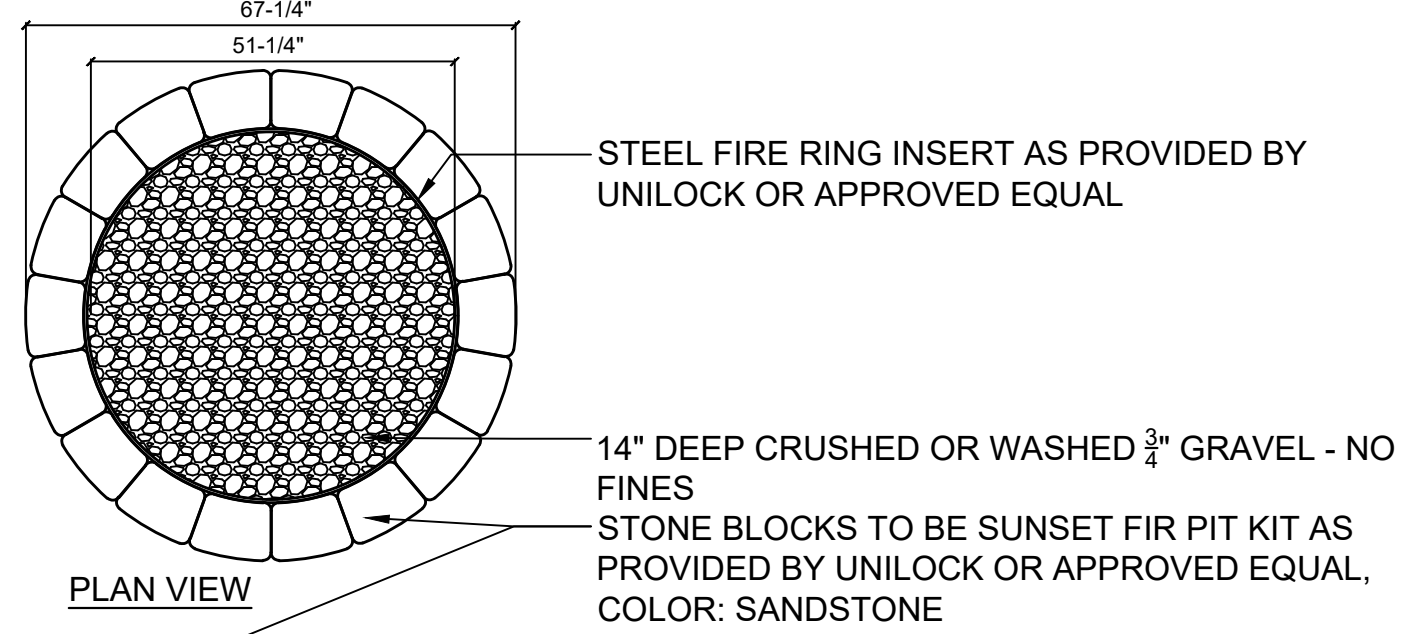


10 Unit Block Fire Pit
SCALE: Not to Scale
CRing-FirePit

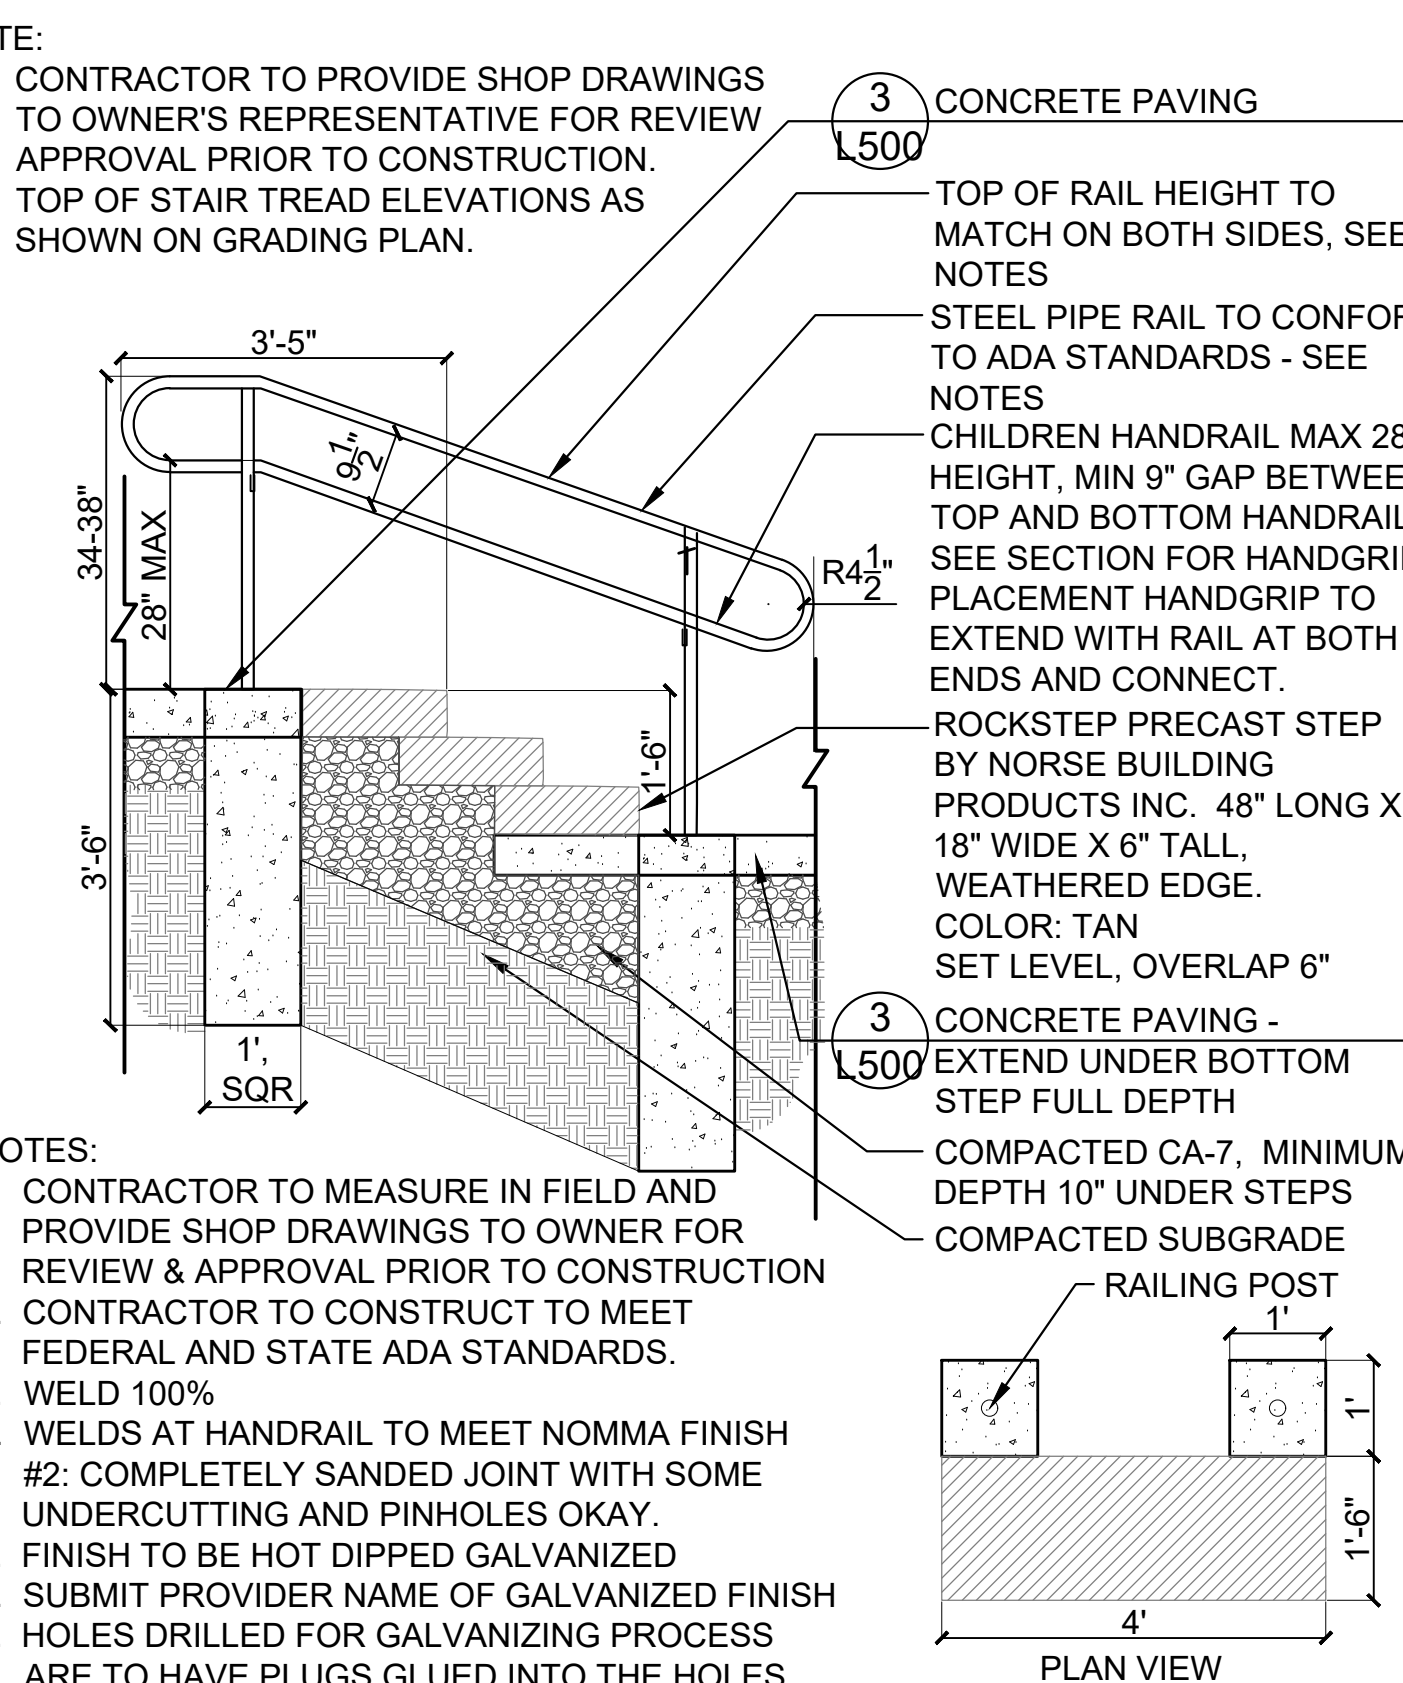


- NOTES:
- CONTRACTOR TO MEASURE IN FIELD AND PROVIDE SHOP DRAWINGS TO OWNER FOR REVIEW & APPROVAL PRIOR TO CONSTRUCTION
 - CONTRACTOR TO CONSTRUCT TO MEET FEDERAL AND STATE ADA STANDARDS.
 - WELD 100%
 - WELDS AT HANDRAIL TO MEET NOMMA FINISH #2; COMPLETELY SANDED JOINT WITH SOME UNDERCUTTING AND PINHOLES OKAY.
 - FINISH TO BE HOT DIPPED GALVANIZED
 - SUBMIT PROVIDER NAME OF GALVANIZED FINISH
 - HOLES DRILLED FOR GALVANIZING PROCESS ARE TO HAVE PLUGS GLUED INTO THE HOLES


11 Stairs and Handrail
SCALE: 1"= 1/2"
d-stairs_hillside

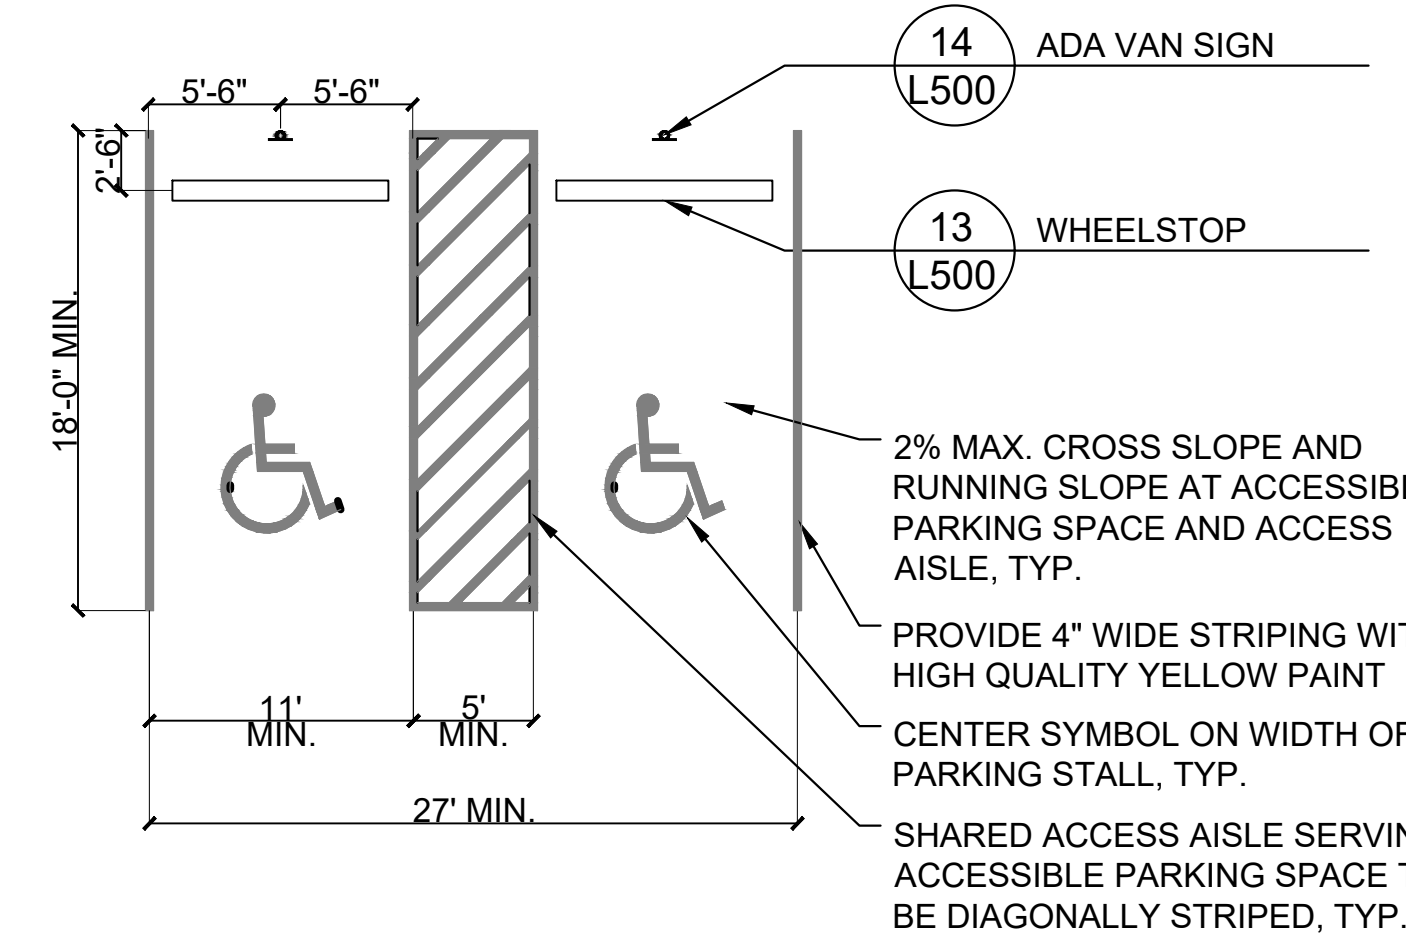


12 Multiple Access ADA Parking
SCALE: 1/8"=1'-0"
d-ADA Parking_96

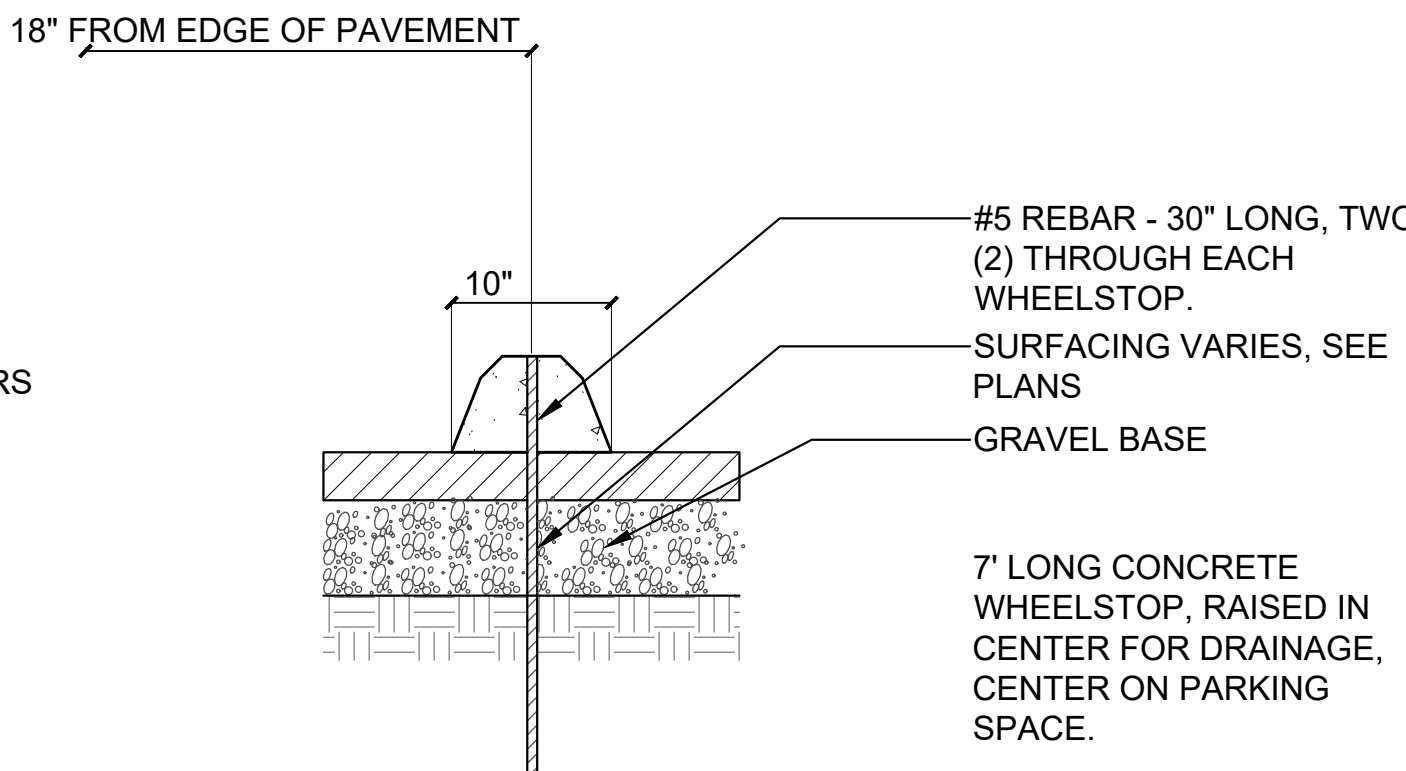


13 Wheelstop
SCALE: 1"=1'-0"
wheelstop_1_12

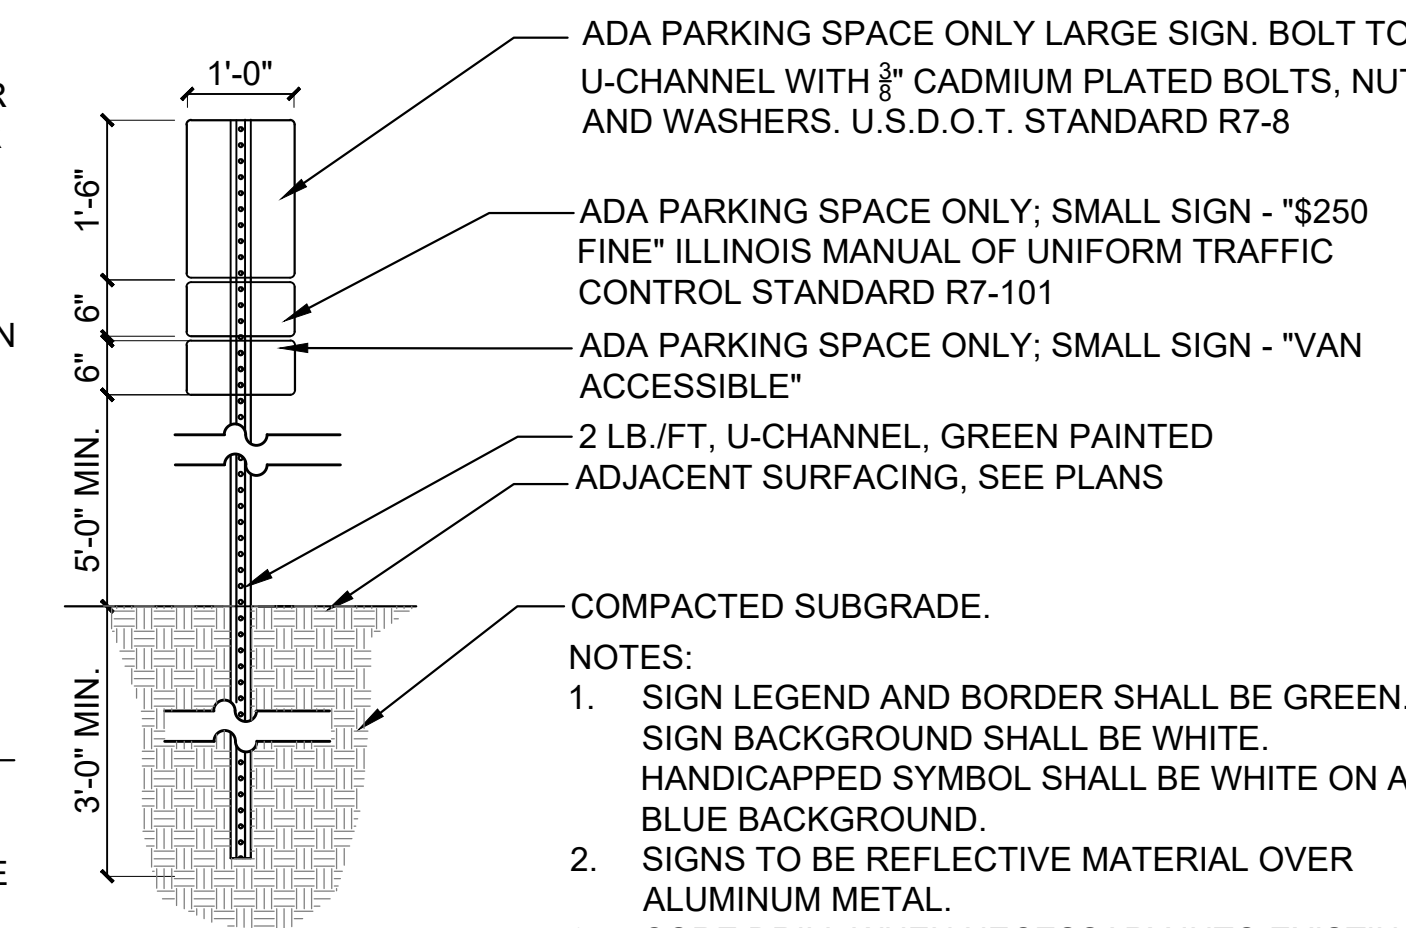


14 ADA Van Sign
SCALE: N.T.S.
d-sign_ada van metal_12.dwg

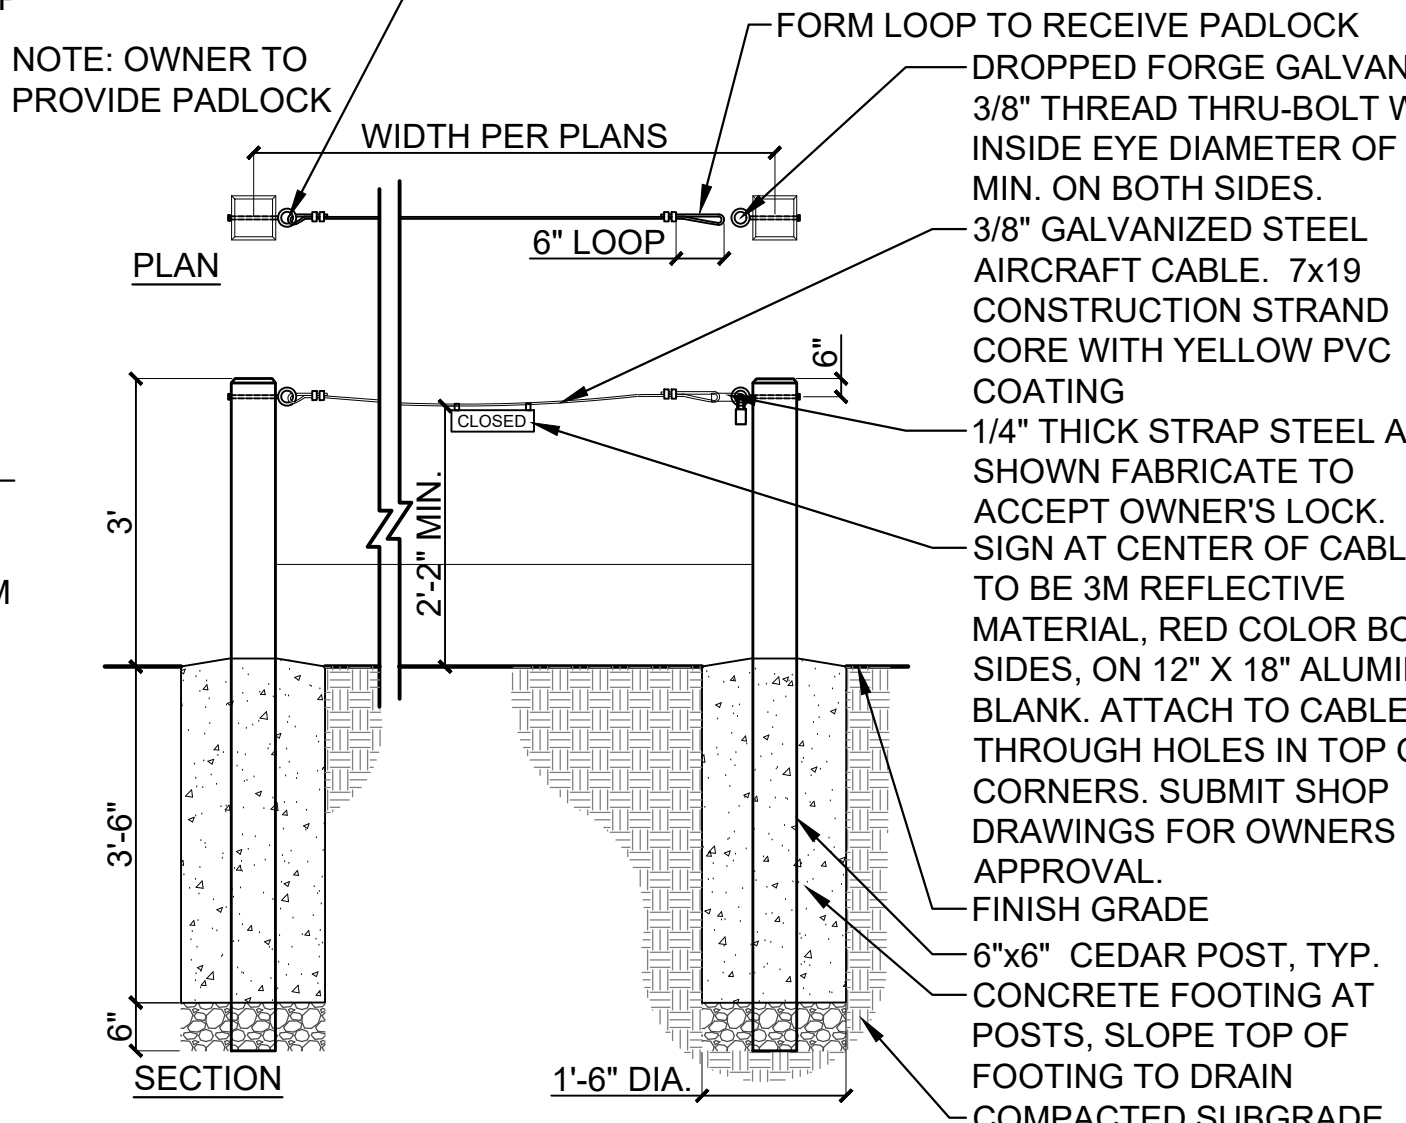


15 Cable Gate
SCALE: 1/2"=1'-0"
d-cable gate_24

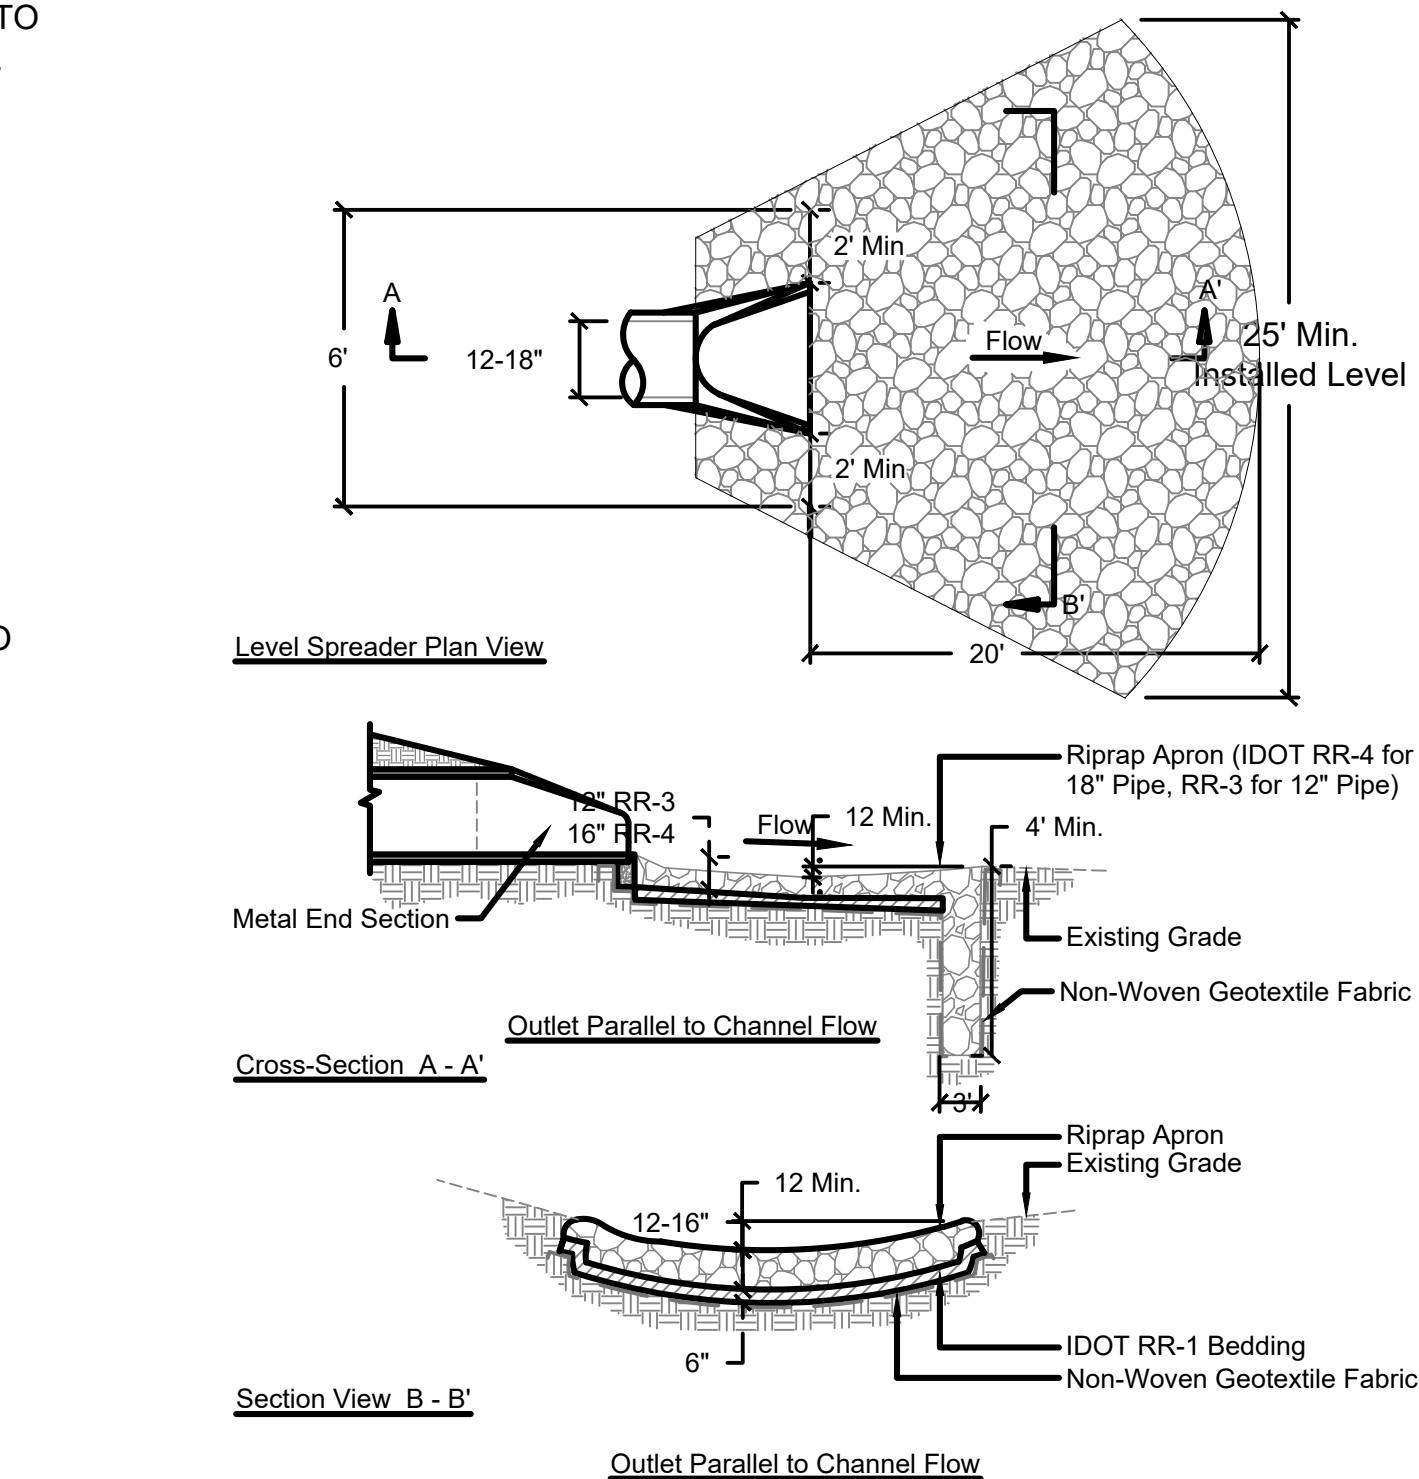

16 Culvert Outlet Protection
(Not to Scale)

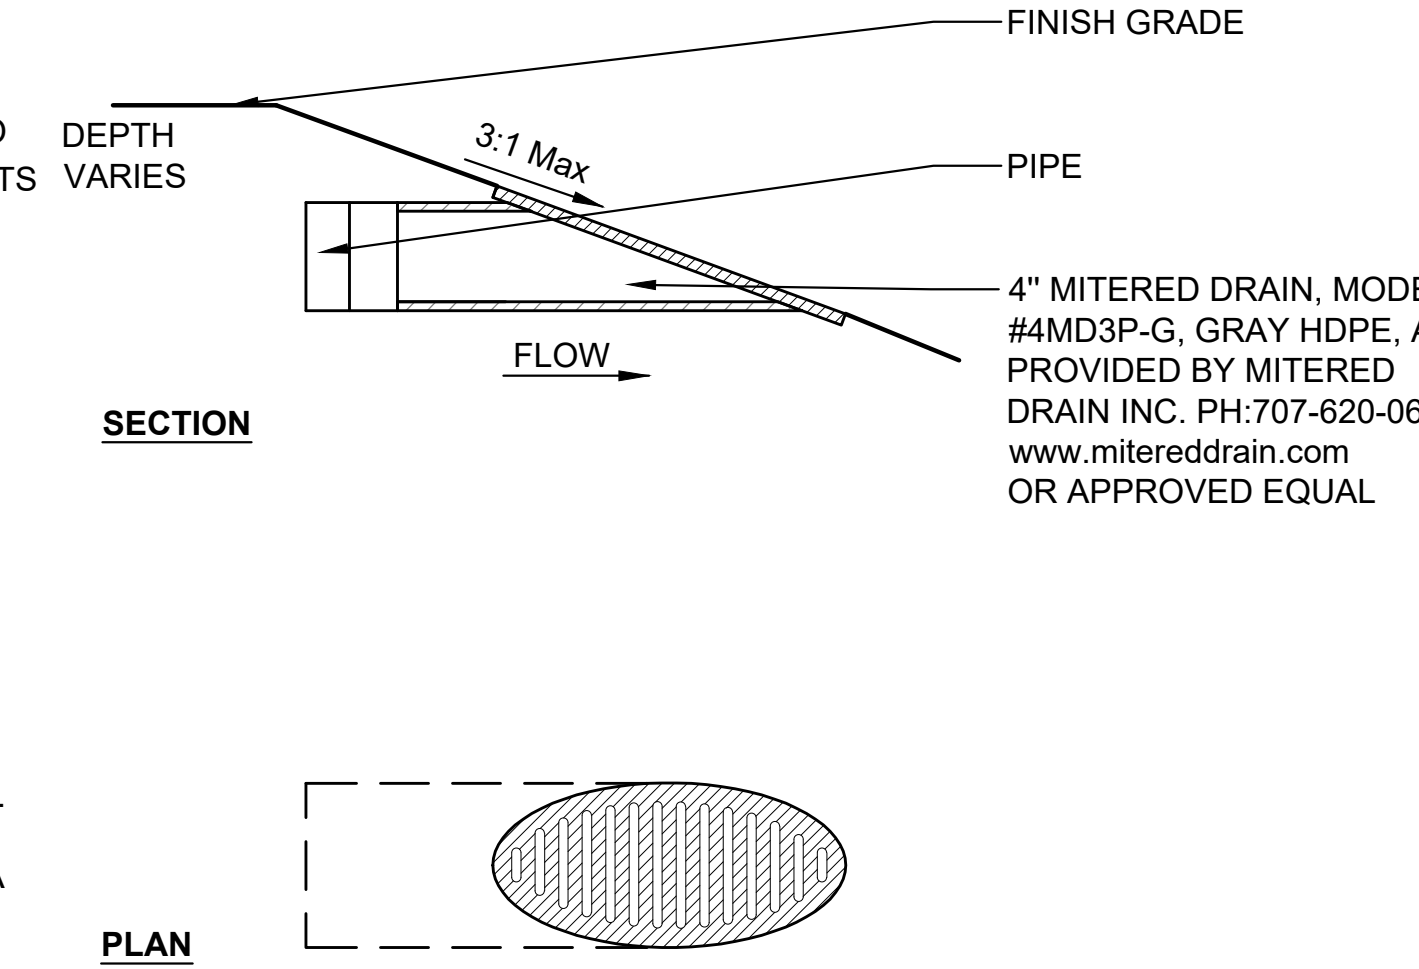

17 Mitered Drain
SCALE: 1 1/2"=1'-0"
d-mitered drain_8

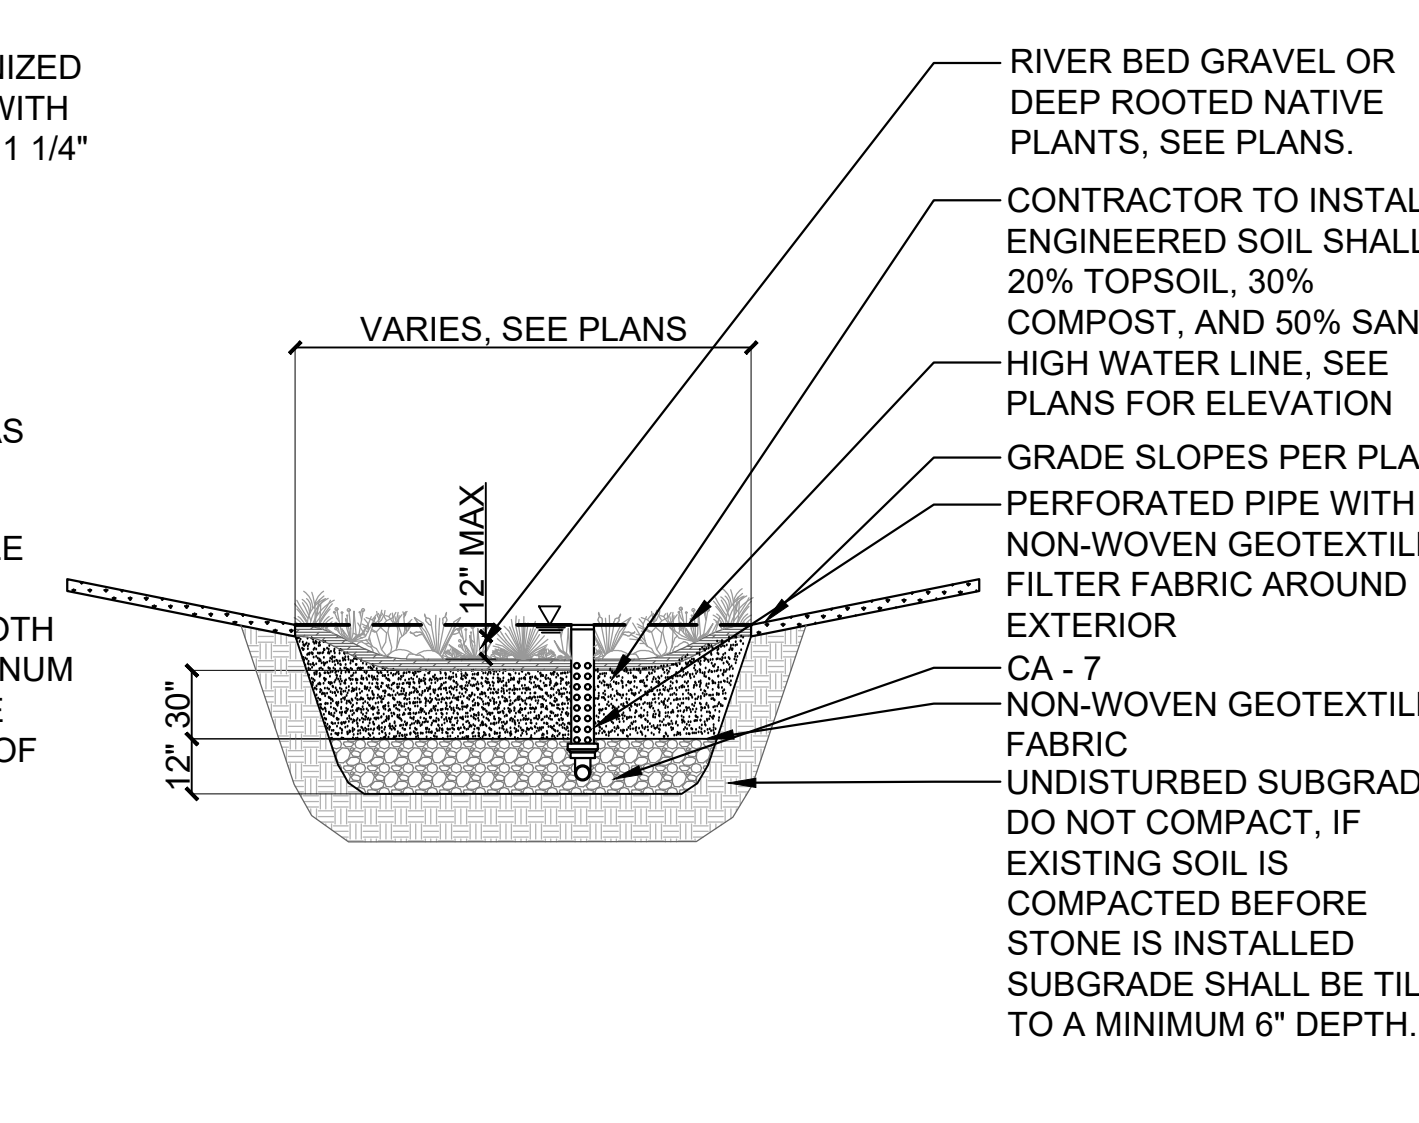

18 Rain Garden Typical Section
SCALE: N.T.S.
d-plant_rain garden_48.dwg

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ISSUED	REVISED	DATE	BY	CHECKED	APPROVED	SHEET TITLE	CONSTRUCTION DETAILS	SHEET NUMBER


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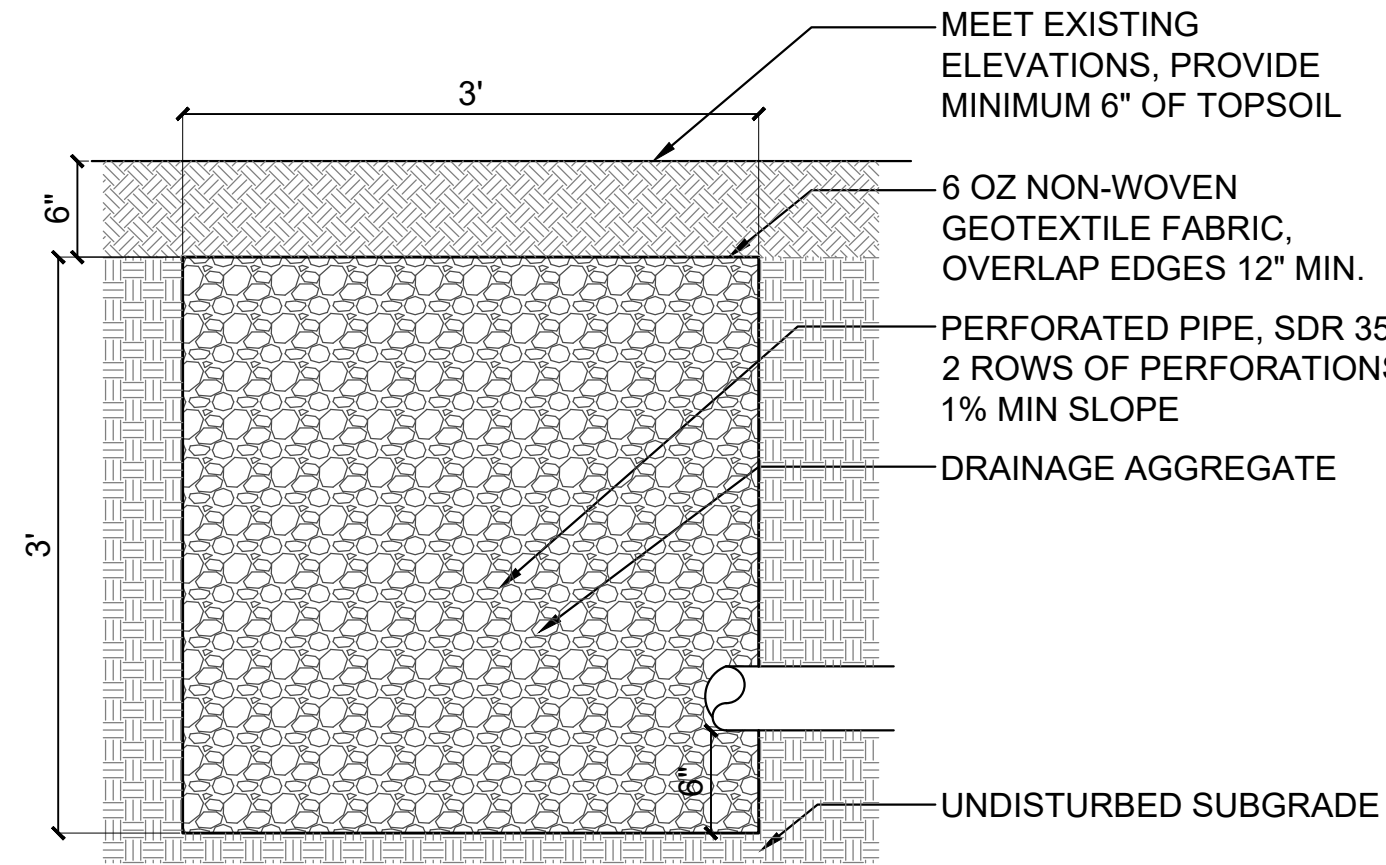
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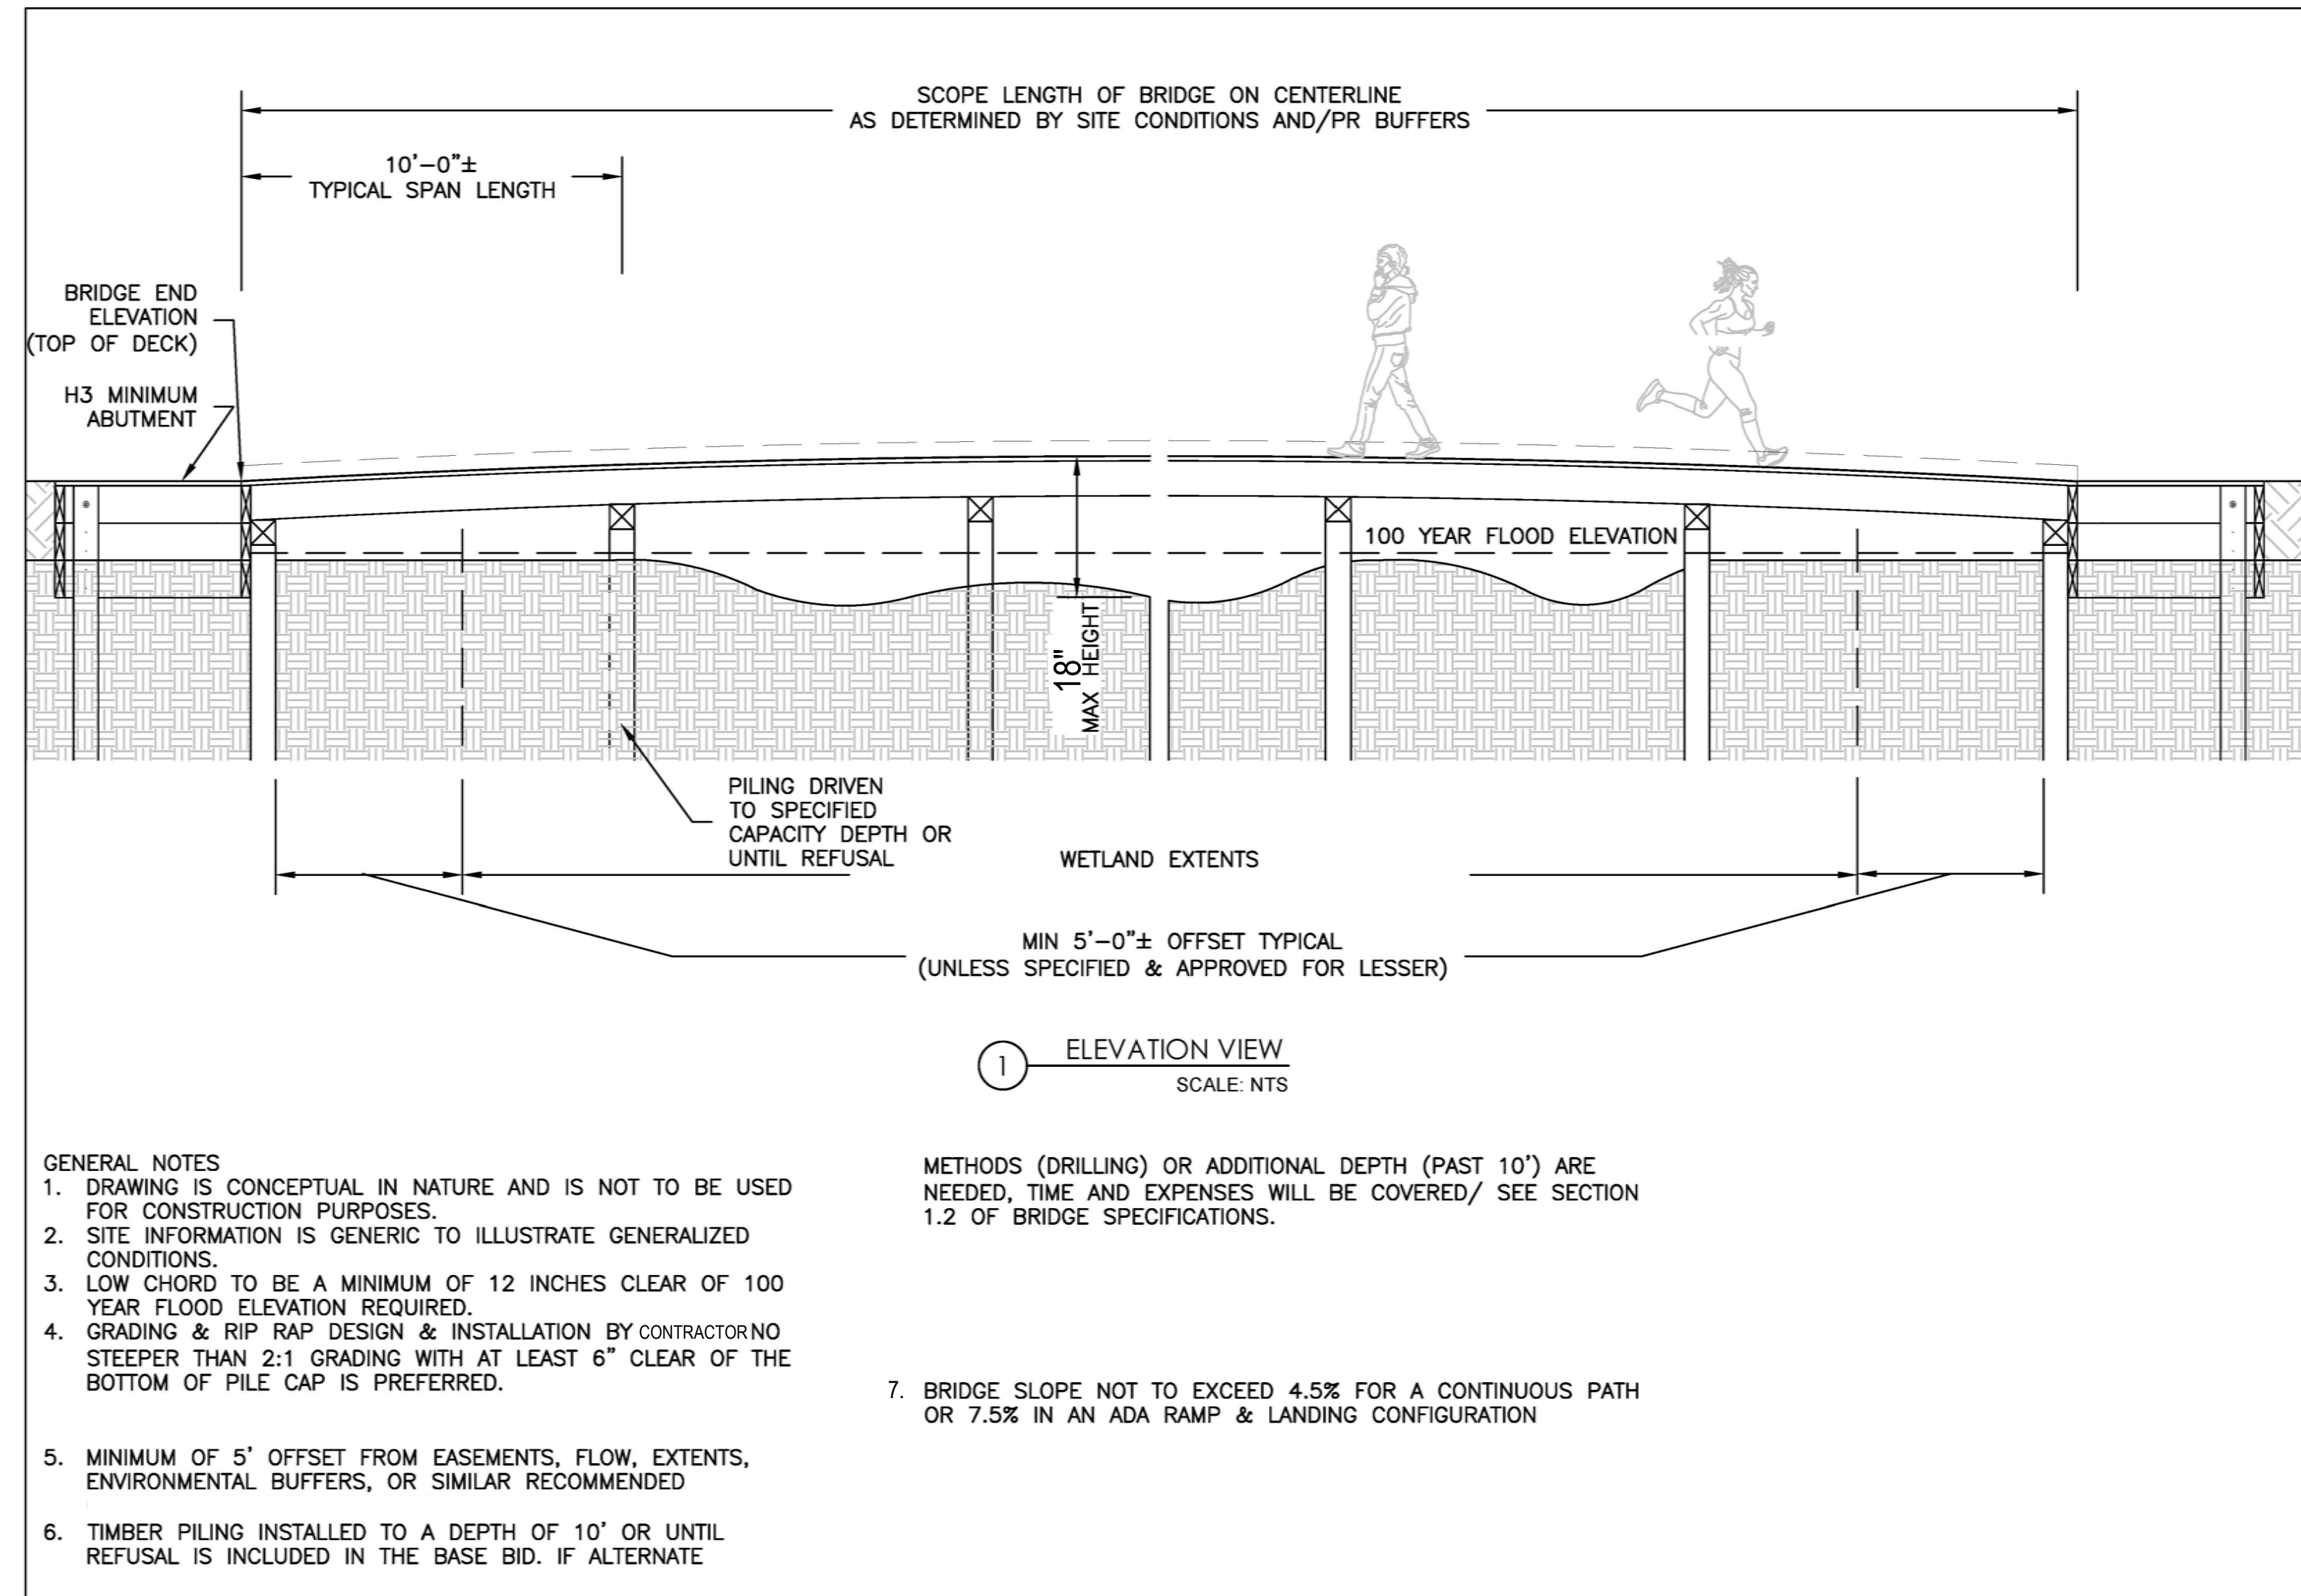
L500




1 12" Nyloplast Yard Drain
N.T.S.





3 French Drain
SCALE: 1" = 1'-0"

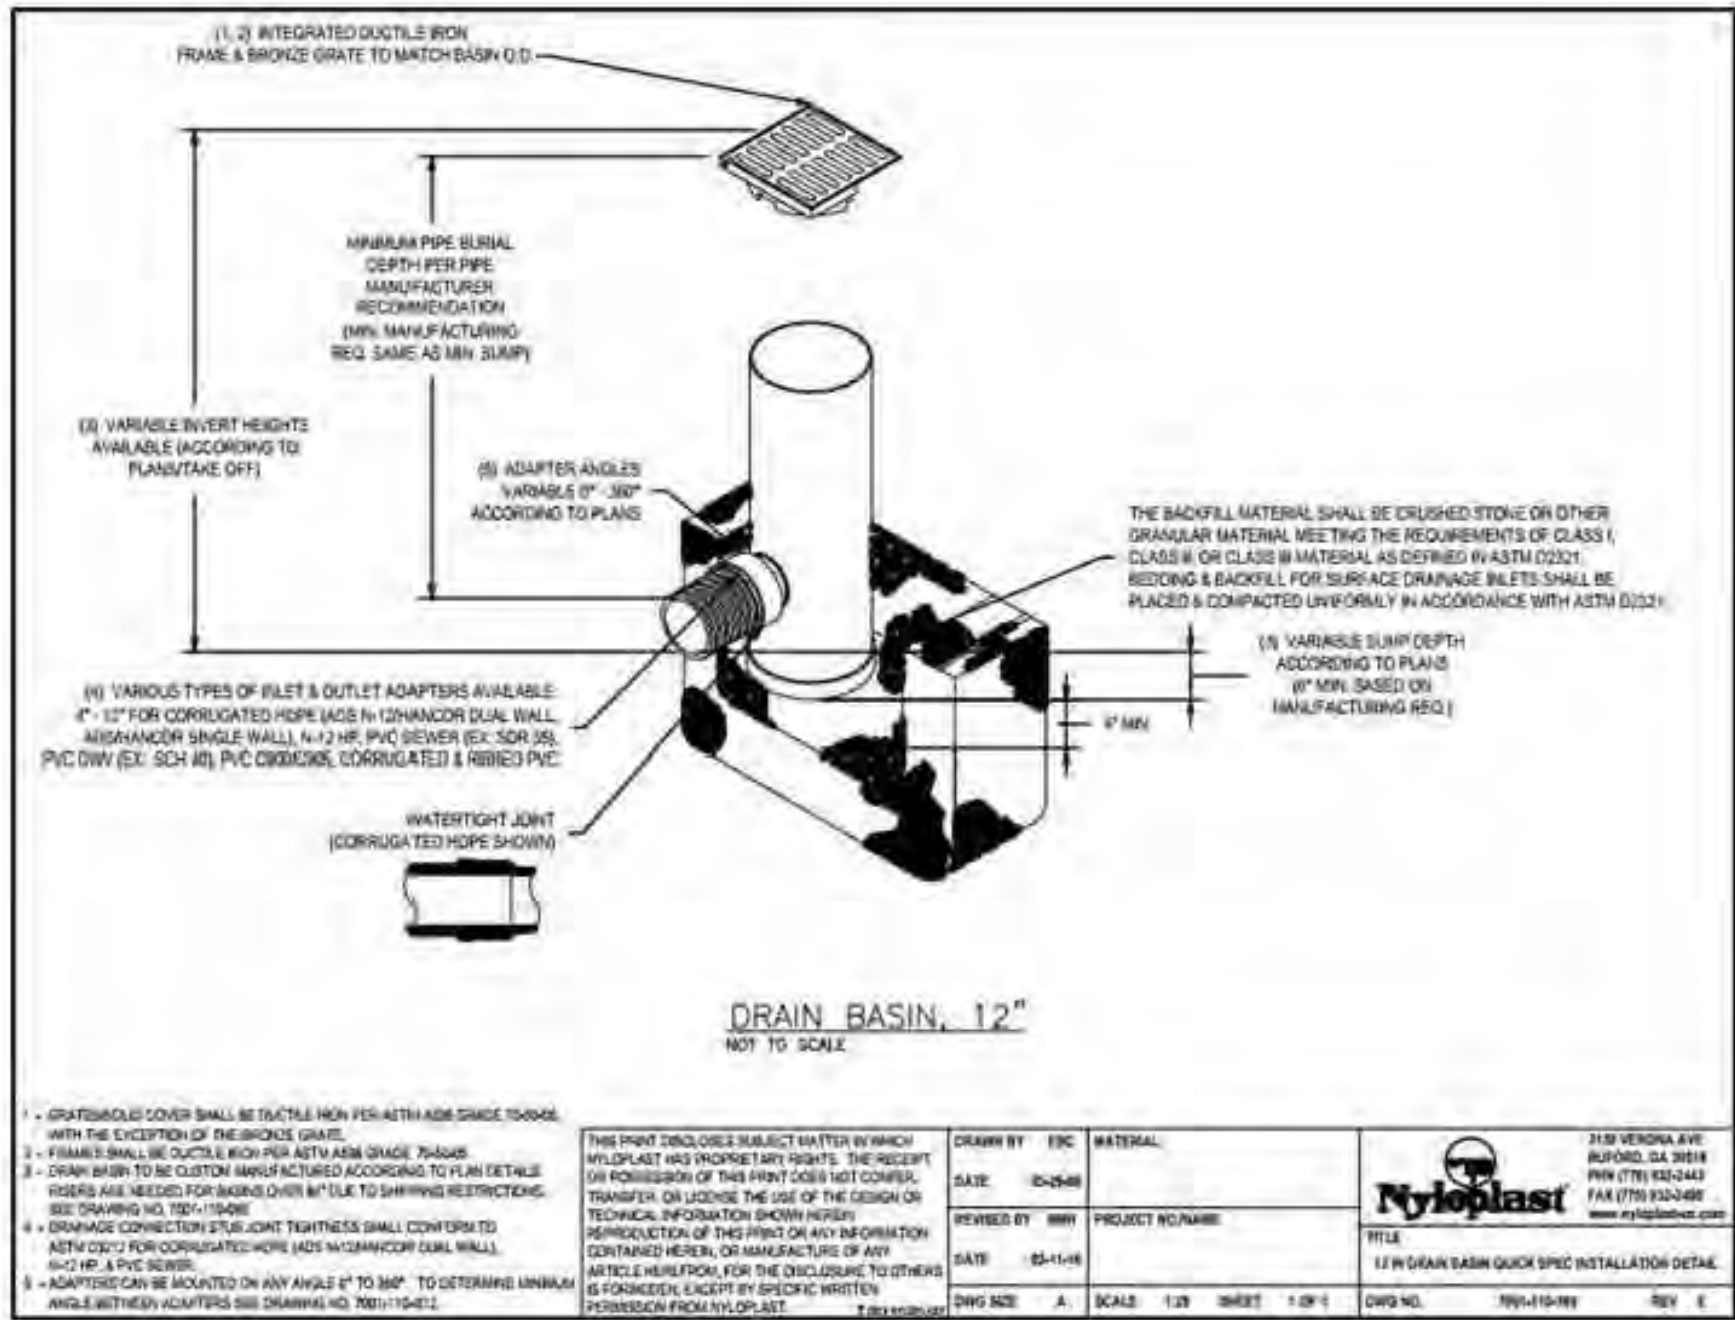

2 Boardwalk
SCALE: 1" = 1'-0"

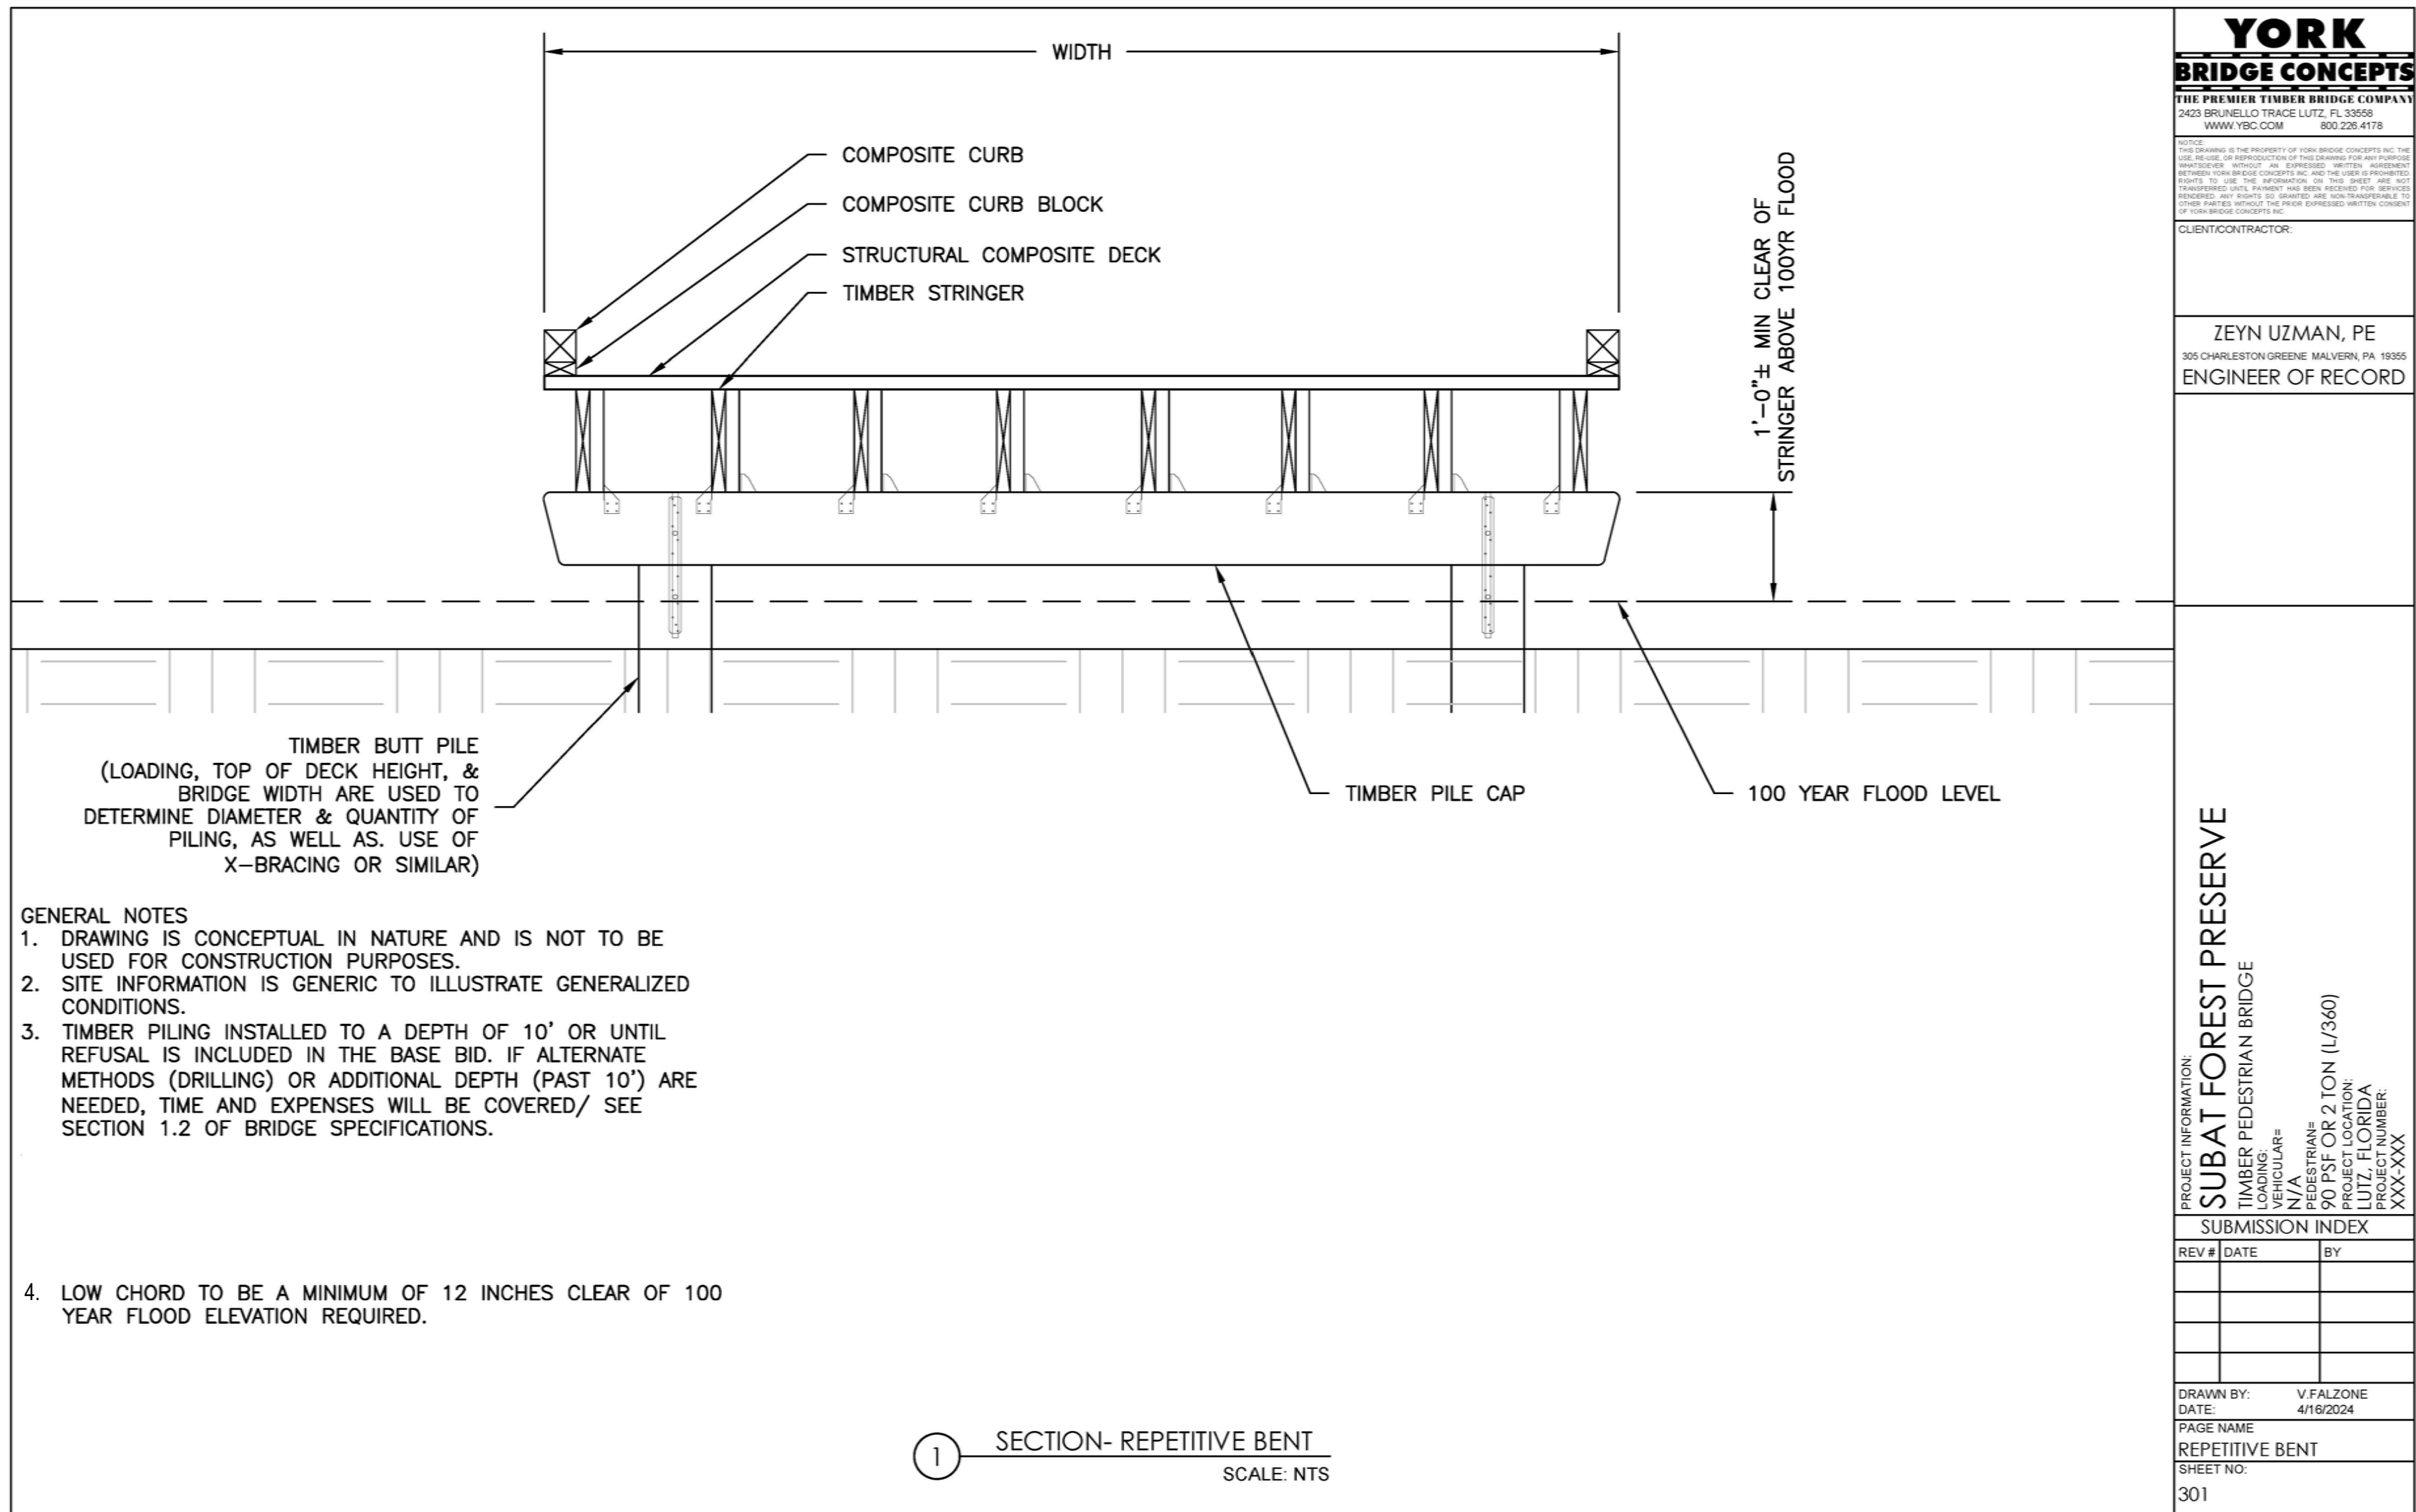

1 SECTION- REPETITIVE BENT
SCALE: N.T.S.

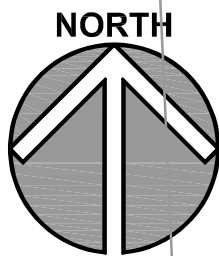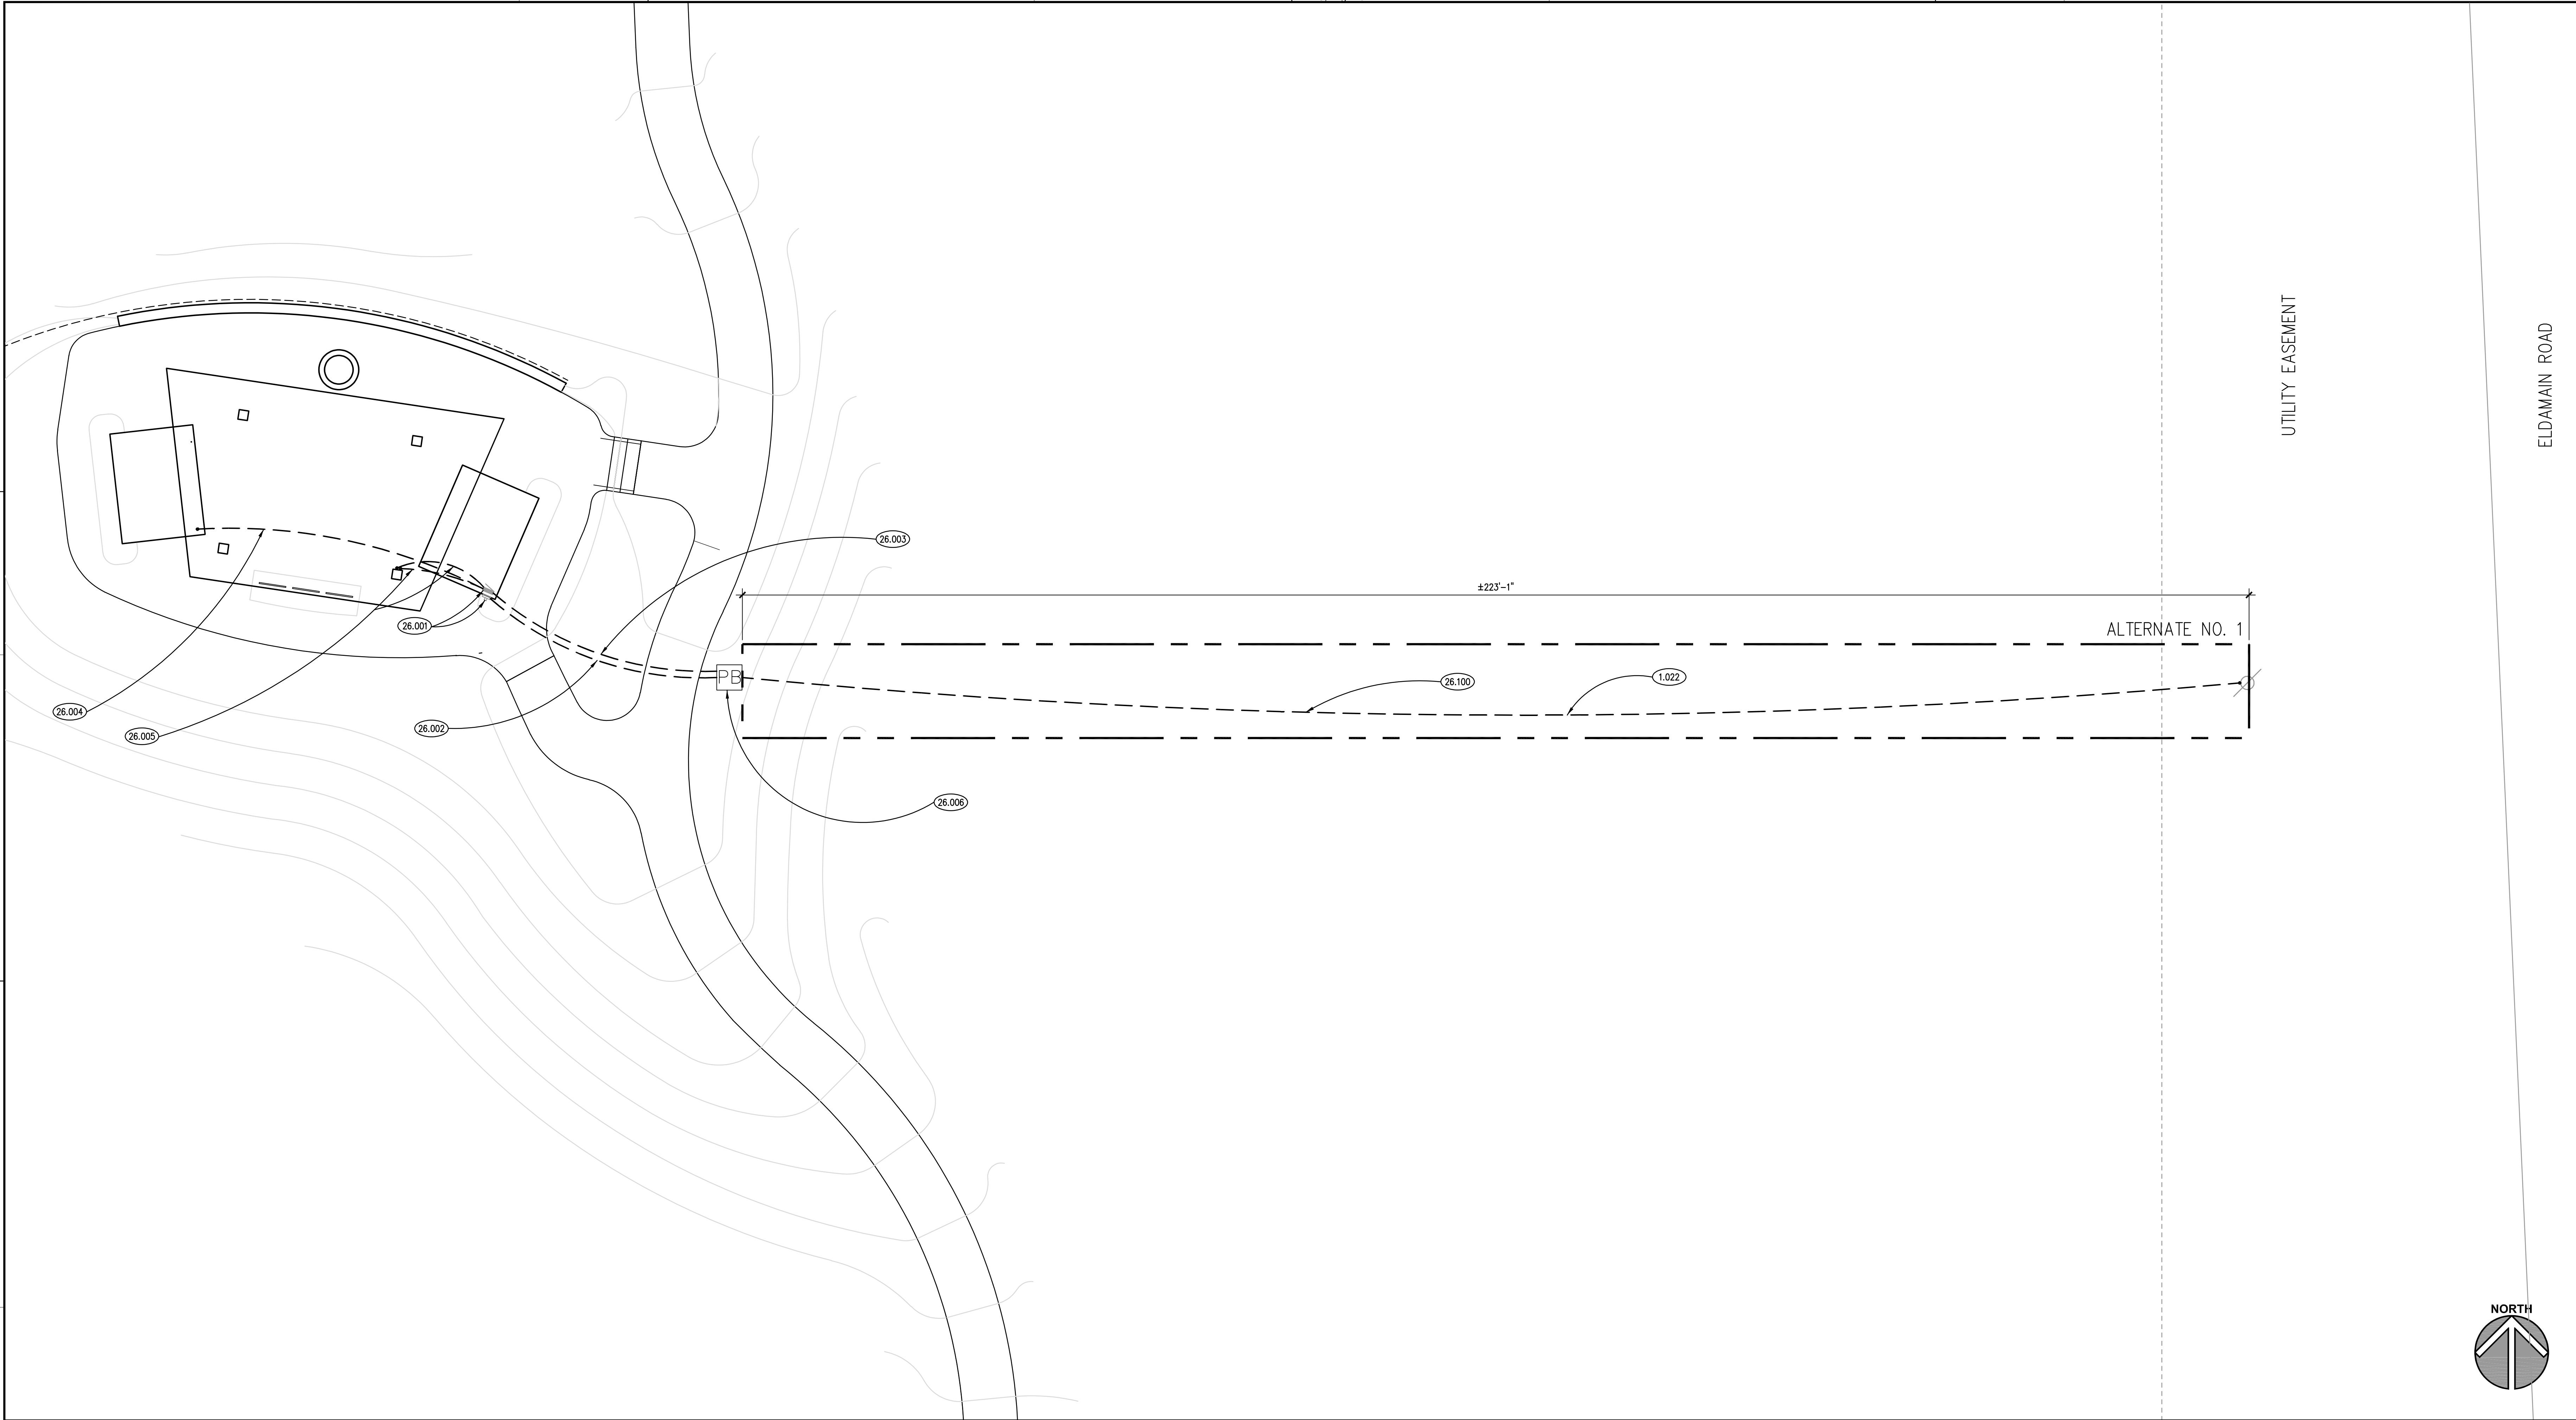

SITE PLAN
SCALE: 1" = 10'-0"

1

KEYNOTES

KEYNOTES ARE TYPICALLY NOT DUPLICATED WITHIN A GIVEN DETAIL. AN UN-KEYNOTED ITEM IN A DETAIL IS THE SAME AS A KEYNOTED ITEM HAVING THE SAME APPEARANCE WITHIN THE SAME DETAIL.

- 1.022 ALTERNATE NO. 1: DIG NECESSARY AREA TO INSTALL CONDUIT AND COORDINATE PRAIRIE GRASS RESTORATION BY OWNER.
- 26.001 FOR REFERENCE ONLY: FUTURE ELECTRICAL SERVICE AND PANELBOARD.
- 26.002 PROVIDE 1-1/2" EMPTY PVC CONDUIT FROM PULL BOX LOCATION, STUBBED AND CAPPED AT BUILDING EXTERIOR (FUTURE SERVICE/METER LOCATION). TRANSITION TO GALVANIZED RIGID STEEL CONDUIT ABOVE GRADE.
- 26.003 PROVIDE 1" EMPTY PVC CONDUIT FROM PULL BOX LOCATION, STUBBED AND CAPPED INTO BUILDING CORNER (FUTURE PANEL LOCATION).
- 26.004 PROVIDE 3/4" EMPTY PVC CONDUIT FROM FUTURE PANEL LOCATION TO SE CORNER OF WEST ROOM AS SHOWN. STUB AND CAP. TRANSITION TO GALVANIZED RIGID STEEL CONDUIT ABOVE GRADE.
- 26.005 PROVIDE 2"-2" AND 2-3/4" EMPTY PVC CONDUIT FROM FUTURE PANEL LOCATION TO SE CORNER OF WEST ROOM AS SHOWN. STUB AND CAP. TRANSITION TO GALVANIZED RIGID STEEL CONDUIT ABOVE GRADE. ROUTE CONDUIT THROUGH COLUMN TO ACCESSIBLE CEILING LOCATION.
- 26.006 PROVIDE IN-GRADE PULL BOX. MINIMUM DIMENSION 11"x18". BASIS OF DESIGN: QUIAZITE PG STYLE.
- 26.100 ALTERNATE NO. 1: PROVIDE 1-1/2" EMPTY SCH 40 PVC CONDUIT FROM GROUND MOUNTED PULL BOX STUBBED AND CAPPED AT UTILITY POWER POLE LOCATION. TRANSITION TO GALVANIZED RIGID STEEL ABOVE GRADE.

GENERAL NOTES

1. REFER TO DRAWING G100 FOR PROJECT GENERAL NOTES.
2. COORDINATE INFORMATION ON THIS DRAWING WITH INFORMATION CONTAINED ON CIVIL AND LANDSCAPE DRAWINGS.

ISSUED	DATE	BY	REVIEWED	DATE	BY
	1/14/24	KL	OWNER REVIEW	1/14/24	KL
REVISIONS	DATE	BY	REVISION	DATE	BY
	1/14/24	KL	BID DOCUMENTS	1/14/24	KL

JOB NO.	23-429-1495
DRAWN	SKF
CHECKED	CJH
APPROVED	CJH

SHEET TITLE

ARCHITECTURAL SITE PLAN

SHEET NUMBER

A010


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4675 ELDAMAIN ROAD
PLANO, IL 60545

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tel. 309.330.0400
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BASE BID: BROOM FINISH CONCRETE SLAB WITH TOOLED JOINTS; REFER TO STRUCTURAL DRAWINGS.

ALTERNATE NO. 2: IN LIEU OF BROOMED EXTERIOR CONCRETE SLAB, PROVIDE STAMPED AND STAINED DECORATIVE CONCRETE PAVEMENT WITH DECORATIVE STAINING AND ANIMAL TRACK STAMPING AT NATURE CENTER. REFER TO KEY FOR TYPES OF ANIMALS, TRACK SIZE, AND SPACING.

**FIRST FLOOR PLAN**


SCALE: 1/4" = 1'-0"

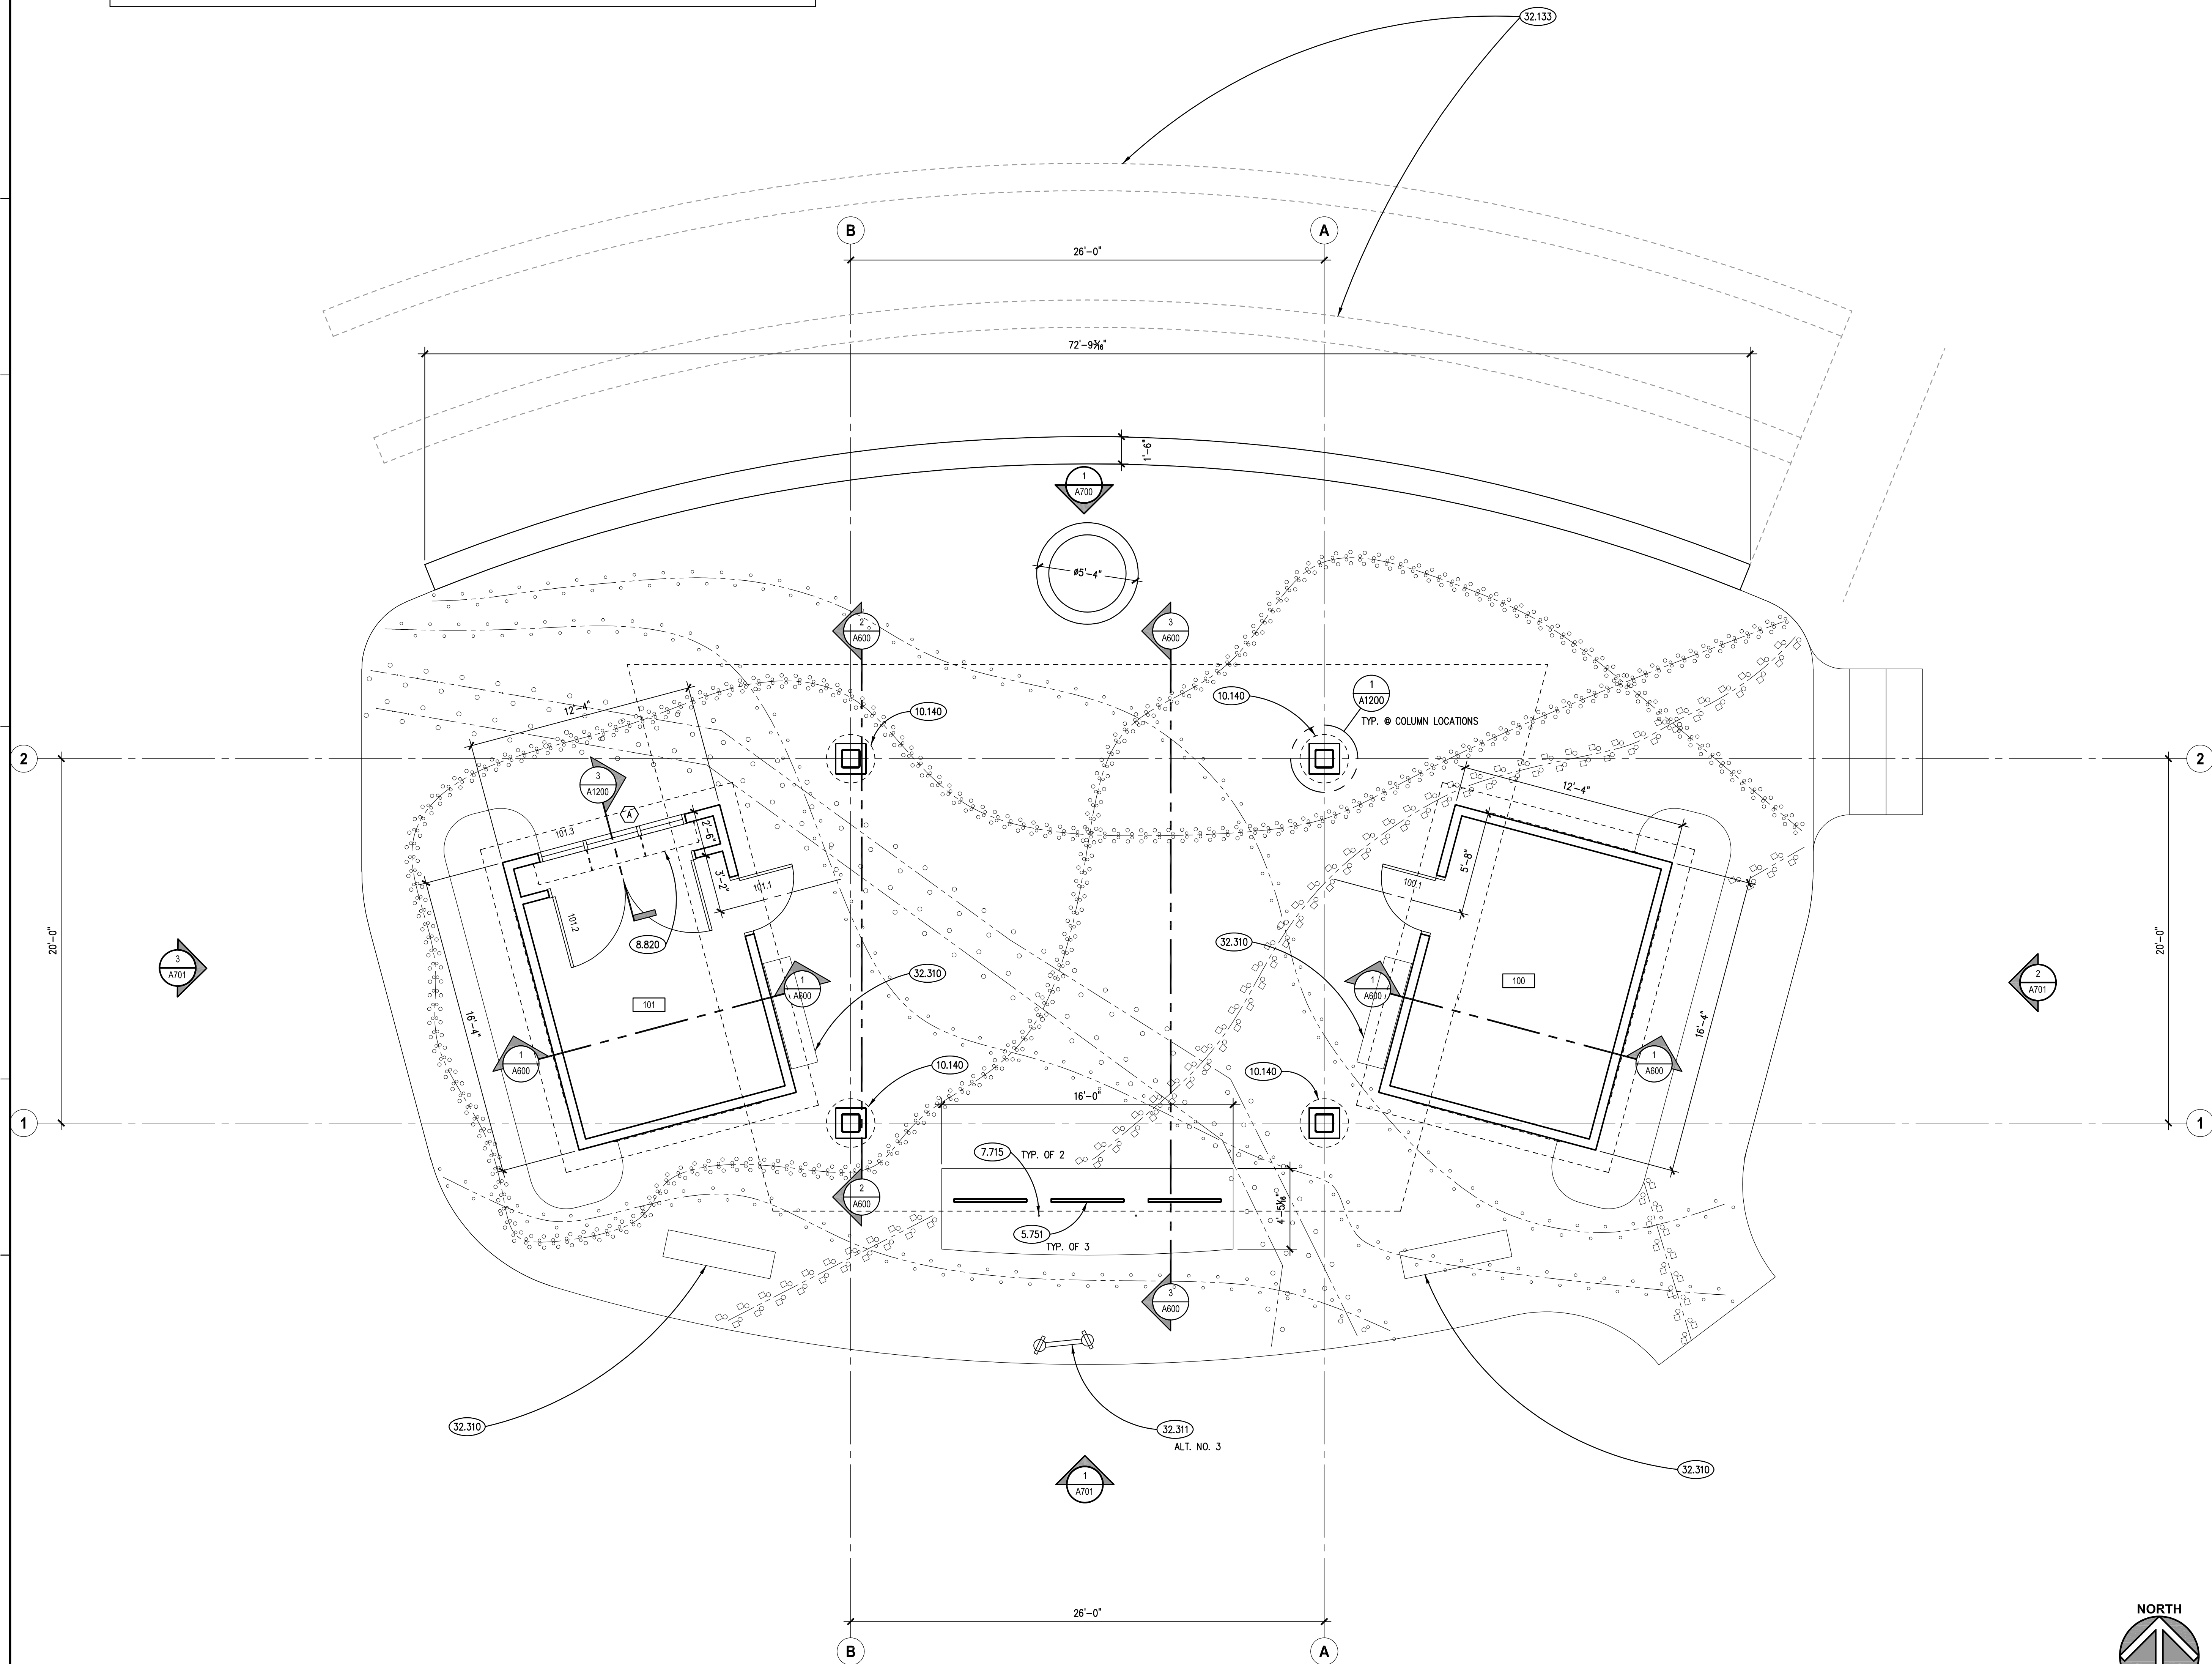1

KEYNOTES

KEYNOTES ARE TYPICALLY NOT DUPLICATED WITHIN A GIVEN DETAIL. AN UNKEYNOTED ITEM IN A DETAIL IS THE SAME AS A KEYNOTED ITEM HAVING THE SAME APPEARANCE WITHIN THE SAME DETAIL.

- 5.751 DECORATIVE METAL PANEL: 4'-0" WIDE X 8'-0" TALL X 1/4" THICK STEEL PLATE, CNC CUT AND POWDERCOATED, EASED EDGES AND 1" RADIUS CORNERS; REFER TO ALLOWANCES AND SPECIFICATIONS.
- 7.715 METAL DOWNSPOUT ACCESSORY: RAIN CHAIN: DOUBLE LOOPS RAIN CHAIN, BRONZE COLOR; REFER TO SPECIFICATIONS.
- 8.820 DISPLAY GLAZING SYSTEM: 11 SHELF CABLE SYSTEM; REFER TO SPECIFICATIONS.
- 10.140 SIGNAGE: INTREPRETIVE DISPLAY TYPE; REFER TO ALLOWANCES.
- 32.133 FUTURE RETAINING WALL.
- 32.310 PARK BENCH: 6' LONG; EMBED MOUNT; CEDAR FINISH.
- 32.311 STATIONARY BINOCULARS: MARK II DUAL ADA COMPLIANT BASE; REFER TO SPECIFICATIONS.

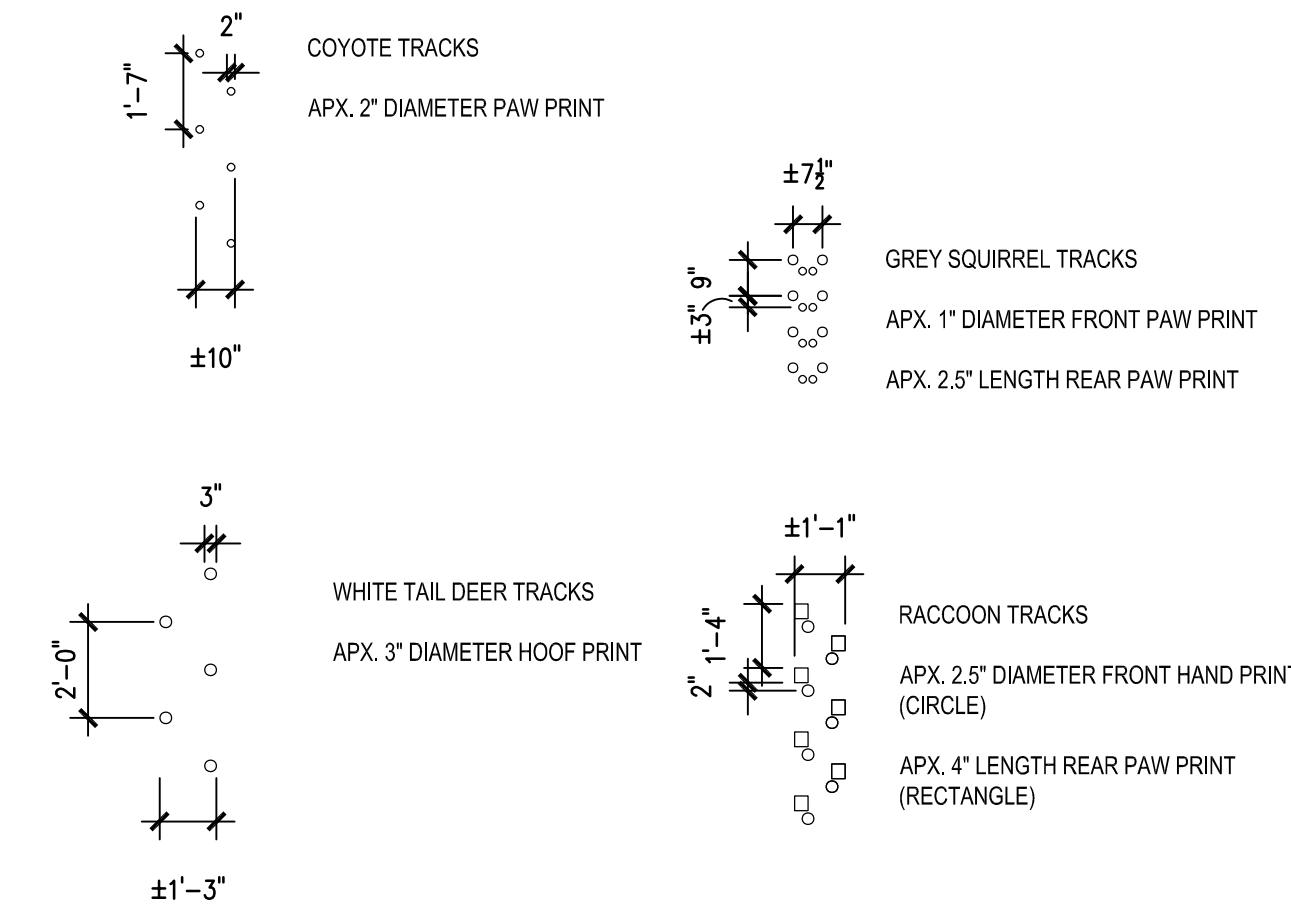ANIMAL TRACK KEY**ROOM SCHEDULE**

RM. NO.	ROOM NAME	RM. NO.	ROOM NAME
100	EAST SHED		
101	WEST SHED		

GENERAL NOTES

- REFER TO DRAWING G100 FOR PROJECT GENERAL NOTES.
- REFER TO DRAWING A700 FOR ORTHOGONAL ELEVATIONS OF EAST AND WEST SHEDS.
- REFER TO LANDSCAPE DRAWINGS FOR SLAB DIMENSIONS.

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PLANO, IL 60545

ISSUED

OWNER REVIEW
DATE: 04/10/24
BY: CJK

JOB NO. 23-429-1495
DRAWN SKF/PJT
CHECKED CJH
APPROVED CJH

SHEET TITLE

ARCHITECTURAL
FIRST FLOOR PLAN

SHEET NUMBER

A310

KEYNOTES



KEYNOTES ARE TYPICALLY NOT DUPLICATED WITHIN A GIVEN DETAIL. AN UN-KEYNOTED ITEM IN A DETAIL IS THE SAME AS A KEYNOTED ITEM HAVING THE SAME APPEARANCE WITHIN THE SAME DETAIL.

- 7.310 ASPHALT SHINGLE ROOFING SYSTEM: REFER TO SPECIFICATIONS.
7.712 METAL GUTTER: MATERIAL, 6 INCH K-OGEE PROFILE; THICKNESS AND FINISH AS SPECIFIED.
7.713 METAL DOWNSPOUT: MATERIAL, 3 INCH X 4 INCH RIBBED; THICKNESS AND FINISH AS SPECIFIED.
7.716 METAL DOWNSPOUT ACCESSORY: RAIN CHAIN ACCESSORY: INSTALLATION KIT; REFER TO SPECIFICATIONS.

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ROOF PLAN
SCALE: 1/16" = 1'-0"

1

GENERAL NOTES

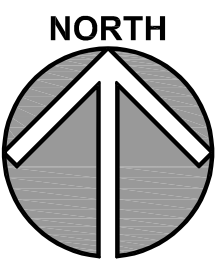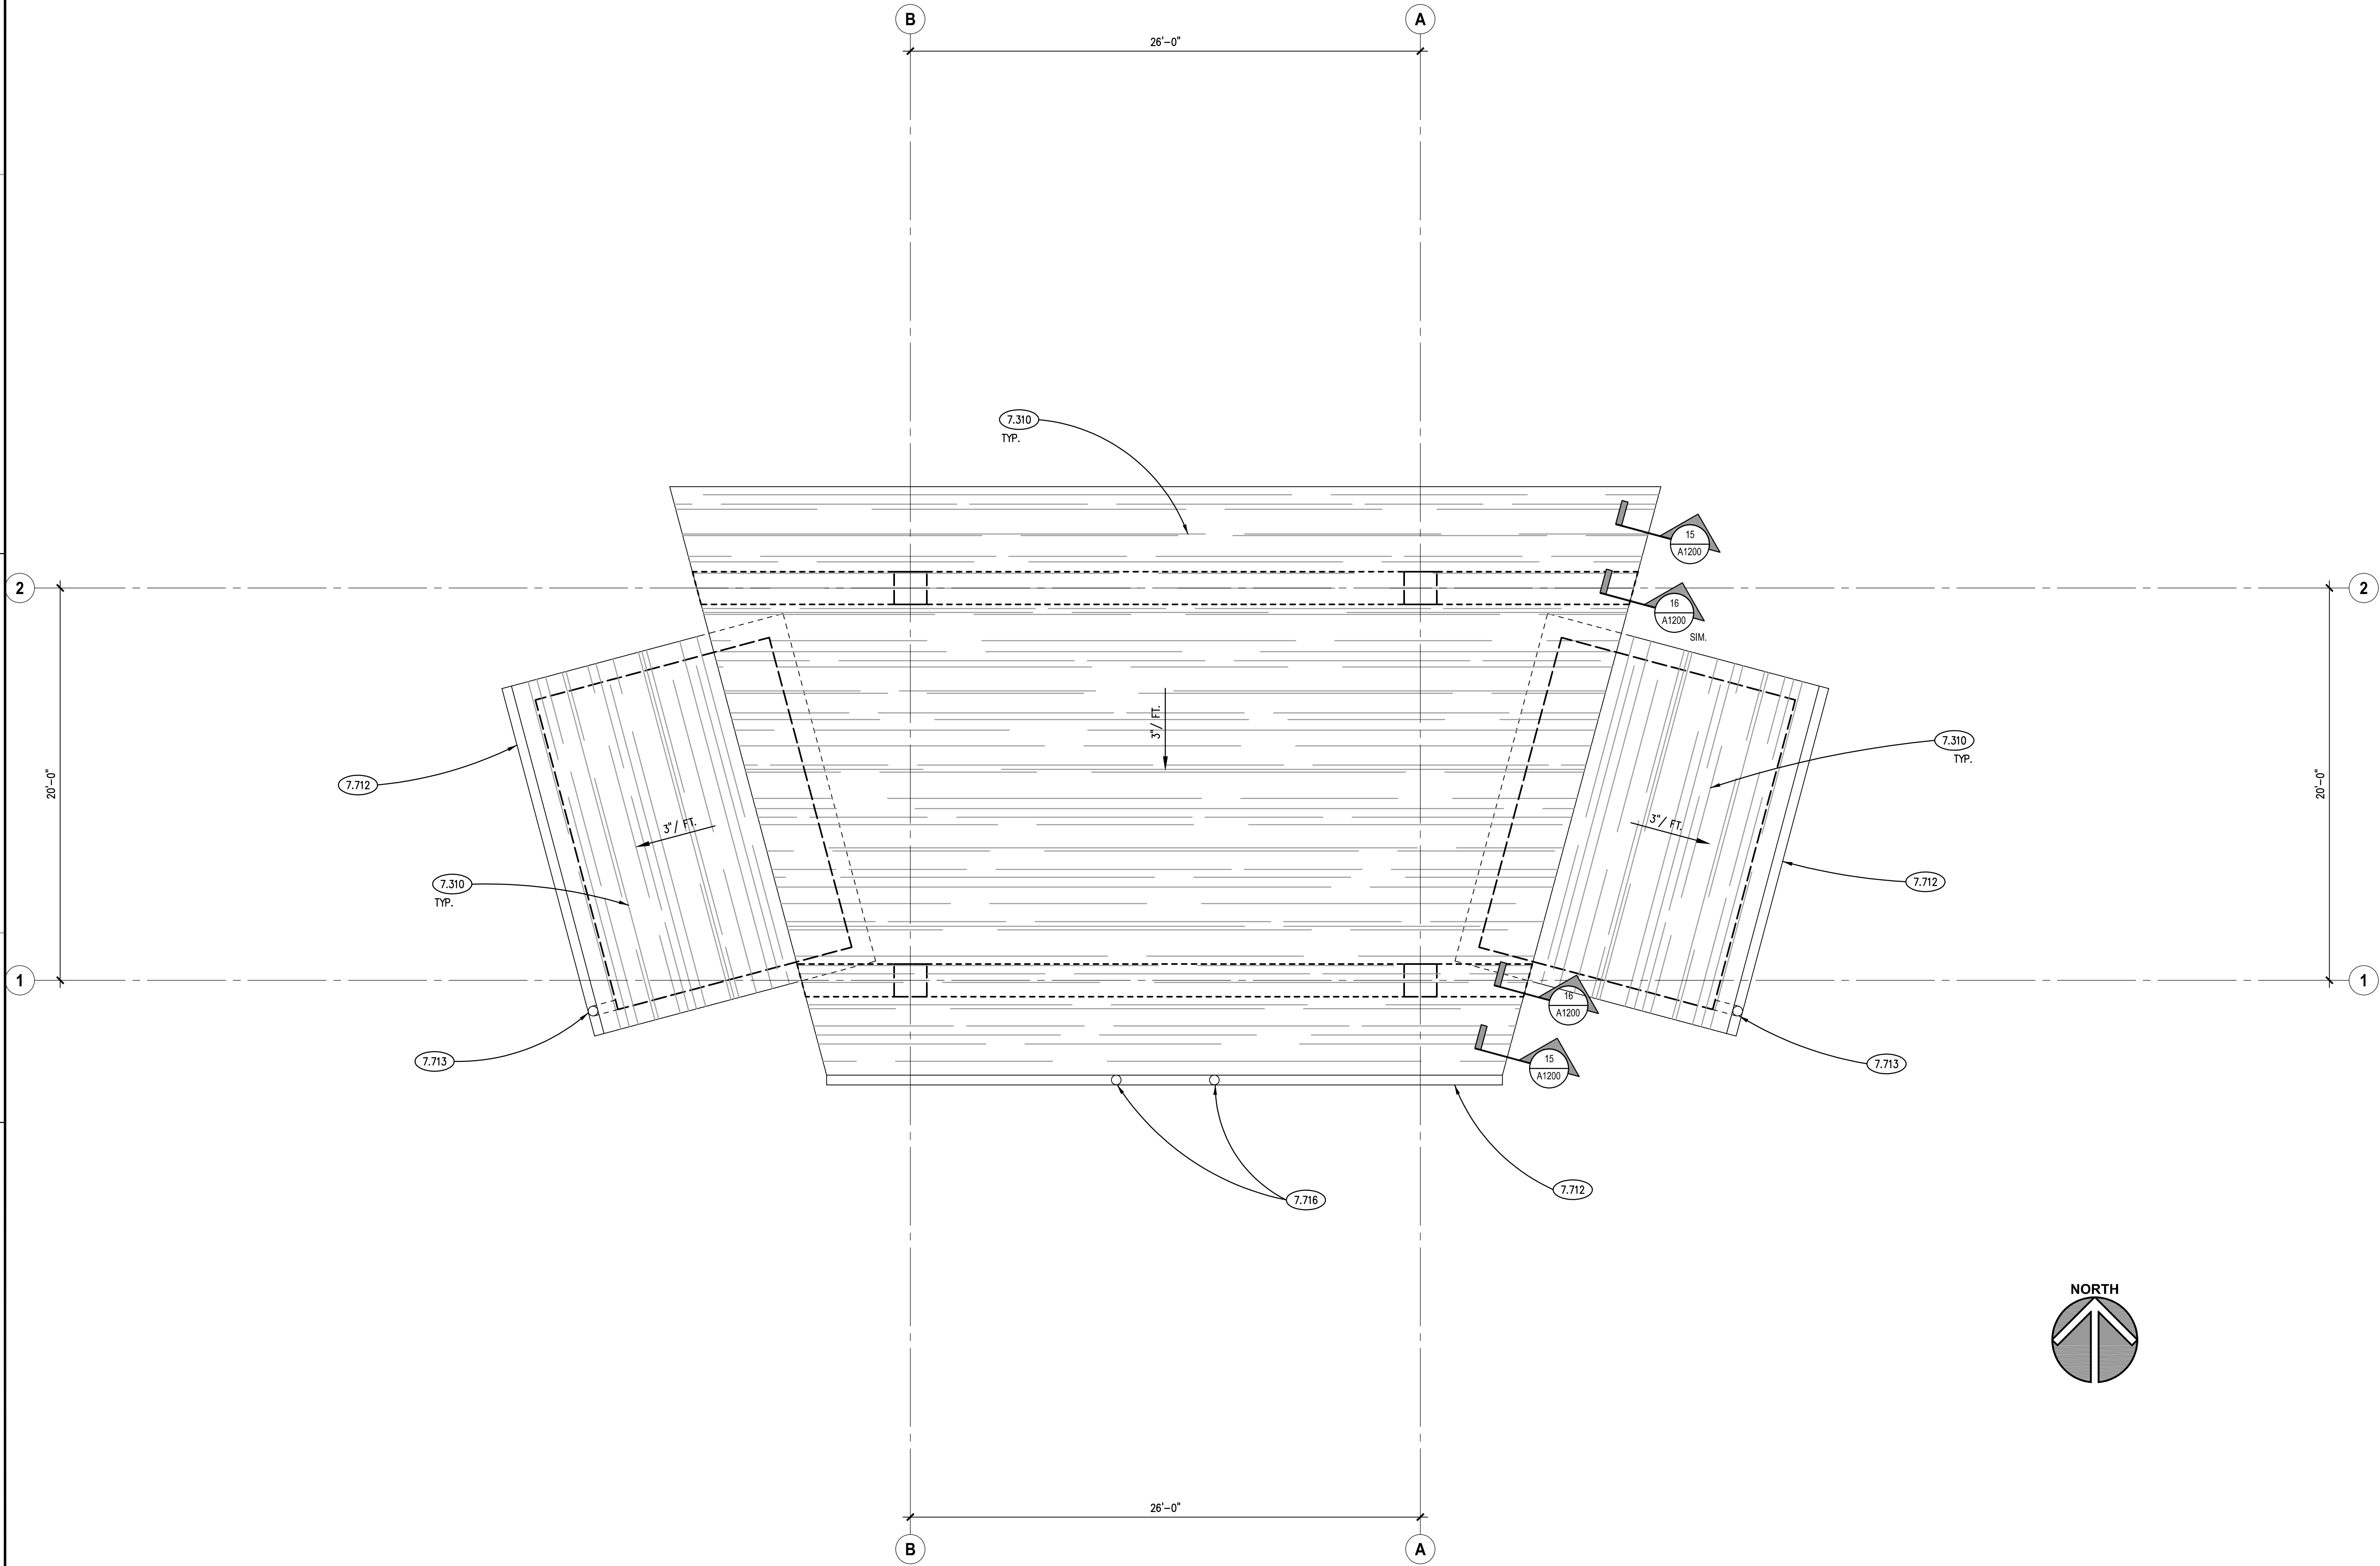1. REFER TO DRAWING G100 FOR PROJECT GENERAL NOTES.

ISSUED
DATE
OWNER REVIEW
DATE
BID DOCUMENTS


JOB NO. 23-429-1495
DRAWN P.JT
CHECKED C.JH
APPROVED C.JH

SHEET TITLE

ROOF PLAN

SHEET NUMBER

A330

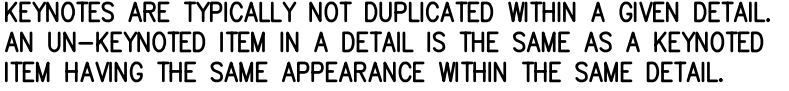

5.751	DECORATIVE METAL PANEL: 4'-0" WIDE X 8'-0" TALL X 1/2" THICK STEEL PANEL. CNC CUT AND POWDERCOATED EASED EDGES AND 1" RADIUS CORNERS. REFER TO ALLOWANCES AND SPECIFICATIONS.
6.201	FINISH CARPENTRY: EXTERIOR SOFFIT LUMBER: 1 X 6 TONGUE AND GROOVE.
6.218	FINISH CARPENTRY: CELLULAR PVC TRIM: 1/2" X 7.25" (ACTUAL), REFER TO SPECIFICATIONS.
	ASPHALT SHINGLE ROOFING SYSTEM: REFER TO SPECIFICATIONS.
7.310	FIBER CEMENT SIDING: REFER TO SPECIFICATIONS.
7.460	FIBER CEMENT SIDING: 5/8" THK. HORIZONTAL V-GROOVE LAP SIDING, 7" EXPOSURE; PRIMED. REFER TO SPECIFICATIONS.
7.464	FIBER CEMENT SIDING: 3.5" X 5/4" TRIM BOARD; PRIMED.
7.467	FIBER CEMENT SIDING: 7.25" X 5/4" TRIM BOARD; PRIMED.
7.715	METAL DOWNSPOUT ACCESSORY: RAIN CHAIN: DOUBLE LOOPS RAIN CHAIN, BRONZE COLOR; REFER TO SPECIFICATIONS.
7.717	METAL DOWNSPOUT ACCESSORY: RAIN CHAIN ACCESSORY: ANCHOR STAKE CAST INTO CONCRETE PIER; REFER TO SPECIFICATIONS.

3

SCALE: 1/4" = 1'-0"



SCALE: 1/4" = 1'-0"



SCALE: 1/4" = 1'-0"

1. REFER TO DRAWING G100 FOR PROJECT GENERAL NOTES

JOB NO. 23-429-1495
DRAWN PJT
CHECKED CJH
APPROVED CJH

SHEET TITLE


BUILDING SECTIONS

SHEET NUMBER

A600

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KEYNOTES


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- 6.201 FINISH CARPENTRY: EXTERIOR SOFFIT LUMBER; 1 X 6 TONGUE AND GROOVE.
- 6.218 FINISH CARPENTRY: CELLULAR PVC TRIM: 1/2" X 7.25" (ACTUAL); REFER TO SPECIFICATIONS.
- 7.310 ASPHALT SHINGLE ROOFING SYSTEM: REFER TO SPECIFICATIONS.
- 7.462 FIBER CEMENT SIDING: 5/8" THK. HORIZONTAL V-GROOVE LAP SIDING; 7" EXPOSURE; PRIMED. REFER TO SPECIFICATIONS.
- 7.464 FIBER CEMENT SIDING: 3.5" X 5/4" TRIM BOARD; PRIMED.
- 7.466 FIBER CEMENT SIDING: 5.5" X 5/4" TRIM BOARD; PRIMED.
- 7.467 FIBER CEMENT SIDING: 7.25" X 5/4" TRIM BOARD; PRIMED.
- 7.468 FIBER CEMENT SIDING: 9.25" X 3/4" TRIM BOARD; PRIMED.
- 7.712 METAL GUTTER: MATERIAL, 6 INCH K-OGEE PROFILE; THICKNESS AND FINISH AS SPECIFIED.
- 7.713 METAL DOWNSPOUT: MATERIAL, 3 INCH X 4 INCH RIBBED; THICKNESS AND FINISH AS SPECIFIED.
- 7.715 METAL DOWNSPOUT ACCESSORY: RAIN CHAIN: DOUBLE LOOPS RAIN CHAIN, BRONZE COLOR; REFER TO SPECIFICATIONS.
- 8.110 STEEL DOOR FRAME: REFER TO DOOR, FRAME AND BORROWED LIGHT SCHEDULE.
- 8.111 STEEL WINDOW FRAME: REFER TO DOOR, FRAME AND BORROWED LIGHT SCHEDULE.
- 10.140 SIGNAGE: INTREPRETIVE DISPLAY TYPE; REFER TO ALLOWANCES.

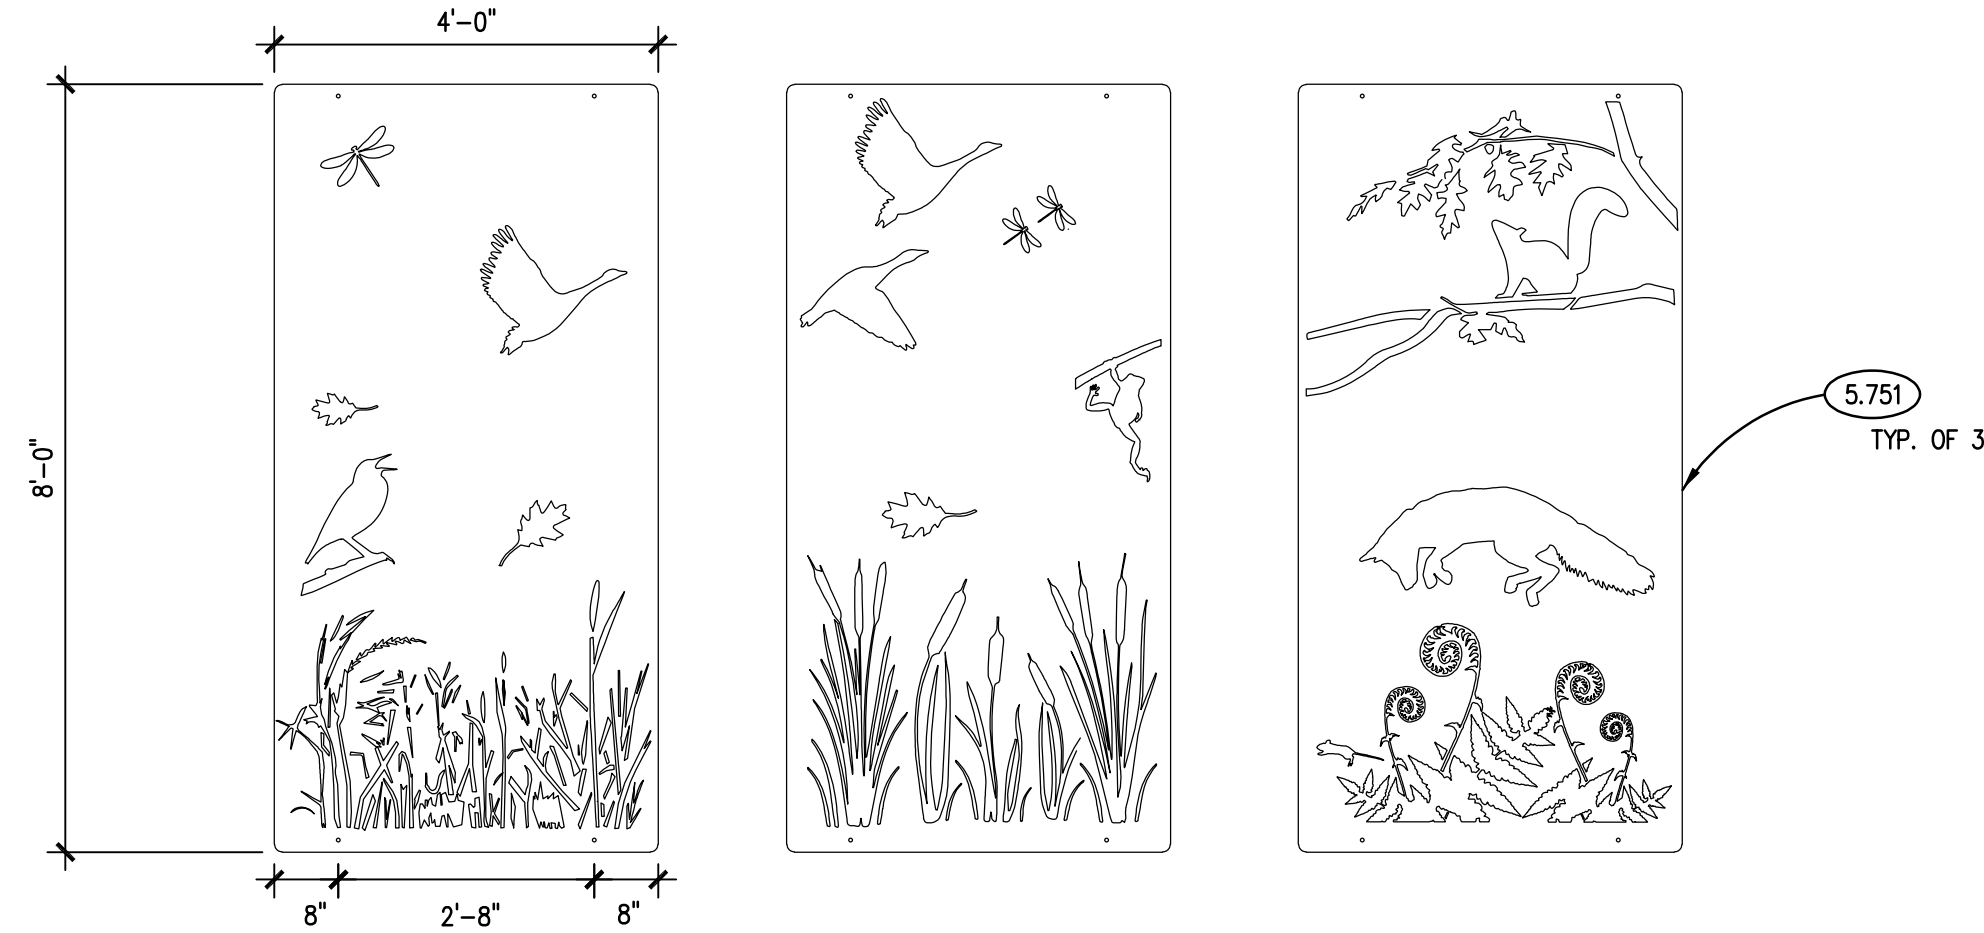DECORATIVE METAL PANEL ELEVATIONS

SCALE: 1/2" = 1'-0"


4

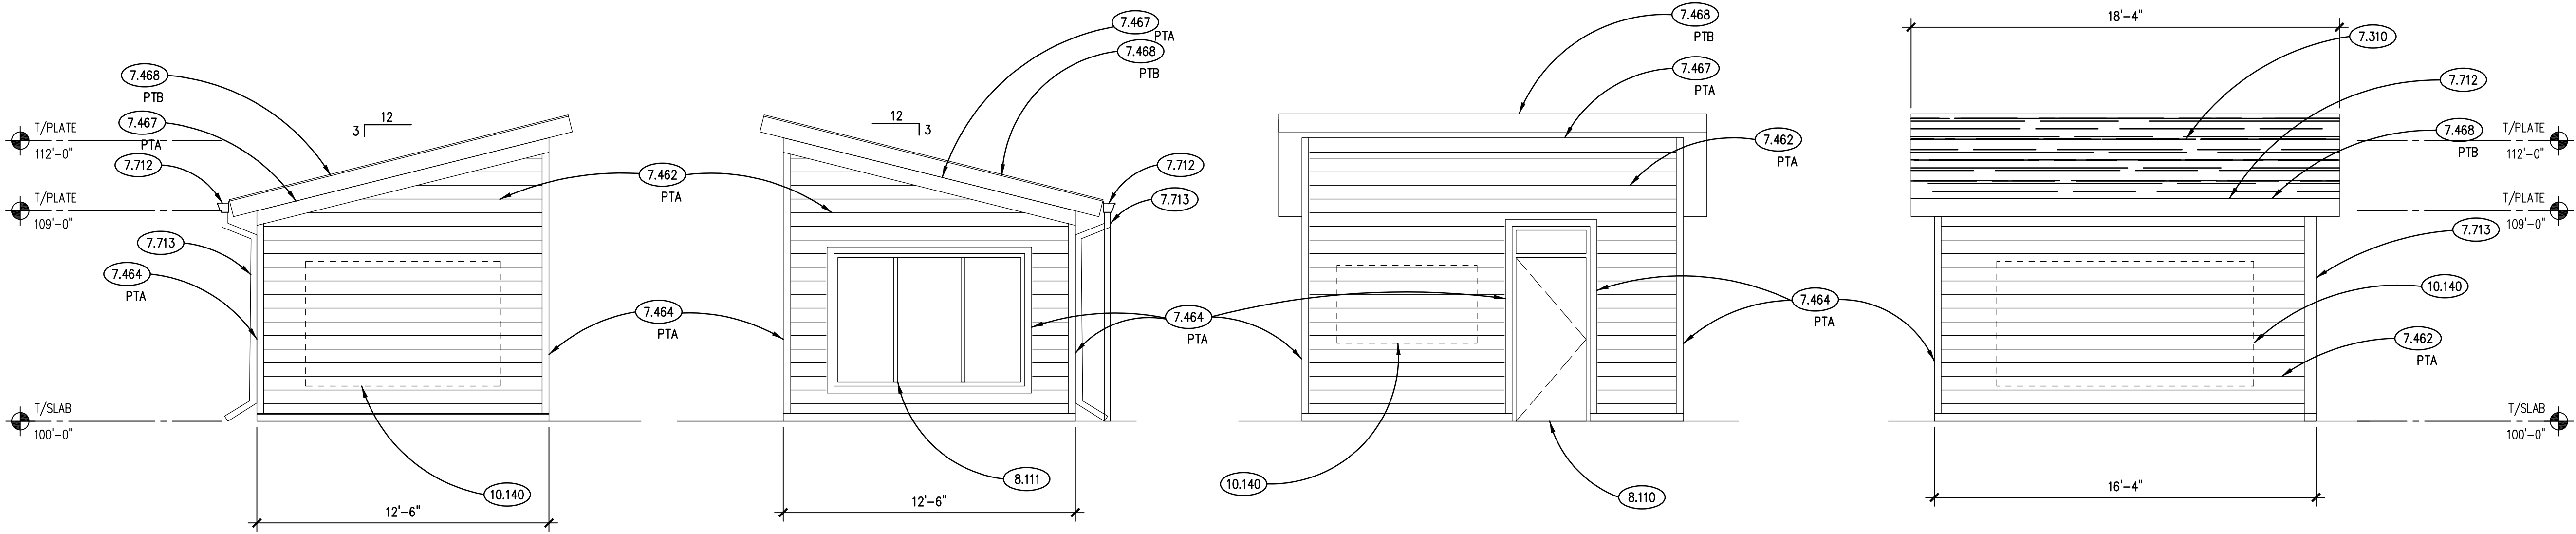

EAST SHED ELEVATIONS

SCALE: 1/4" = 1'-0"


3

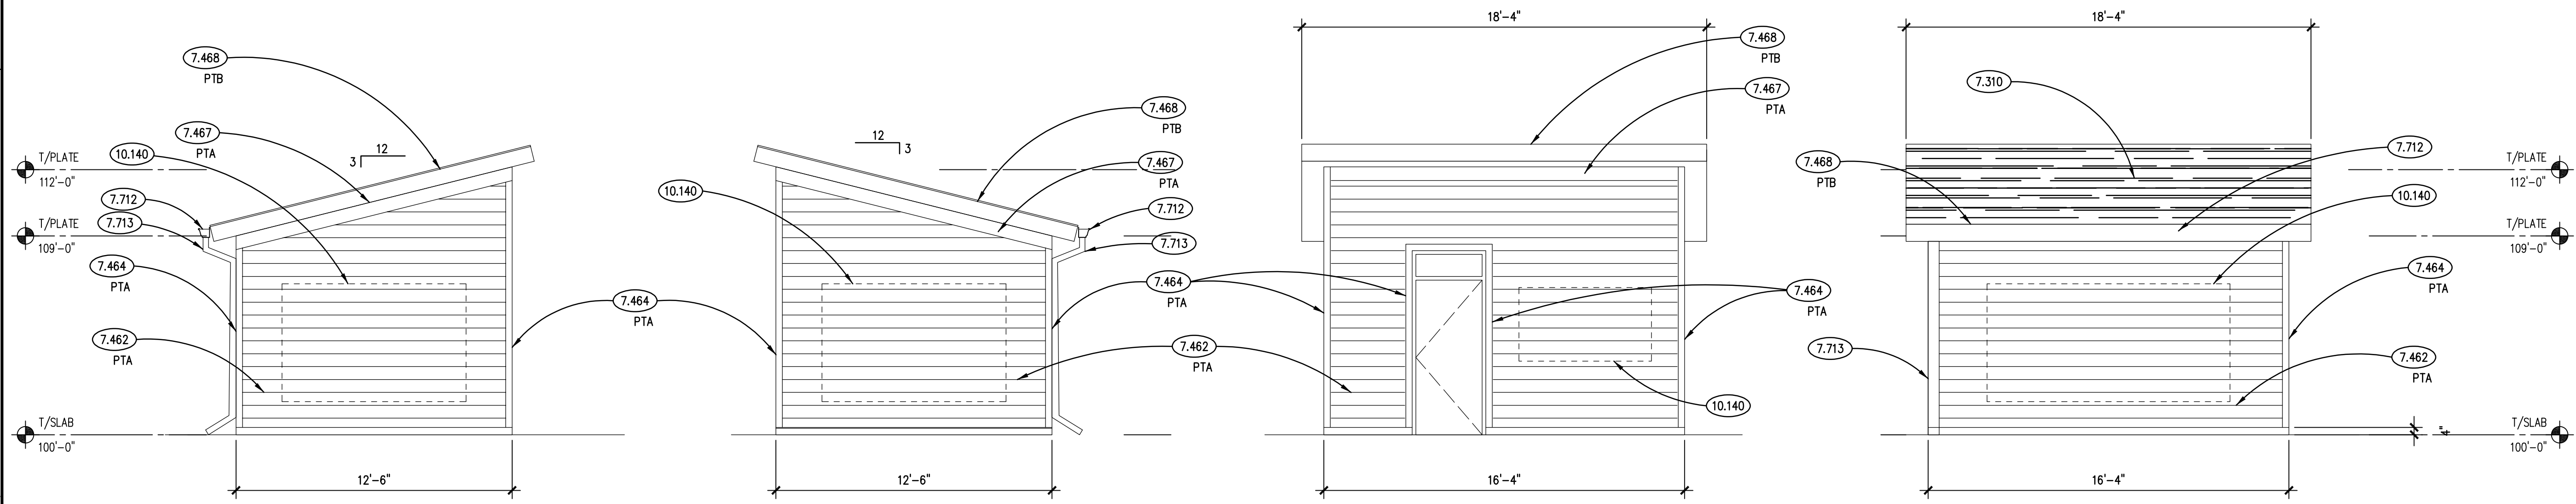

WEST SHED ELEVATIONS

SCALE: 1/4" = 1'-0"

2

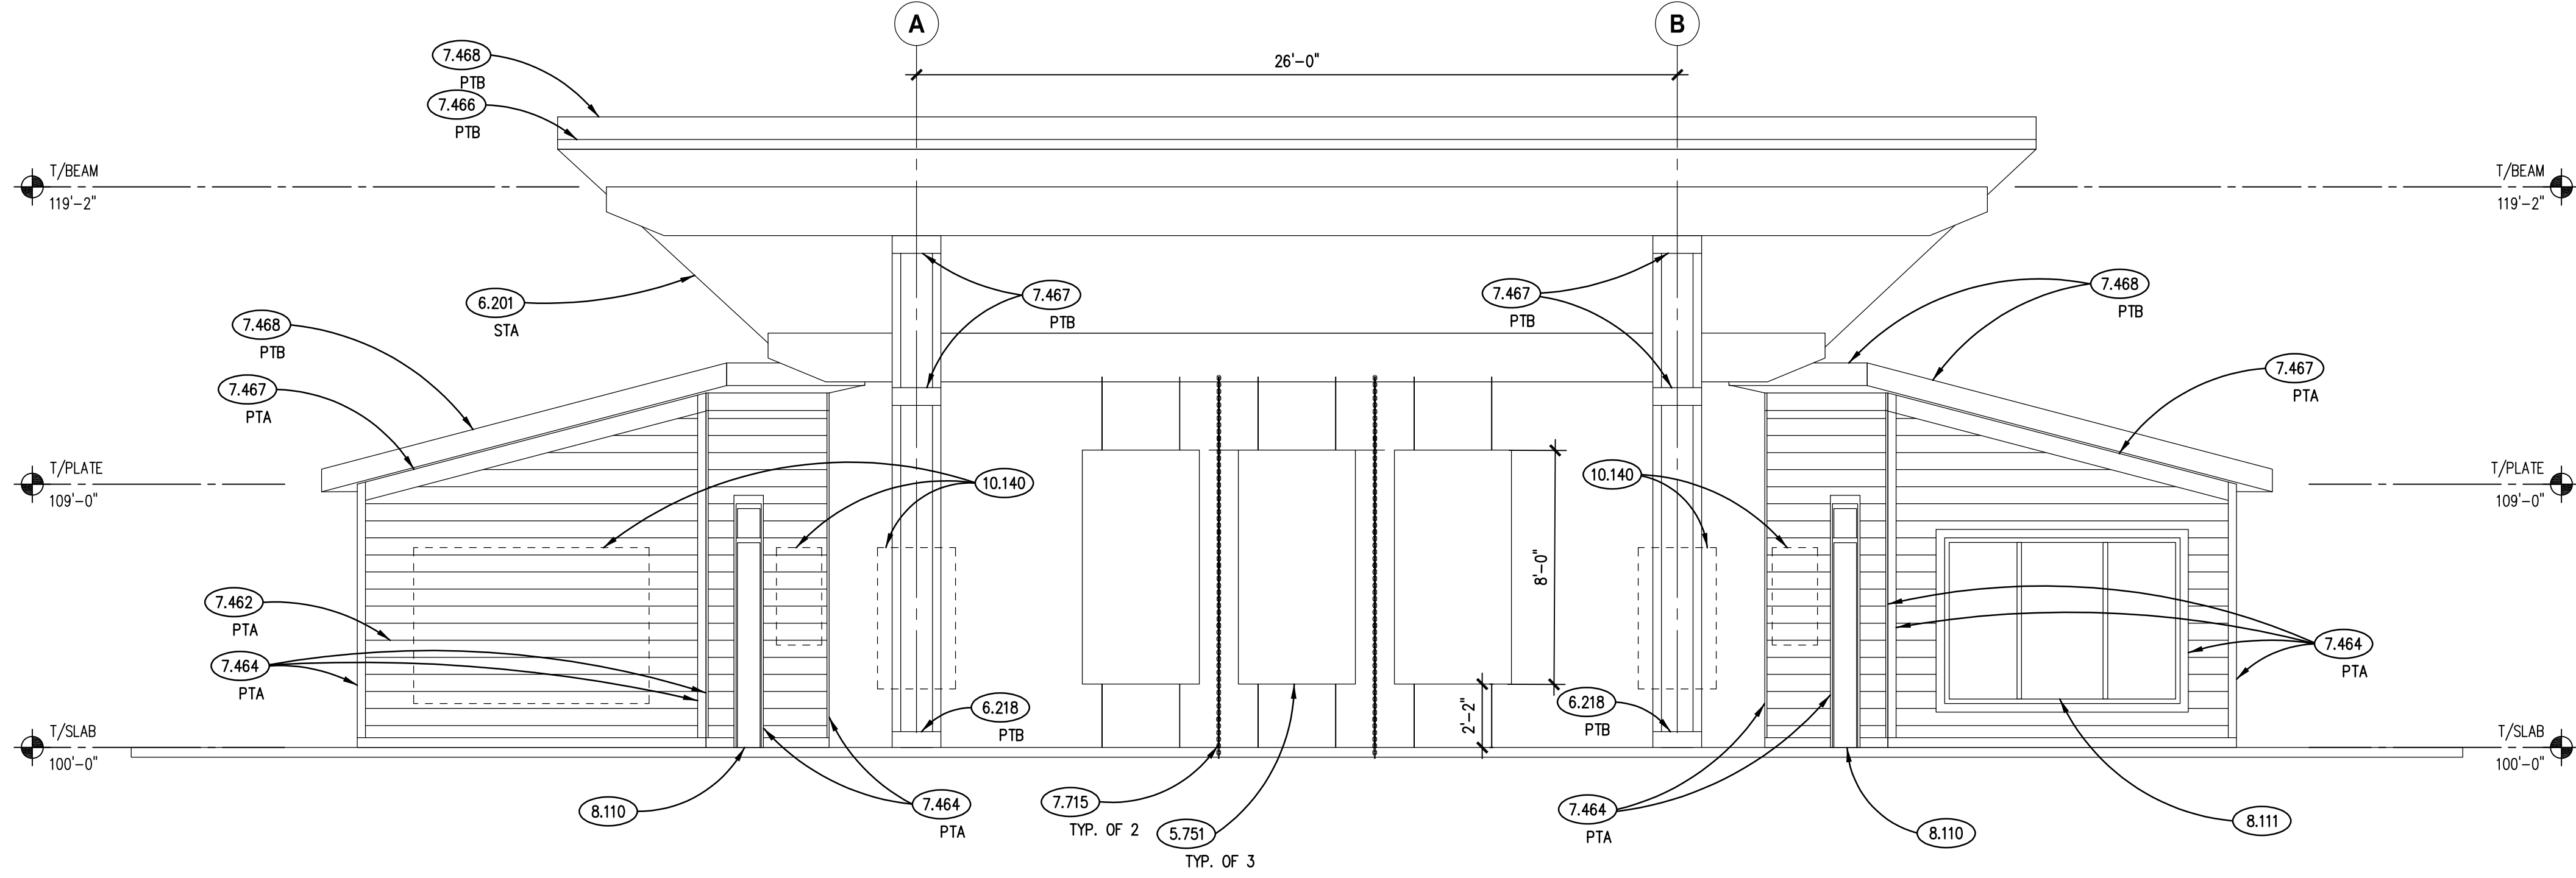

NORTH ELEVATION

SCALE: 1/4" = 1'-0"

1

GENERAL NOTES

1. REFER TO DRAWING G100 FOR PROJECT GENERAL NOTES.

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BID DOCUMENTS	

JOB NO. 23-429-1495
DRAWN SKF
CHECKED CJH
APPROVED CJH

SHEET TITLE

EXTERIOR BUILDING
ELEVATIONS


SHEET NUMBER

A700


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- 5.752 DECORATIVE METAL PANEL ACCESSORY: 1/2" DIA. STUD-END PLUG-LOCK WIRE ROPE END FITTING CONNECTED TO SIMPSON HANGER OR CAST INTO CONCRETE PIER, STAINLESS STEEL; REFER ALLOWANCES AND SPECIFICATIONS.
- 5.753 DECORATIVE METAL PANEL ACCESSORY: CLOSED BODY CLEVIS-TO-WIRE TURNBUCKLE END FITTING: SLEEVE ORIP, STAINLESS STEEL; REFER TO ALLOWANCES AND SPECIFICATIONS.
- 5.754 DECORATIVE METAL PANEL ACCESSORY: REINFORCED CABLE: 3/8" DIA. - 7 X 19 STRAND CORE WIRE ROPE ACCESSORY; REFER TO ALLOWANCES AND SPECIFICATIONS.
- 6.218 FINISH CARPENTRY: CELLULAR PVC TRIM: 1/2" x 7.25" (ACTUAL); REFER TO SPECIFICATIONS.
- 7.310 ASPHALT SHINGLE ROOFING SYSTEM. REFER TO SPECIFICATIONS.
- 7.462 FIBER CEMENT SIDING: 5/8" THK. HORIZONTAL V-GROOVE LAP SIDING; 7" EXPOSURE; PRIMED. REFER TO SPECIFICATIONS.
- 7.464 FIBER CEMENT SIDING: 3.5" X 5/4" TRIM BOARD; PRIMED.
- 7.467 FIBER CEMENT SIDING: 7.25" X 5/4" TRIM BOARD; PRIMED.
- 7.468 FIBER CEMENT SIDING: 9.25" X 5/4" TRIM BOARD; PRIMED.
- 7.712 METAL GUTTER: MATERIAL, 6 INCH K-OSEE PROFILE; THICKNESS AND FINISH AS SPECIFIED.
- 7.713 METAL DOWNSPOUT: MATERIAL, 3 INCH X 4 INCH RIBBED; THICKNESS AND FINISH AS SPECIFIED.
- 7.715 METAL DOWNSPOUT ACCESSORY: RAIN CHAIN: DOUBLE LOOPS RAIN CHAIN, BRONZE COLOR; REFER TO SPECIFICATIONS.
- 8.111 STEEL WINDOW FRAME: REFER TO DOOR, FRAME AND BORROWED LIGHT SCHEDULE.
- 10.140 SIGNAGE: INTREPRETIVE DISPLAY TYPE; REFER TO ALLOWANCES.



DOOR AND FRAME SCHEDULE

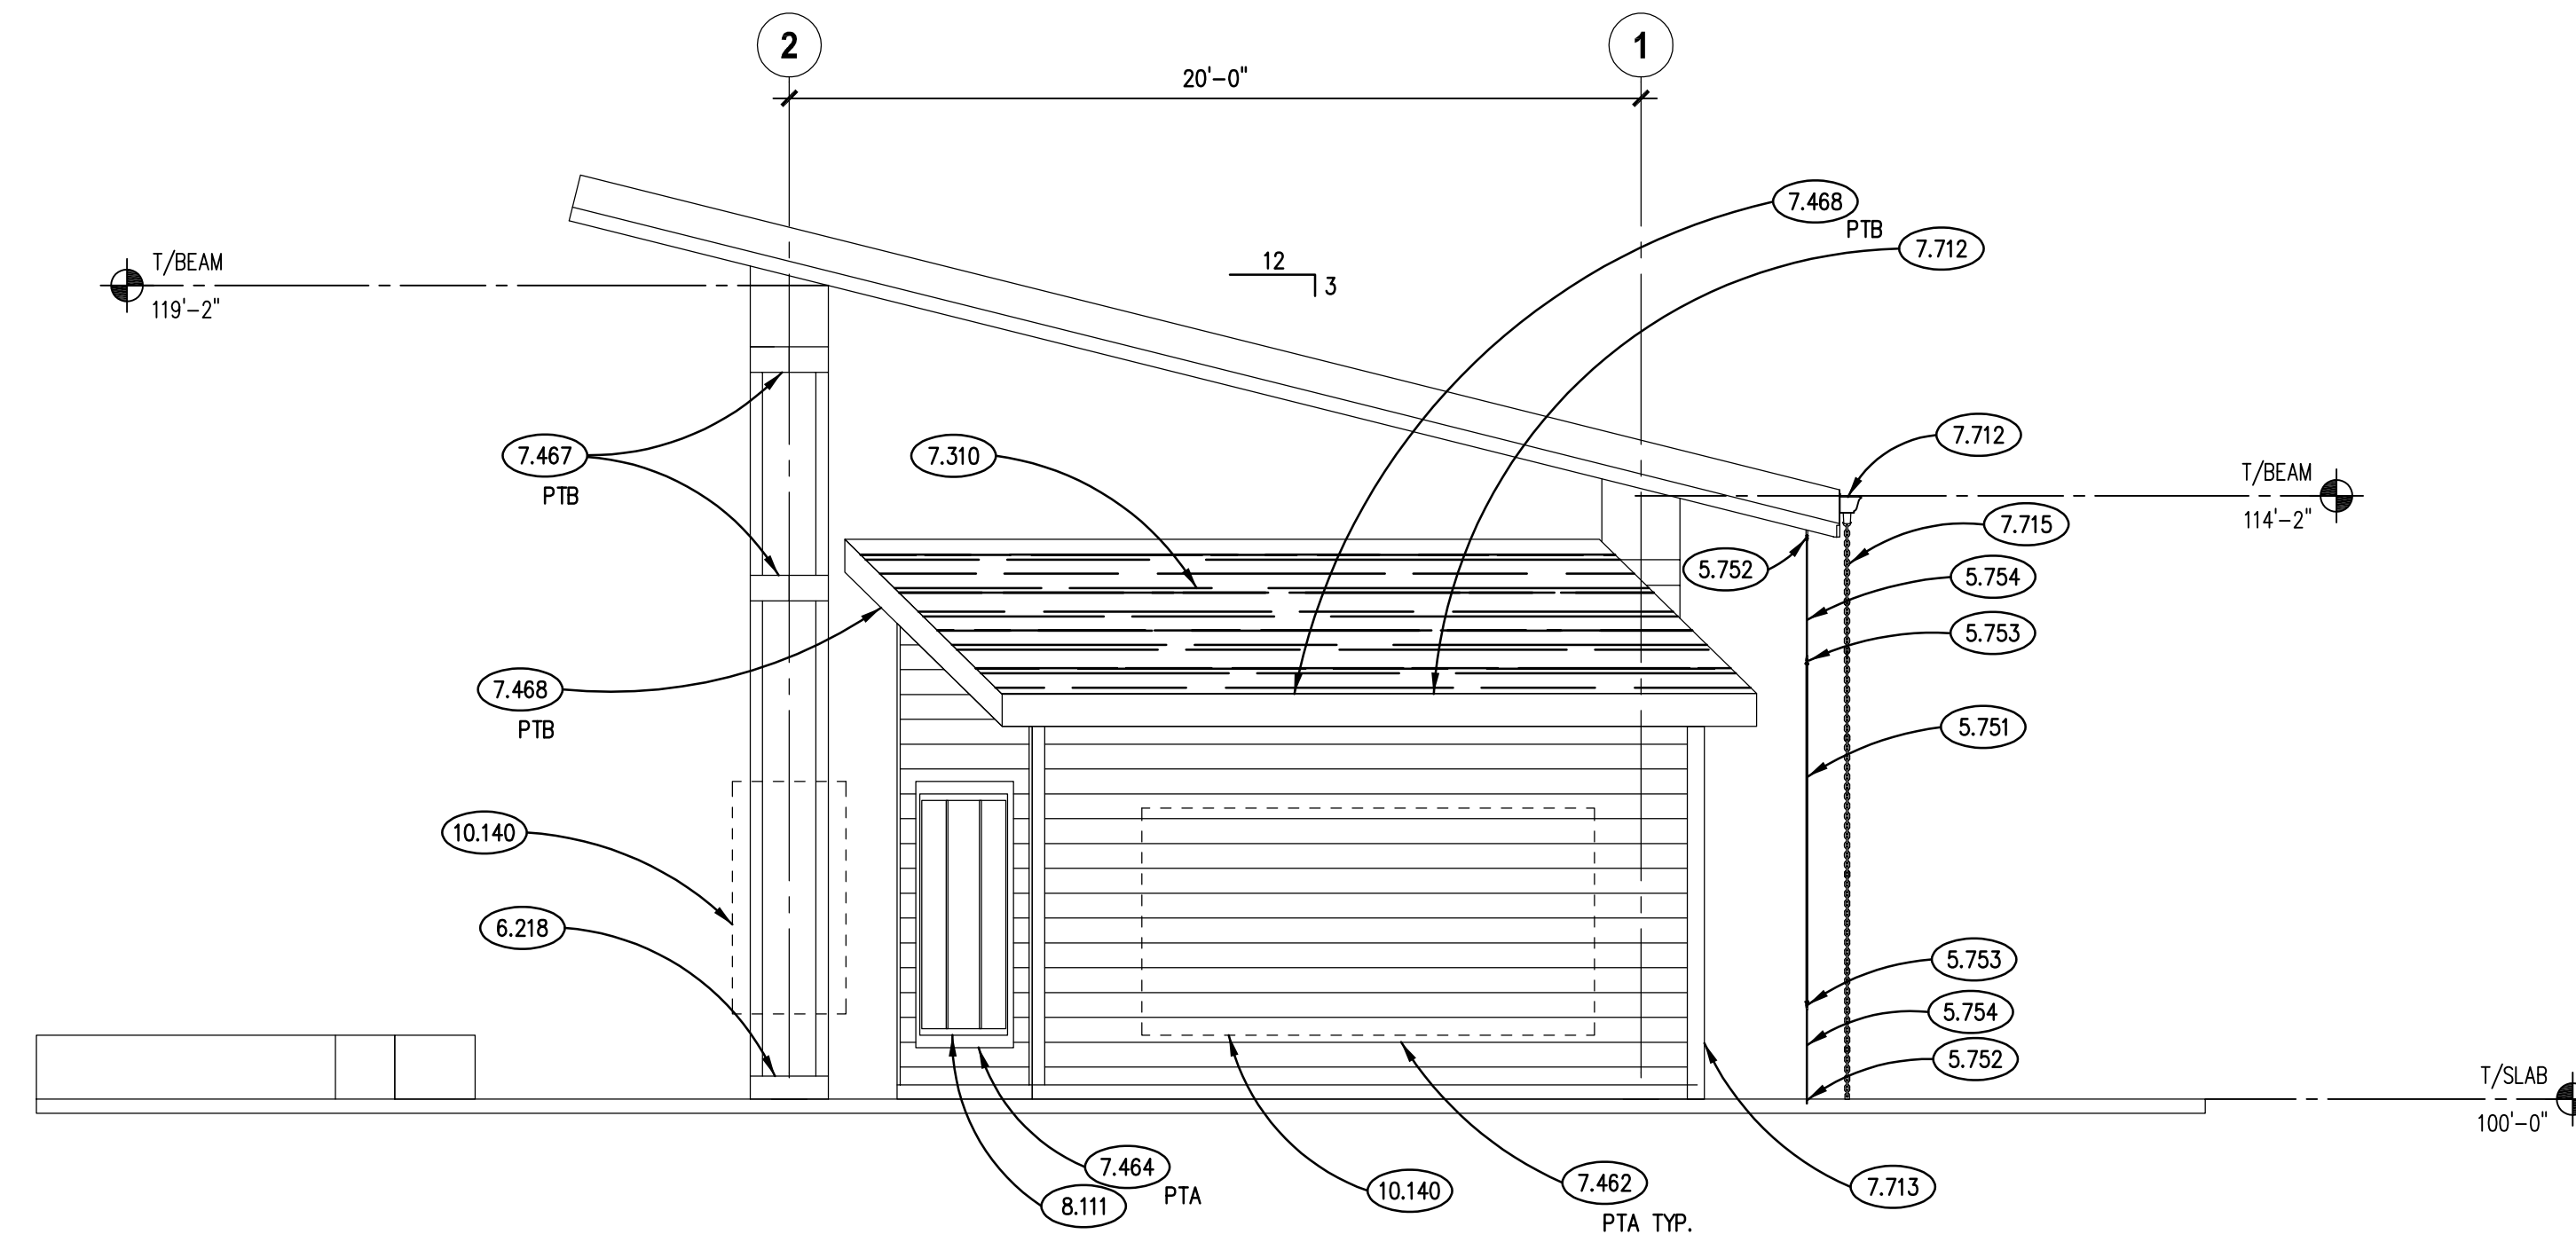[illegible]

DOOR TYPES

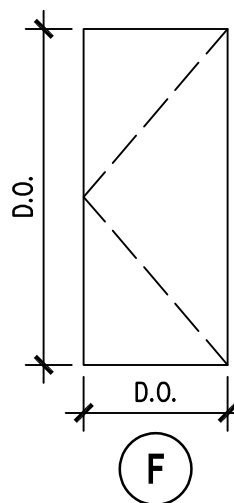
DOOR HARDWARE SCHEDULE

[illegible]

DOOR SCHEDULE REMARKS

1. PREP DOOR AND FRAME FOR ELECTRIC STRIKE.

FRAME TYPES

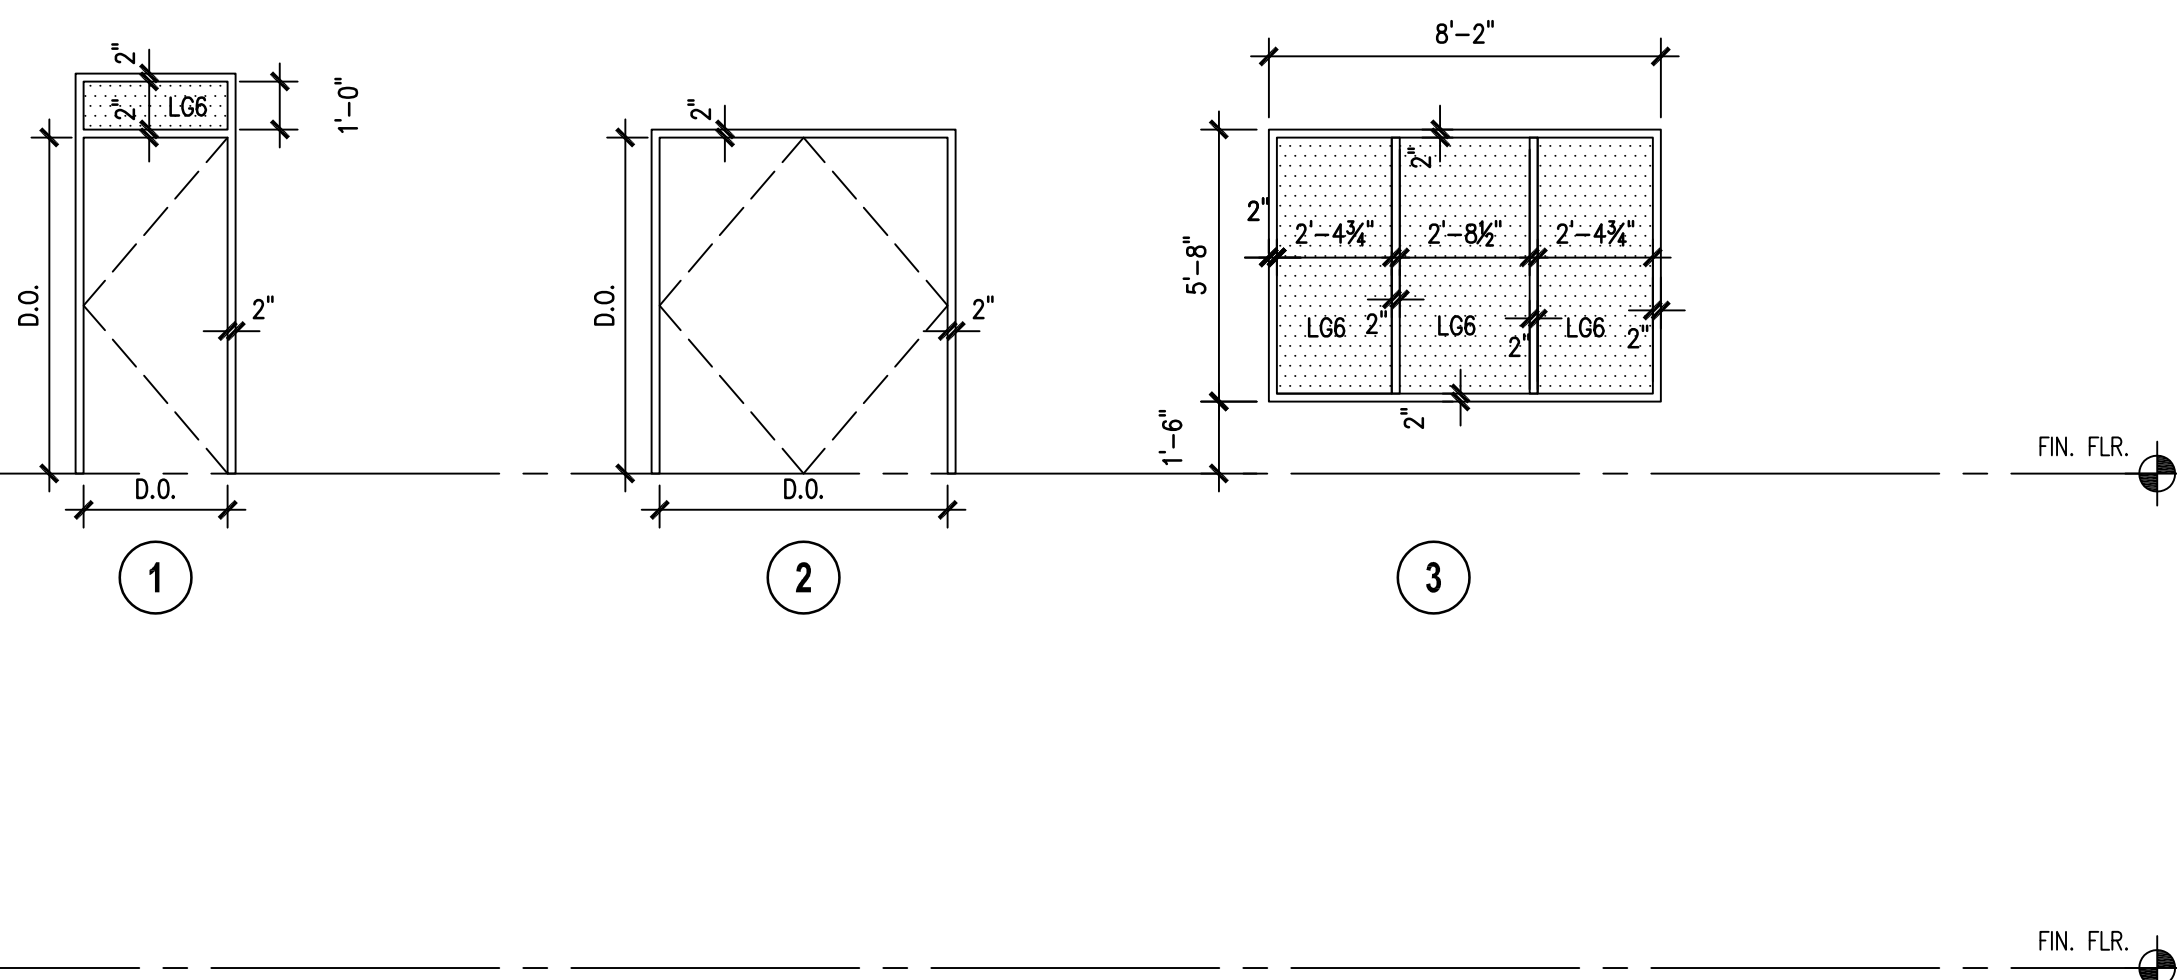

HARDWARE SCHEDULE REMARKS

1. TYPICAL EXTERIOR SHED DOOR HARDWARE: STOREROOM FUNCTION LOCKSET.
2. DISPLAY CASE DOUBLE DOOR HARDWARE: DUMMY LEVER TRIM ON PULL SIDE OF EACH DOOR LEAF; ROLLER LATCH FOR EACH LEAF; PROVIDE WALL STOPS FOR BOTH LEAVES, MOUNT RHR LEAF WALL STOP TO INSIDE FACE OF EXTERIOR DOOR.

DOOR SCHEDULE ABBREVIATIONS

DOOR / FRAME MATERIAL		STEEL DOOR GAGE		WOOD DOOR GRADE		WOOD DOOR VENEER CUTS	
AL	ALUMINUM	20	LEVEL 1 – STD. DUTY	P	PREMIUM	PS	PLAIN SLICED
STL	STEEL	18	LEVEL 2 – HEAVY DUTY	C	CUSTOM	QS	QUARTER SLICED
WD	WOOD	16	LEVEL 3 – EXTRA Hvy. DUTY	E	ECONOMY	RC	RF CUT
		14	LEVEL 4 – WAGON DUTY			R	ROTARY CUT
SPECIAL DOOR TYPES		STEEL DOOR MODEL		WOOD DOOR CORE			
AC	LACQUARED	1	FULL FLUSH	K	HONEYCOMB		
AP	ACCESS PANEL	1	FLUSH	M	MINERAL BOARD		WOOD DOOR VENEER MATCHING
DK	DARKROOM REVOLVING	2	SEAMLESS	PCS	5-PLY PARTICLE BOARD	BL	SLIP MATCH
HS	OVERHEAD HIGH-SPEED	3	STILE & RAIL	SC	SOUND-RATED	SK	SUO MATCH
OR	OVERHEAD ROLLING					RAN	RANDOM MATCH
OS	OVERHEAD SECTIONAL	K	HONEYCOMB		WOOD DOOR VENEER	E	END MATCH
RV	REVOLVING	M	MINERAL BOARD	BW	BIRCH – WHITE (SAPWOOD)	CON	CONTOUR MATCH
SC	OVERHEAD SECURITY GRILLS	PU	POLYURETHANE	FR	FRAMED HARBORWOOD	RUN	RUNNING MATCH
DOOR / FRAME FINISHES		SS	STEEL STEIFFERS	DFW	DECORATIVE LAMINATE	BAL	BALANCE MATCH
A	ANODIZED			MW	MAPLE – WHITE (SAPWOOD)	CB	CENTER BALANCE MATCH
P	PAINTED – SEE FIN. SCHED.			OR	RED OAK	P	PAIR MATCH
S	STAINED – SEE FIN. SCHED.			OW	WHITE OAK	S	SET MATCH
				PO	POPULAR		

HARDWARE MOUNTING HEIGHTS

HARDWARE COMPONENT	PREFERRED MOUNTING HEIGHT FROM BOTTOM OF DOOR FRAME	ACCEPTABLE RANGE IF PREFERRED MOUNTING HEIGHT NOT POSSIBLE
LOOKSETS, LATCHSETS	39" TO CENTERLINE OF LEVER	38" TO 42"
EXIT DEVICES	39" TO CENTERLINE OF PUSH PAD	38" TO 42"
DEADBOLT LOOKS	46" TO CENTERLINE OF CYLINDER	30" TO 48"
PUSH PLATES	45" TO CENTERLINE OF PUSH PLATE	N/A
PULLS, COMBINATION PUSH/PULL BARS	42" TO CENTERLINE OF PULL/BAR	N/A
ROLLER LATCHES	45" TO CENTERLINE OF LATCH STRIKE	N/A

COLOR CODE SCHEDULE

AREA	FINISH CODE	MATERIAL	MANUFACTURER	DESCRIPTION
WALLS	PTA	PAINT	SHERWIN WILLIAMS	COLOR: SW2803 ROOKWOOD TERRA COTTA
	PTB	PAINT	SHERWIN WILLIAMS	COLOR: SW6067 TURKISH COFFEE
CEILING	STA	STAIN/SEALER	PPG	CLEAR SATIN POLYURETHANE VARNISH
				REFER TO SPECIFICATIONS

FINISH TYPES

AREA	FIN.	DESCRIPTION	AREA	FIN.	DESCRIPTION
FLOOR	F1	NOT USED	CEILING	C1	NOT USED
BASE	B1	NOT USED			
WALLS	W1	NOT USED	PAINT	P1	LATEX - "EGGSHELL"
				P2	LATEX - "SEMI-GLOSS"
				P3	LATEX - "SATIN"
				P4	NOT USED
GLASS	L66	SECURITY GLAZING LAMINATED GLASS		P5	PREFINISHED: REFER TO SPECS.

GENERAL NOTES

1. REFER TO DRAWING G100 FOR PROJECT GENERAL NOTES.
2. REFER TO ELEVATIONS AND DETAILS FOR SPECIFIC FINISH LOCATIONS.

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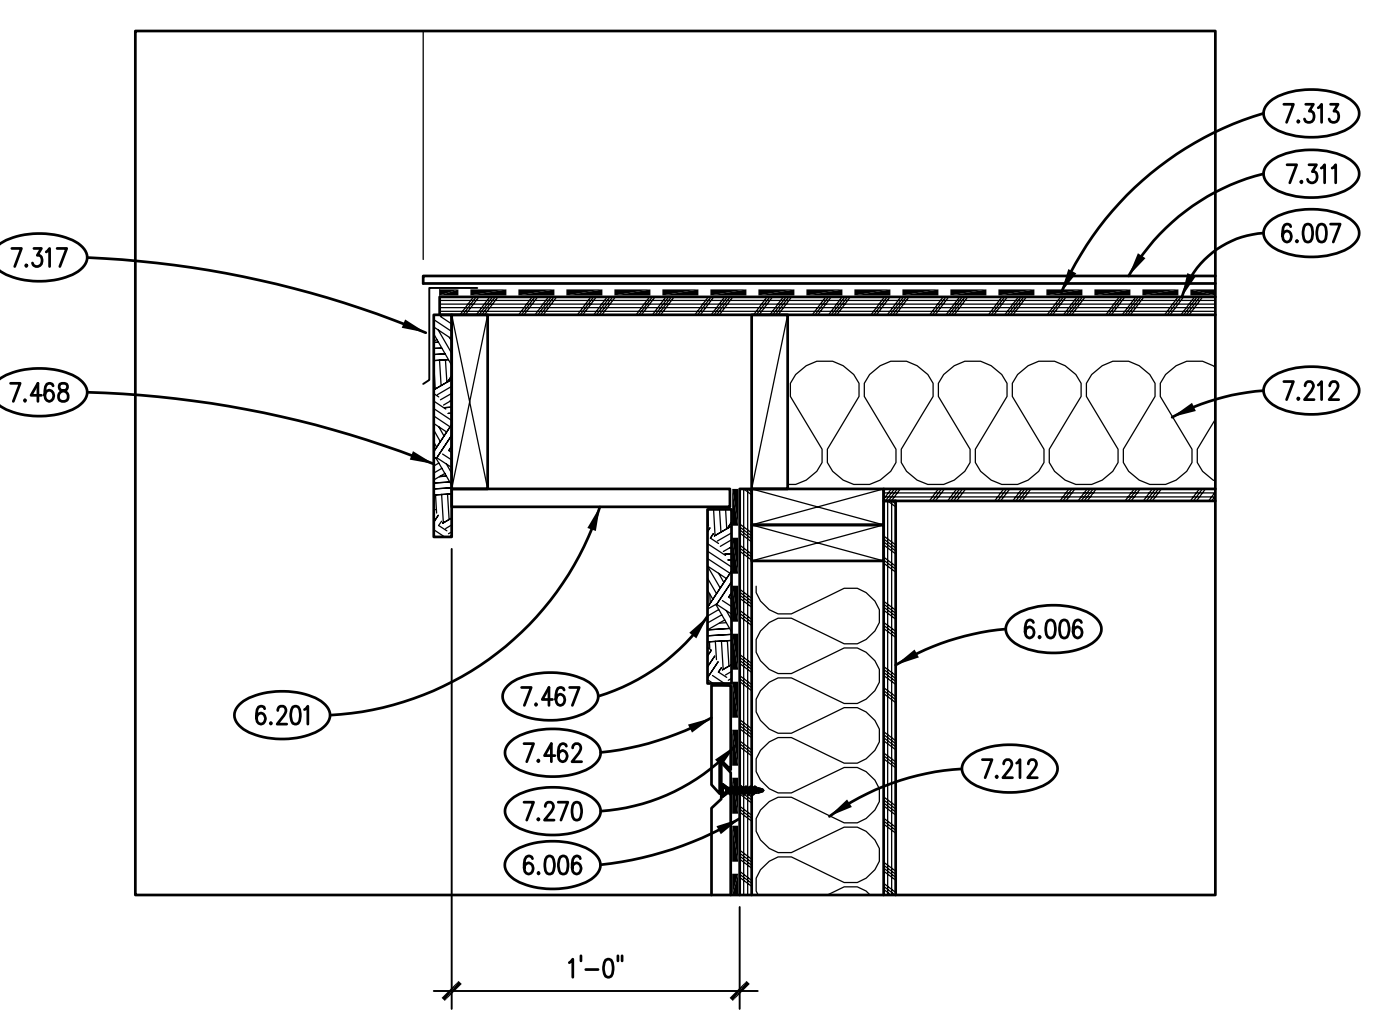
[illegible]

JOB NO. 23-429-149
DRAWN SK
CHECKED CDI
APPROVED CJI

**DOOR, FRAME
HARDWARE
SCHEDULES**

SHEET NUMBER

A800




CANOPY RAKE DETAIL 16
SCALE: 3" = 1'-0"

DOOR JAMB DETAIL 12
SCALE: 3" = 1'-0"

TYPICAL HEAD DETAIL 8
SCALE: 3" = 1'-0"

ROOF RAKE DETAIL 4


SCALE: 1½" = 1'-0"

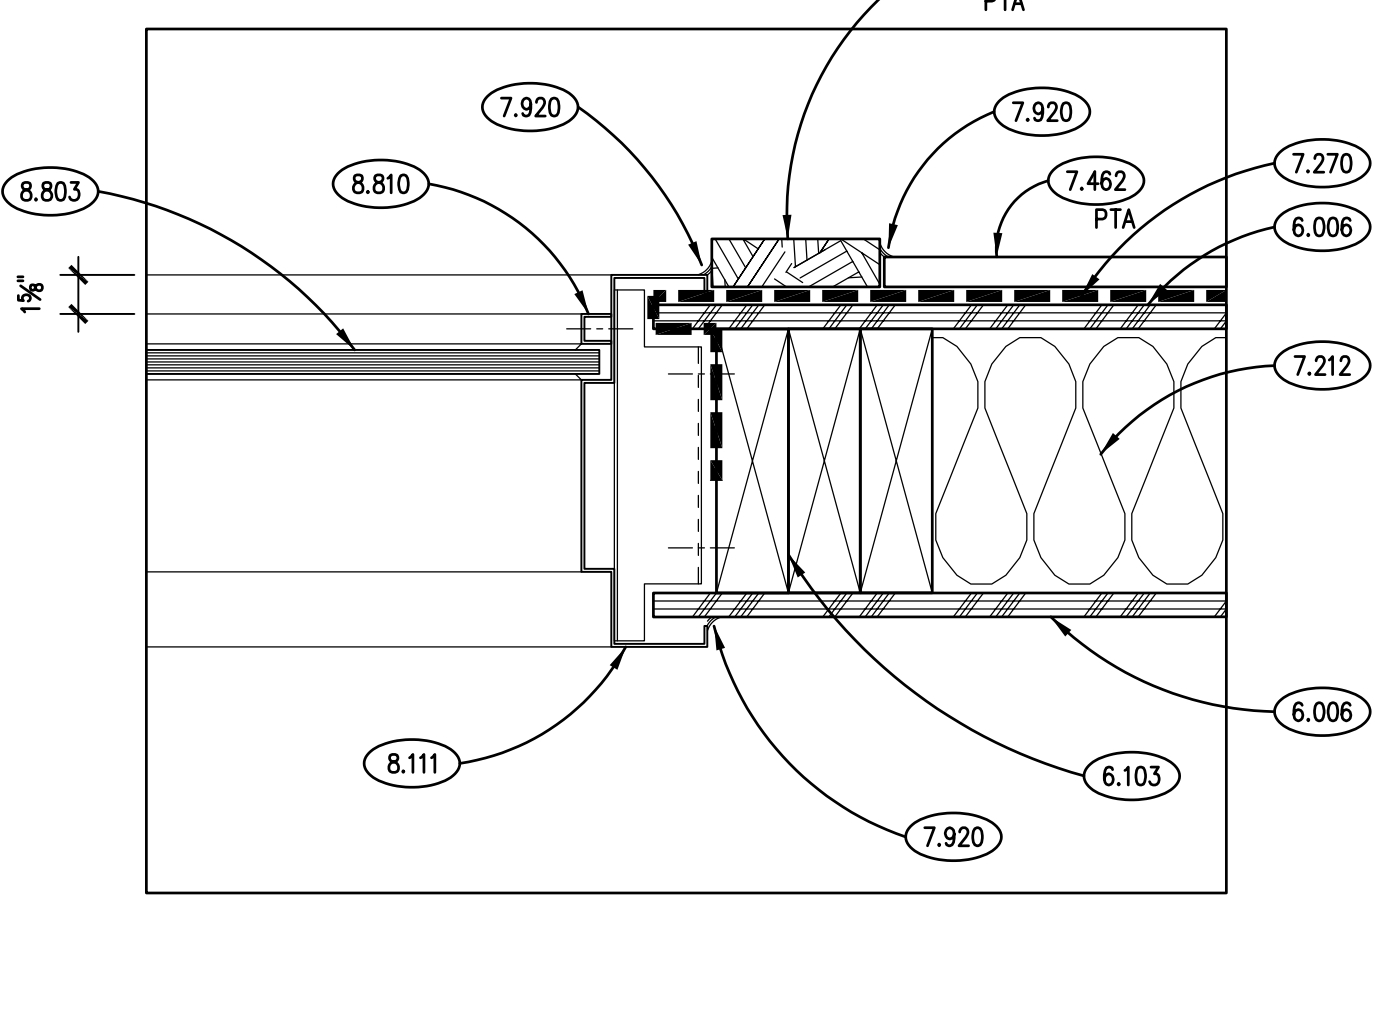

CANOPY RAKE DETAIL 15
SCALE: 1½" = 1'-0"

DOOR JAMB DETAIL 11
SCALE: 3" = 1'-0"


WINDOW JAMB DETAIL 7
SCALE: 3" = 1'-0"

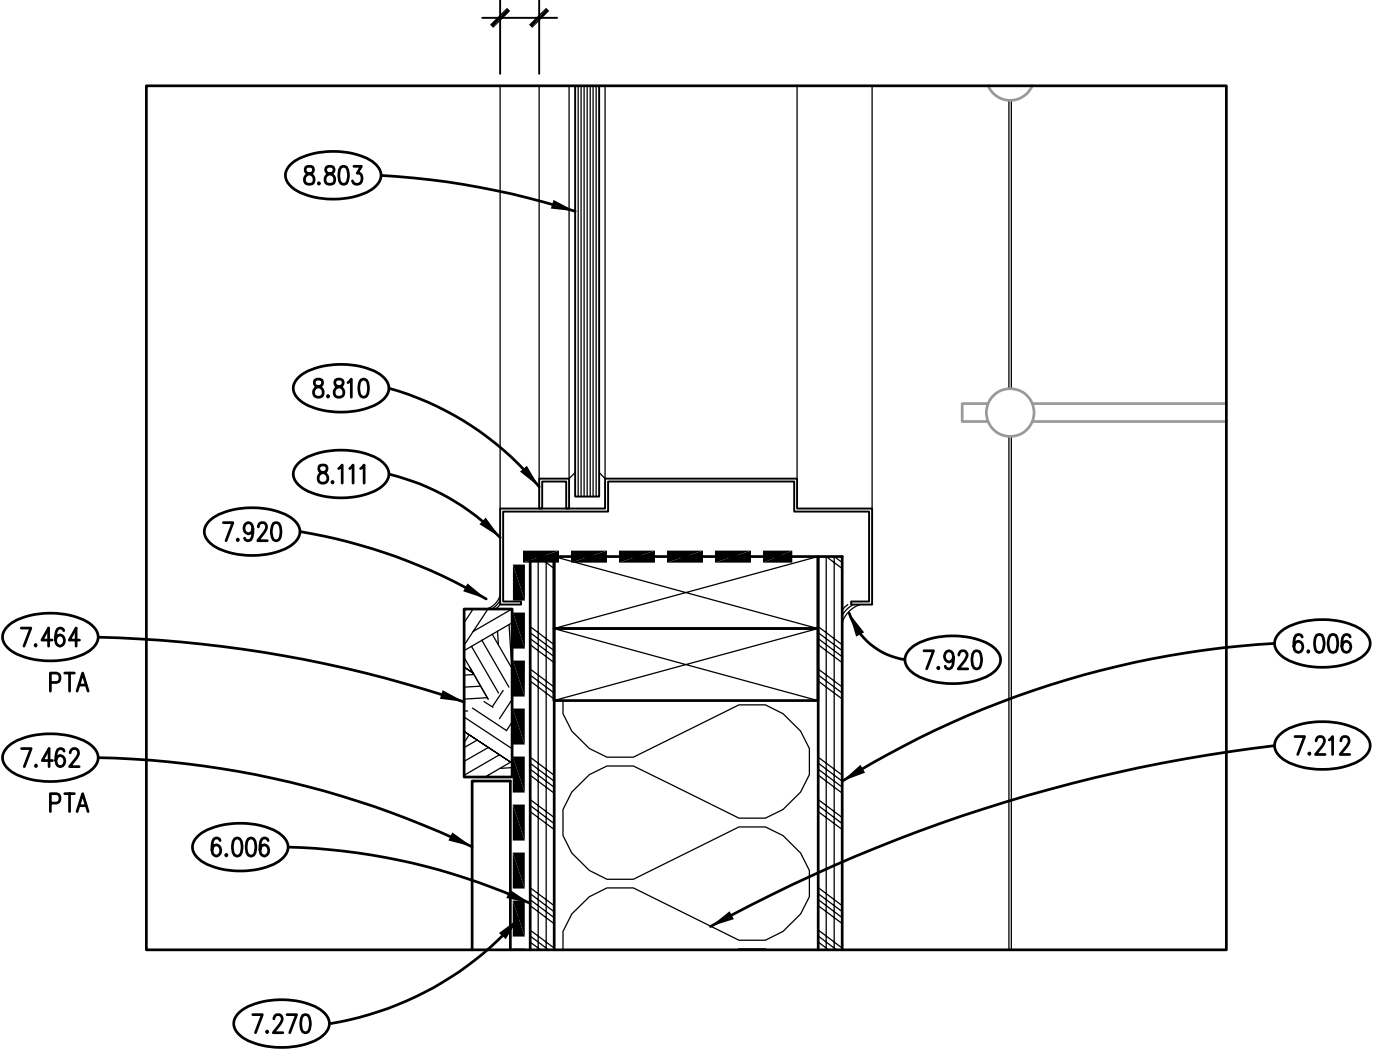

SECTION DETAIL 14
SCALE: 1½" = 1'-0"

SECTION DETAIL **10**
SCALE: 1½" = 1'-0"


WINDOW SILL DETAIL (6)
SCALE: 3" = 1'-0"

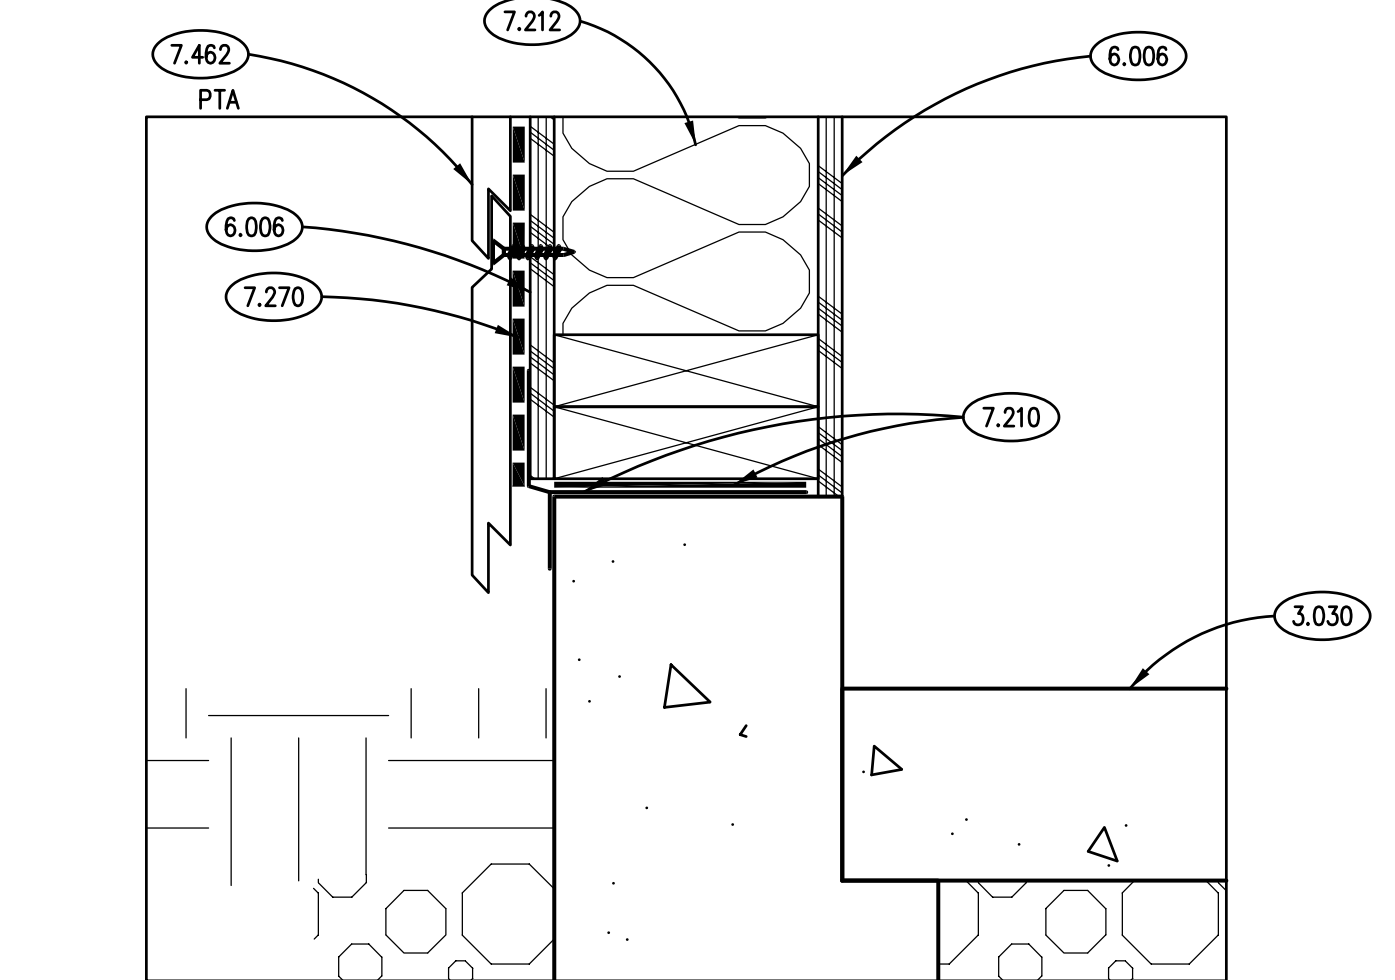

SECTION DETAIL **13**
SCALE: 1 1/2" = 1'-0"

SECTION DETAIL 9
SCALE: 1½" = 1'-0"

TYPICAL SECTION DETAIL 5
SCALE: 3" = 1'-0"

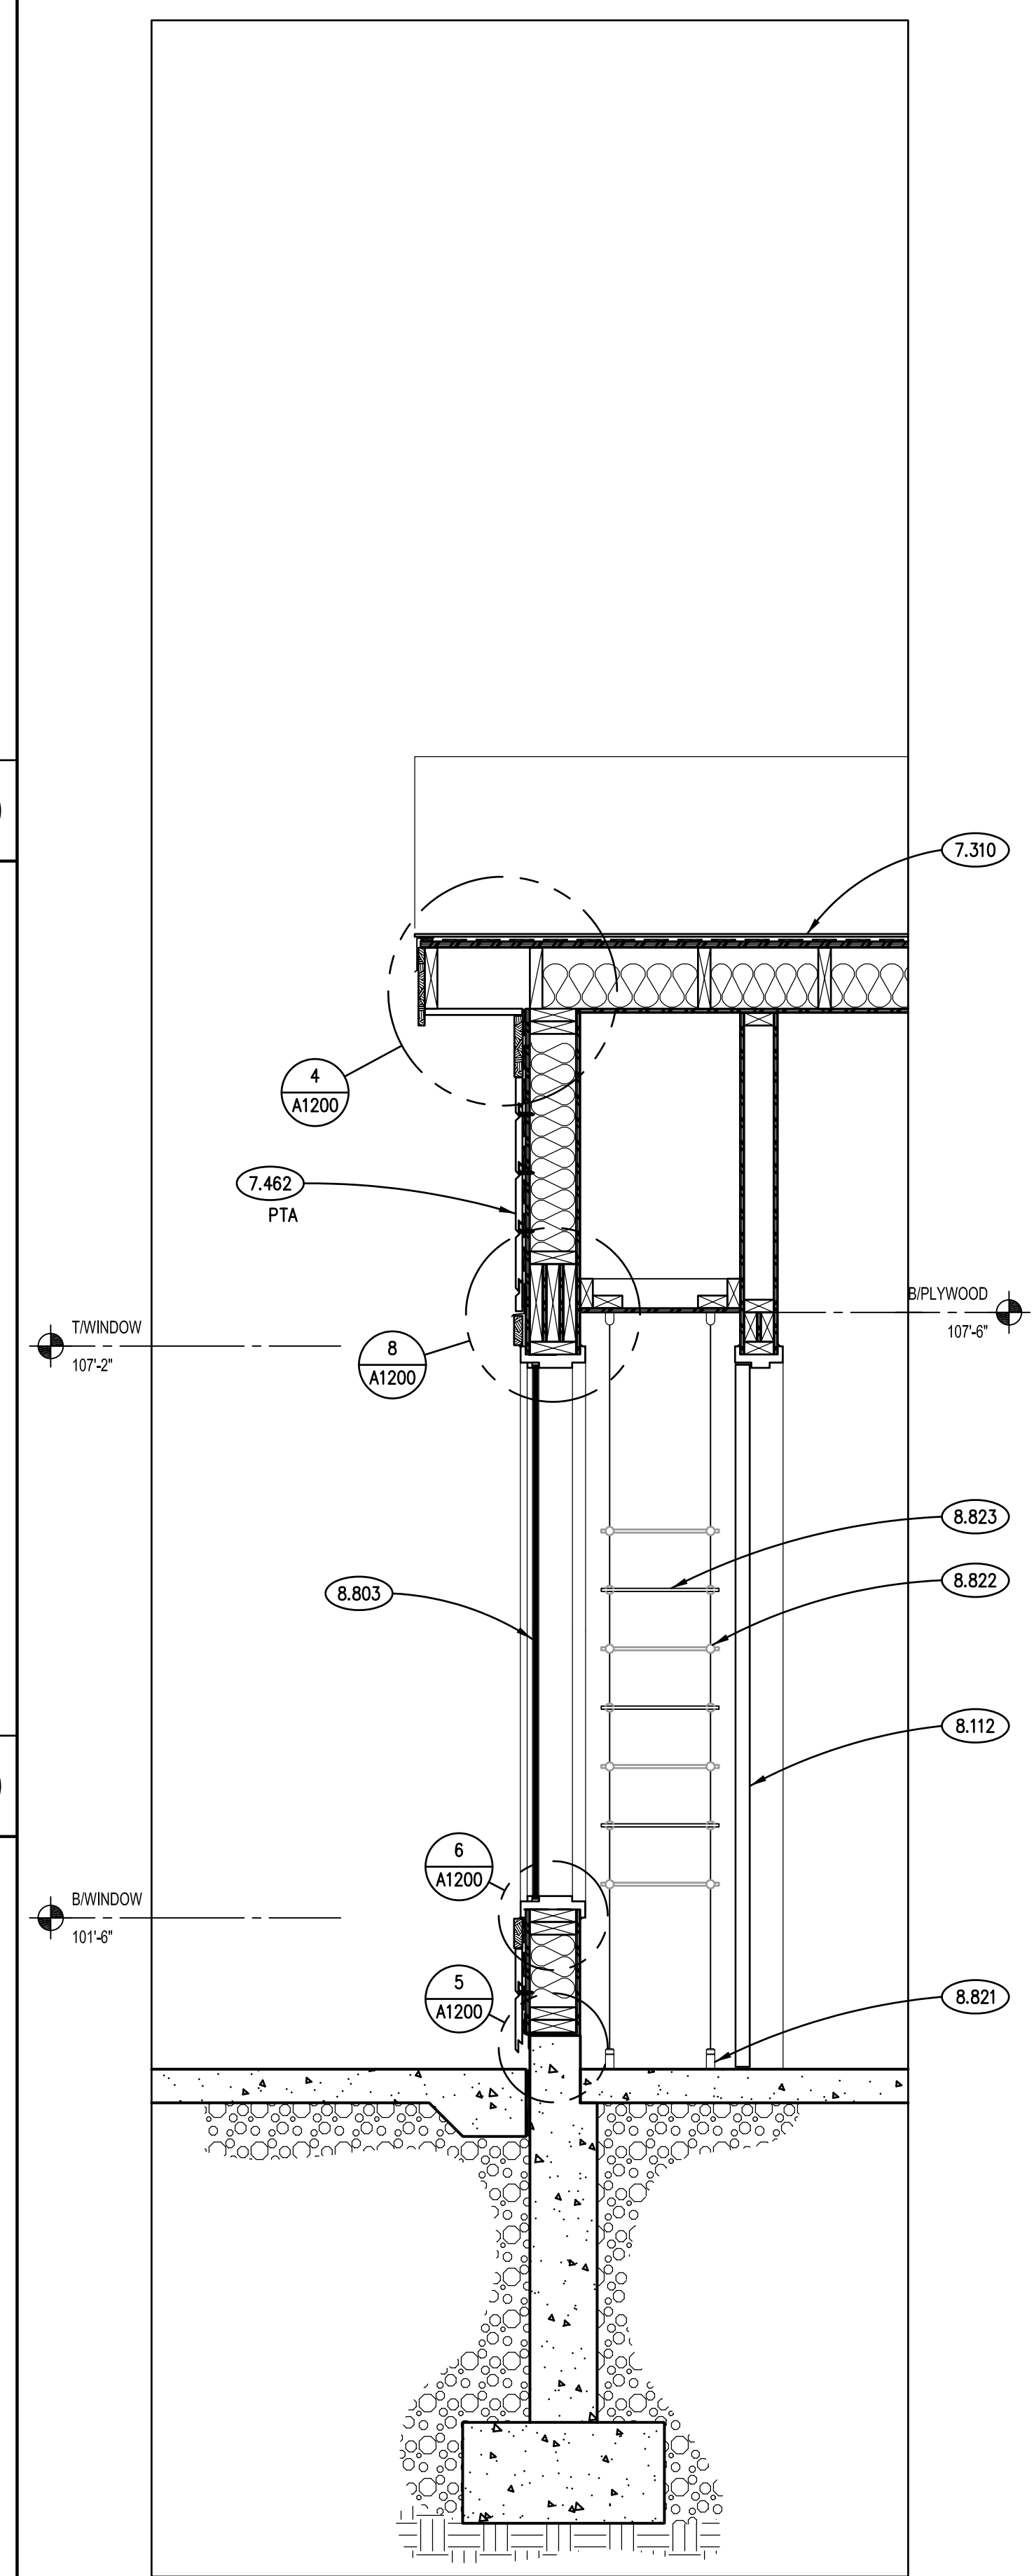

WALL SECTION 3
SCALE: 3/4" = 1'-0"


KEYNOTES

KEYNOTES ARE NOT ALWAYS REPEATED ACROSS ALL DRAWINGS ON THIS SHEET. AN UN-KEYNOTED ITEM ON THIS SHEET IS THE SAME AS A KEYNOTED ITEM ON THIS SHEET HAVING THE SAME GRAPHIC APPEARANCE.


- 6.030 CAST-IN-PLACE CONCRETE: REFER TO STRUCTURAL DRAWINGS.
- 5.011 STRUCTURAL STEEL: COLUMN; REFER TO STRUCTURAL DRAWINGS.
- 5.080 METAL FABRICATION: STEEL PLATE; REFER TO STRUCTURAL DRAWINGS.
- 5.081 METAL FABRICATION: STEEL BEAM CADDLE; REFER TO STRUCTURAL DRAWINGS.
- 5.092 DECORATIVE METAL PANEL ACCESSORY: 1/2" DIA. STUD-END PLUG-LOCK WIRE ROPE END FITTING CONNECTED TO SIMPSON HANGER OR CAST INTO CONCRETE PIER, STAINLESS STEEL; REFER ALLOWANCES AND SPECIFICATIONS
- 5.754 DECORATIVE METAL PANEL ACCESSORY: REINFORCED CABLE: 3/8" DIA. - 7 X 19 STRAND CORE WIRE ROPE ACCESSORY; REFER TO ALLOWANCES AND SPECIFICATIONS.
- 6.001 ROUGH CARPENTRY: WOOD BLOCKING; DIMENSIONAL LUMBER; SIZE AS INDICATED; REFER TO SCHEDULE FOR TREATMENT.
- 6.002 ROUGH CARPENTRY: WOOD BLOCKING; DIMENSIONAL LUMBER; SIZE AS REQUIRED; REFER TO SCHEDULE FOR TREATMENT.
- 6.006 ROUGH CARPENTRY: BEAM/HEAD: 1/2" THICK; REFER TO SPECIFICATIONS FOR TREATMENT.
- 6.007 ROUGH CARPENTRY: PLYWOOD: 3/4" THICK; REFER TO SPECIFICATIONS FOR TREATMENT.
- 6.100 WOOD FRAMING: PLYWOOD/HEADER; REFER TO STRUCTURAL DRAWINGS.
- 6.103 WOOD FRAMING: STUDS; REFER TO STRUCTURAL DRAWINGS.
- 6.173 WOOD I-JOIST: REFER TO STRUCTURAL DRAWINGS FOR SIZE AND SPACING.
- 6.201 FINISH CARPENTRY: EXTERIOR SOFFIT LUMBER; 1 X 6 TONGUE AND GROOVE.
- 7.212 INSULATION: THERMAL BATT; KRAFT FACED FIBERGLASS; THICKNESS TO FILL CAVITY, UNLESS INDICATED OTHERWISE; R-21.
- 7.219 INSULATION ACCESSORY: FORMED FOAM Baffle FOR ATTIC VENTILATION; REFER TO SPECIFICATIONS.
- 7.220 INSULATION ACCESSORY: SILL PLATE SEALER; CLOSED-CELL FOAM TAPE TYPE WITH RUBBERIZED ADHESIVE MEMBRANE; REFER TO SPECIFICATIONS.
- 7.270 AIR BARRIER SHEET MEMBRANE; REFER TO SPECIFICATIONS.
- 7.310 ASPHALT SHINGLE ROOFING SYSTEM: REFER TO SPECIFICATIONS.
- 7.311 ASPHALT SHINGLES; ARCHITECTURAL LAMINATED TYPE.
- 7.313 ASPHALT SHINGLES SHEET MATERIAL: UNDERLAYMENT.
- 7.316 ASPHALT SHINGLES METAL FLASHING: GUTTER APRON; MATERIAL, THICKNESS AND FINISH AS SPECIFIED.
- 7.317 ASPHALT SHINGLES METAL FLASHING: DOWE ASHING; MATERIAL, THICKNESS AND FINISH AS SPECIFIED.
- 7.460 FIBER CEMENT SIDING: REFER TO SPECIFICATIONS.
- 7.462 FIBER CEMENT SIDING: 5/8" THICK HORIZONTAL V-GROOVE LAP SIDING; 7" EXPOSURE; PRIMED; REFER TO SPECIFICATIONS.
- 7.464 FIBER CEMENT SIDING: 3.5" X 5/4" TRIM BOARD; PRIMED.
- 7.465 FIBER CEMENT SIDING: 4.5" X 5/4" TRIM BOARD; PRIMED.
- 7.466 FIBER CEMENT SIDING: 5.5" X 5/4" TRIM BOARD; PRIMED.
- 7.467 FIBER CEMENT SIDING: 7.25" X 5/4" TRIM BOARD; PRIMED.
- 7.468 FIBER CEMENT SIDING: 9.25" X 3/4" TRIM BOARD; PRIMED.
- 7.470 FIBER CEMENT SIDING ACCESSORY: DOOR/WINDOW PREFINISHED METAL HEAD FLASHING; INSTALL OVER HEAD AND UNDER AIR BARRIER. TAIL ALL JOINTS.
- 7.620 METAL COPING FLASHING: MATERIAL, THICKNESS AND FINISH AS SPECIFIED.
- 7.712 METAL GUTTER: MATERIAL: 6 INCH X-GOE PROFILE; THICKNESS AND FINISH AS SPECIFIED.
- 7.715 METAL DOWNSPOUT ACCESSORY: RAIN CHAIN: DOUBLE LOOPS RAIN CHAIN, BRONZE COLOR; REFER TO SPECIFICATIONS.
- 7.716 METAL DOWNSPOUT ACCESSORY: RAIN CHAIN ACCESSORY: INSTALLATION KIT; REFER TO SPECIFICATIONS.
- 7.920 METAL DRAIN: REFER TO SCHEDULE IN SPECIFICATION SECTION 07 92 00; PROVIDE BACKER ROD OR BOND BREAKER.
- 8.110 STEEL DOOR FRAME: REFER TO DOOR, FRAME AND BORROWED LIGHT SCHEDULE.
- 8.111 STEEL WINDOW FRAME: REFER TO DOOR, FRAME AND BORROWED LIGHT SCHEDULE.
- 8.112 STEEL DOOR: REFER TO DOOR, FRAME AND BORROWED LIGHT SCHEDULE.
- 8.115 STEEL FRAME ACCESSORY: DOOR FRAME ANCHORS (PIND AT JAMBS ONLY).
- 8.803 GLAZING: LAMINATED GLASS TYPE LG-6; REFER TO SPECIFICATIONS.
- 8.810 GLAZING ACCESSORY: GLAZING STOP.
- 8.821 DISPLAY GLAZING SYSTEM ACCESSORY: TOP OR BOTTOM FILING AND CABLE; REFER TO SPECIFICATIONS.
- 8.822 DISPLAY GLAZING SYSTEM ACCESSORY: SHIELD SUPPORTS, CABLE MOUNTED AND FULLY ADJUSTABLE; REFER TO SPECIFICATIONS.
- 8.823 DISPLAY GLAZING SYSTEM ACCESSORY: TEMPERED GLASS SHELVES: 14 INCH X 36 INCH X 10MM THICKNESS; REFER TO SPECIFICATIONS.
- 26.005 PROVIDE 2-2" AND 2-3/4" EMPTY PVC CONDUIT FROM FUTURE PANEL LOCATION TO SE CORNER OF WEST ROOM AS SHOWN. STUB AND CAP. TRANSITION TO GALVANIZED RIGID STEEL CONDUIT ABOVE GRADE. ROUTE CONDUIT THROUGH COLUMN TO ACCESSIBLE CEILING LOCATION.

GENERAL NOTES

1. REFER TO DRAWING G100 FOR PROJECT GENERAL NOTES

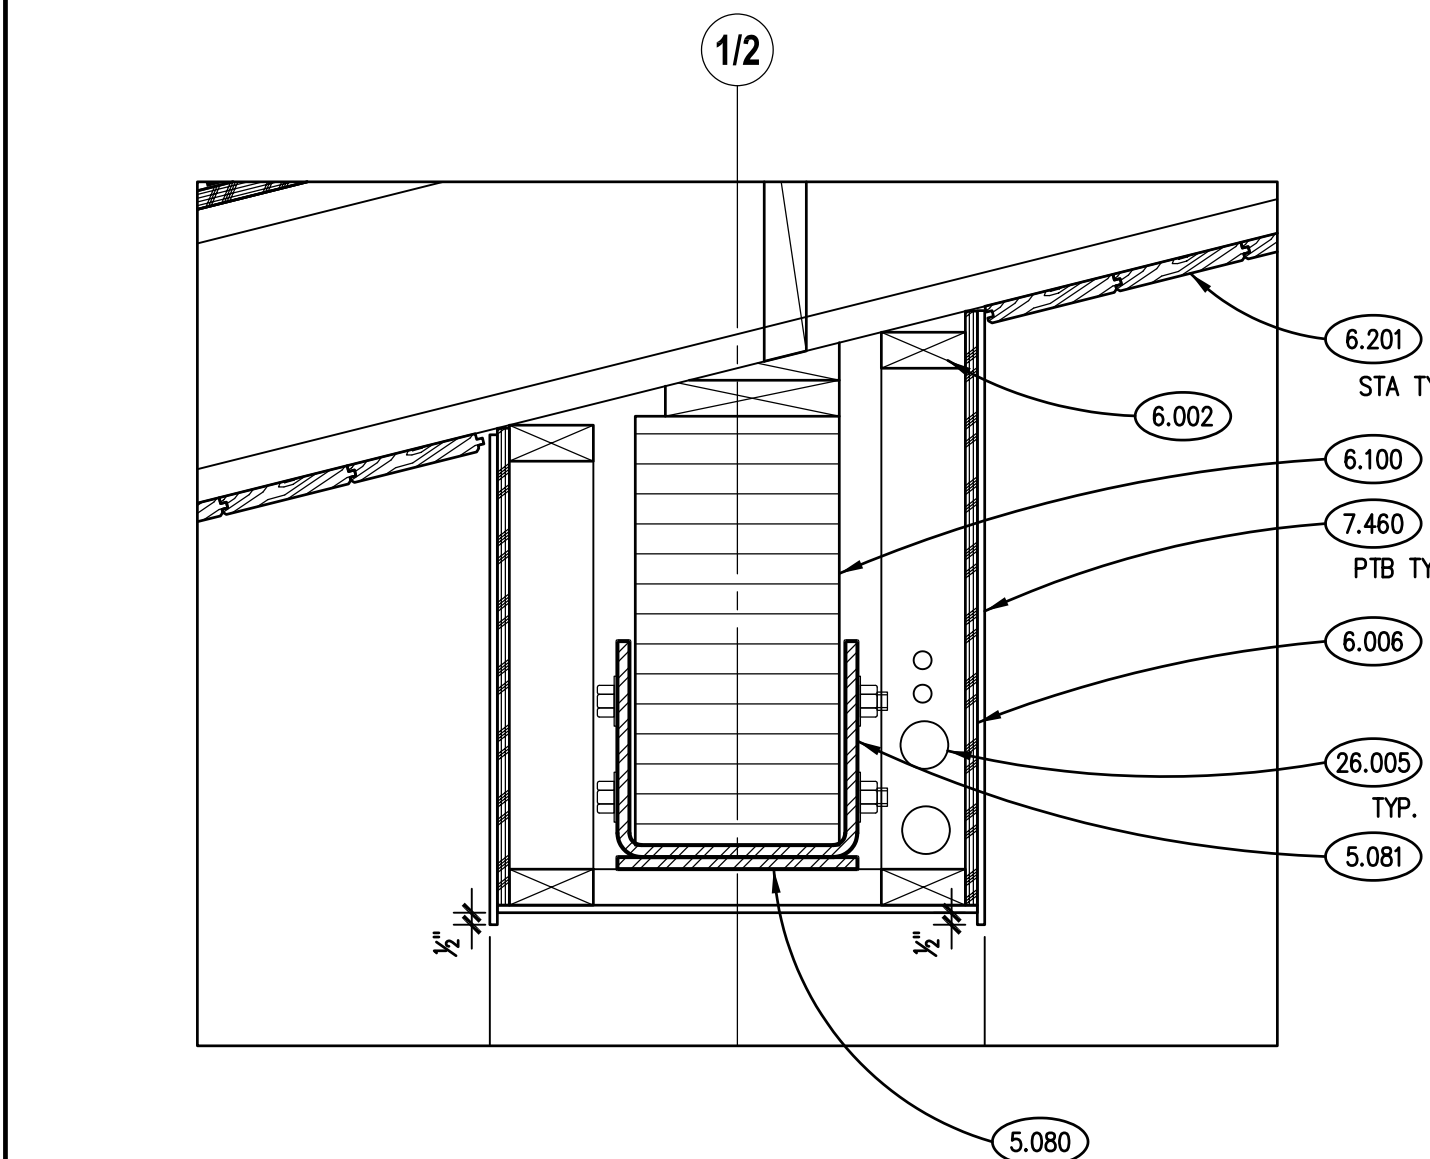

SECTION DETAIL (2)
SCALE: 1½" = 1'-0"

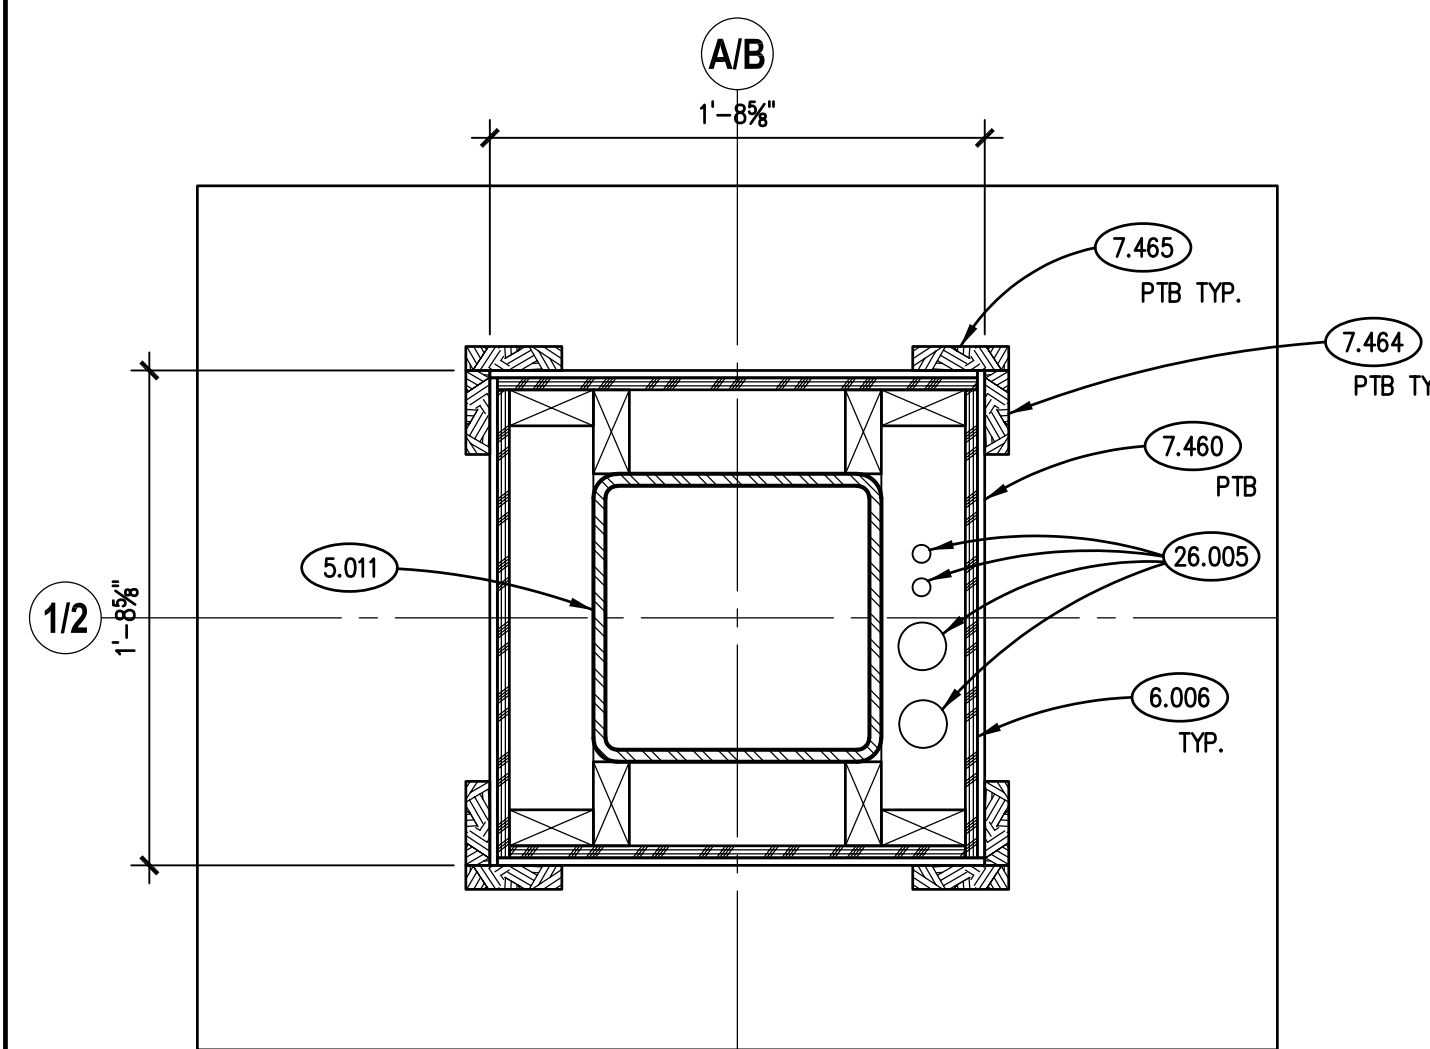

TYP. COLUMN PLAN DETAIL 1
SCALE: 1½" = 1'-0"

NOTE: SCALES DEPICTED ON THIS DRAWING ARE NOT CORRECT UNLESS PLOTTED SHEET SIZE IS 30 X 42 INCHES.

SUBAT NATURE CENTER

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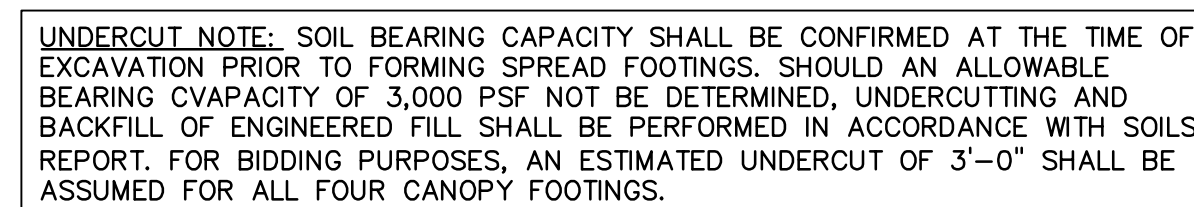
ISSUED	
04/10/24	OWNER REVIEW
04/11/24	BID DOCUMENTS

JOB NO.	23-429-1495
DRAWN	PJT
CHECKED	CJH
APPROVED	CJH

SECTION DETAILS

SHEET NUMBER

A1200



The image contains two technical drawings, Section 3A and Section 3B, showing cross-sections of a building structure. Both sections show a vertical wall with various components and dimensions.

Section 3A (Left): This section shows a wall with a top flange (6.116, 6.156) and a base (6.101, 6.132). The wall is labeled "VARIES" and has a height of "5'-6\" CLER. OPENING". The base is labeled "T&B" and has a width of "2'-0\"". The wall is labeled "H1" and has a height of "1'-7\"". The wall is labeled "H3" and has a height of "1'-7\"". The wall is labeled "H3" and has a height of "1'-7\"".


Section 3B (Right): This section shows a wall with a top flange (6.116, 6.156) and a base (6.101, 6.132). The wall is labeled "VARIES" and has a height of "5'-6\" CLER. OPENING". The base is labeled "T&B" and has a width of "2'-0\"". The wall is labeled "H1" and has a height of "1'-7\"". The wall is labeled "H3" and has a height of "1'-7\"". The wall is labeled "H3" and has a height of "1'-7\"".

NOTE: SECTION IS PORTRAYING FRAMING CONDITIONS AT NORTH WALL OF WEST SHED BEYOND. SIMILAR LOCATIONS DO NOT HAVE DISPLAY WINDOW OPENING, AND STANDARD WALL FRAMING AS DEPICTED IN SECTION 2 SHALL BE COMPLETED.

KEYNOTES

KEYNOTES ARE TYPICALLY NOT DUPLICATED WITHIN A GIVEN DETAIL.
AN UN-KEYNOTED ITEM IN A DETAIL IS THE SAME AS A KEYNOTED
ITEM HAVING THE SAME APPEARANCE WITHIN THE SAME DETAIL.

- 3.211 CONCRETE REINFORCING: CONTINUOUS WALL/FOOTING REINFORCING. REFER TO SECTIONS AND SCHEDULES. PROVIDE (2)-#5 BARS U.O. OR DEPICTED.
- 3.221 CONCRETE REINFORCING: #4 DOWELS @ 1'-4" C.O. HORIZONTAL LEG= 1'-0", VERTICAL LEG= 4'-6" U.N.O.
- 3.236 CONCRETE REINFORCING: #5 BARS @ 12" U.O. LONG SONOTUBE ANCHORAGE FOUNDATION. PROVIDE (4)-#4 VERTICAL BARS & (2)-#3 CLOSED LOOP STRIPPIRS AT TOP 4" OF PIER, COORDINATE WITH ARCHITECTURAL FABRICATION DETAILS FOR REQUIRED MATERIALS TO BE CAST INTO TOP OF PIERS.
- 3.240 CONCRETE REINFORCING: #5 VERTICAL BARS HOOKED INTO FOOTING (QUANTITY AS DEPICTED) AND #4 TIES @ FOLLOWING SPACING: (3) @ 2', (1) @ 4', R @ 12" U.N.O. PIER DIMENSIONS AS NOTED.
- 3.243 CONCRETE REINFORCING: #5 VERTICAL BARS HOOKED INTO PILE CAP (QUANTITY AS DEPICTED) AND #4 TIES @ FOLLOWING SPACING: (3) @ 2', (1) @ 4', R @ 12" U.N.O. PIER DIMENSIONS AS NOTED.
- 3.246 CONCRETE REINFORCING: PROVIDE AS NOTED.
- 3.255 CONCRETE REINFORCING: #4 DOWEL X 2'-0" @ 1'-6" C.O. U.N.O. ANCHOR INTO EXISTING SLAB/WALL/FOOTING USING INJECTION ADHESIVE/EPPOXY SYSTEM PER PROJECT SPECIFICATIONS. EMBEDMENT TO BE 4" U.N.O.
- 3.300 CAST-IN-PLACE CONCRETE: INTERIOR SLAB-ON-GRADE. REFER TO PLAN, SCHEDULE AND SPECIFICATIONS FOR THICKNESS, REINFORCING, MIX TYPE AND FINISH.
- 3.304 CAST-IN-PLACE CONCRETE: EXTERIOR SLAB-ON-GRADE. REFER TO SPECIFICATIONS FOR MIX TYPE AND FINISH. REFER TO PLAN & SCHEDULE FOR REINFORCING. REFER TO PLAN AND ARCHITECTURAL DRAWINGS FOR ELEVATIONS AND SLOPES.
- 3.310 CAST-IN-PLACE CONCRETE: FOUNDATION WALL. REFER TO PLAN, DETAILS AND SPECIFICATIONS FOR THICKNESS, REINFORCING, MIX TYPE AND FINISH.
- 3.319 CAST-IN-PLACE CONCRETE: 8"X 4'-0" LONG SONOTUBE ANCHORAGE FOUNDATION; PROVIDE (4)-#4 VERTICAL BARS & (2)-#3 CLOSED LOOP STRIPPIRS AT TOP 4" OF PIER, COORDINATE WITH ARCHITECTURAL FABRICATION DETAILS FOR REQUIRED MATERIALS TO BE CAST INTO TOP OF PIERS.
- 3.320 CAST-IN-PLACE CONCRETE: CONTINUOUS WALL FOOTING. REFER TO PLAN, SCHEDULE AND SPECIFICATIONS FOR THICKNESS, REINFORCING AND MIX TYPE.
- 3.321 CAST-IN-PLACE CONCRETE: SPREAD FOOTING. REFER TO PLAN, SCHEDULE AND SPECIFICATIONS FOR THICKNESS, SIZE, REINFORCING AND MIX TYPE.
- 5.101 STRUCTURAL STEEL: STEEL COLUMN. REFER TO PLAN AND SCHEDULE.
- 5.122 STRUCTURAL STEEL: BASEPLATE & SETTING PLATE. REFER TO COLUMN SCHEDULE.
- 6.100 WOOD FRAMING: LOAD BEARING WALL. SEE PLAN, SCHEDULE AND DETAILS FOR SIZE, SPECIES AND SPACING.
- 6.101 WOOD FRAMING: BEAM/HEADER. SEE PLAN, SCHEDULE AND DETAILS FOR SIZE AND SPECIES. IF OUT SIDES TO MATCH WALL WITH FINISH APPLICABLE.
- 6.105 WOOD FRAMING: FULL HEIGHT POST/COLUMN. SEE PLAN, SCHEDULE AND DETAILS FOR SIZE, SPECIES AND QUANTITY.
- 6.106 WOOD FRAMING: ROOF JOIST. SEE PLAN, SCHEDULE AND DETAILS FOR SIZE, SPECIES AND SPACING.
- 6.115 WOOD FRAMING: APA RATED SHEATHING. SEE PLAN, SCHEDULE AND DETAILS FOR TYPE, THICKNESS AND ATTACHMENT REQUIREMENTS.
- 6.116 WOOD FRAMING: OUTRIGGER 2x FRAMING: @ 16" C.O. MATCH SIZE OF SURROUNDING JOIST FRAMING; PROVIDE 2x BLOCKING BETWEEN OUTRIGGERS ALONG WALL PLATE.
- 6.132 WOOD FRAMING: CONTINUOUS PRESSURE TREATED SILL PLATE. SIZE AND SPECIES TO MATCH WALL FRAMING. ATTACH TO FOUNDATION WALL WITH 1/2"x6"x8" LONG + 3" HOOKED ANCHOR ROODS @ 4'-0" C.O. U.N.O.
- 6.135 WOOD FRAMING: CONTINUOUS DOUBLE TOP PLATE. SIZE AND SPECIES TO MATCH WALL FRAMING. PROVIDE (2)-16d NAILS INTO EACH STUD FOR LOWER PLATE PLATE. ATTACH UPPER TOP PLATE USING (2)-16d NAILS @ 2'-0" C.O. LAP LOWER TOP PLATE SPLICED MINIMUM OF 2'-0". CORNERS AND INTERSECTIONS TO BE OVERLAPPED WITH A MINIMUM OF (4)-16d NAILS.
- 6.137 WOOD FRAMING: CONTINUOUS SINGLE TOP PLATE.
- 6.156 WOOD FRAMING: CONTINUOUS RIM BOARD TO MATCH JOIST DEPTH. ANCHOR INTO JOIST ENDS WITH (4)-16d NAILS.
- 6.168 WOOD FRAMING: PROVIDE SILL 2x4 BLOCKING BETWEEN JOISTS; ATTACH USING (2)-16d NAILS @ EACH END.
- 6.171 WOOD FRAMING: CONNECTION: LIGHT GAUGE WOOD CONSTRUCTION CONNECTOR AS NOTED MANUFACTURED BY SIMPSON STRONG-TIE OR EQUIVALENT PER MANUFACTURER'S RECOMMENDATIONS. PROVIDE NAIL TYPE AND QUANTITIES RESULTING IN THE MAXIMUM TABULATED CAPACITIES.
- 6.177 WOOD FRAMING ASSEMBLY: SHEARWALL HOLDDOWN ANCHOR. SEE SHEARWALL SCHEDULE.

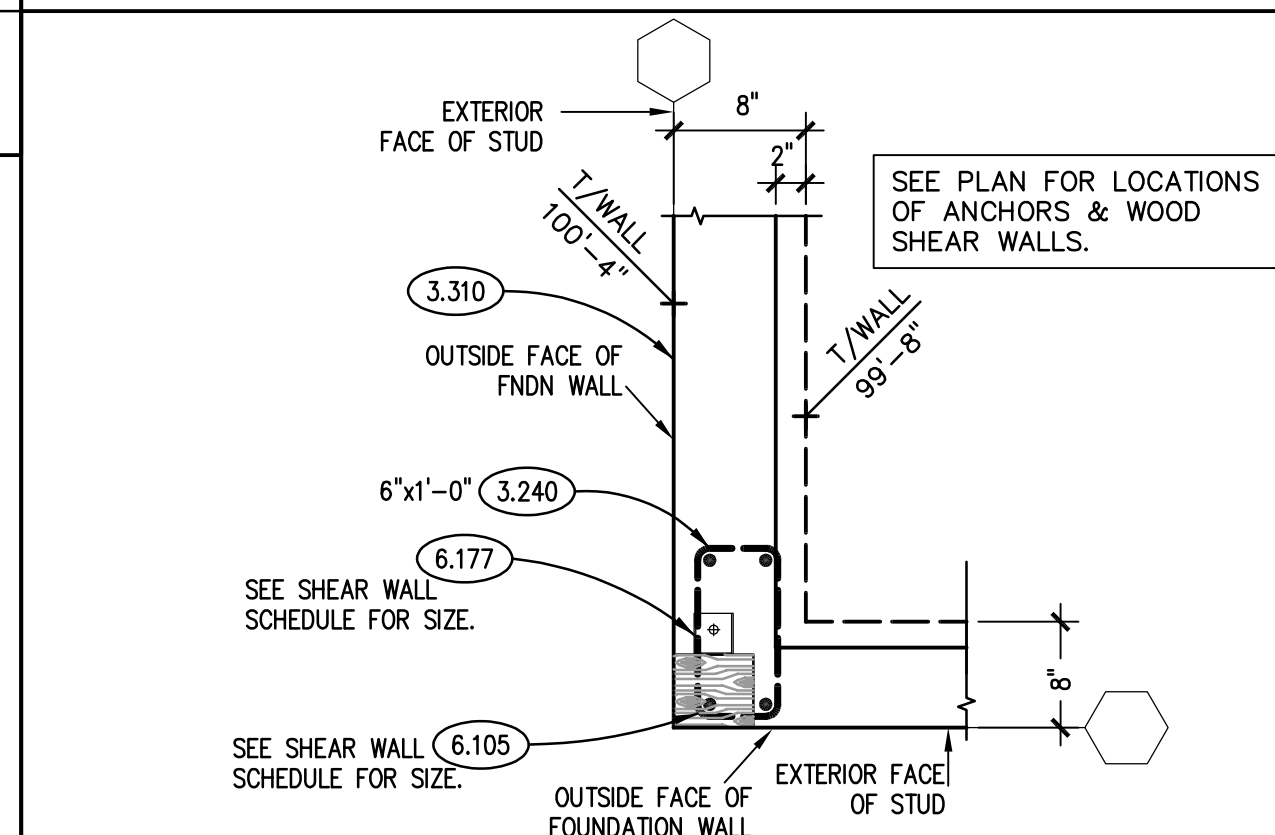

SPREAD FOOTING SCHEDULE


MARK	DIMENSIONS			REINFORCING STEEL			SPECIAL COMMENTS
	LENGTH (L)	WIDTH (B)	THICK (t)	BOTTOM LENGTH (L)	BOTTOM WIDTH (B)	TOP	
SF6.0	6'-0"	6'-0"	2'-0"	(11)-#5	(11)-#5	YES	

SPREAD FOOTING NOTES AND DETAILS

NOTES:

1. SEE PLAN FOR FOOTING LOCATIONS.
2. FOOTING SIZES BASED UPON NOTE #12 INDICATED ON SHEET S010. FOOTINGS TO BEAR ON UNDISTURBED SOILS/ENGINEERED FILL ASSUMED TO BE AT THE DESIGN ELEVATIONS NOTED ON THE PLANS.
3. CONTRACTOR TO HAVE A QUALIFIED SOIL TESTING AGENCY CONFIRM THE SOIL AT THE BASE OF THE FOOTING EXCAVATIONS PRIOR TO CASTING THE CONCRETE, ALL UNSUITABLE MATERIALS TO BE REMOVED AND REPLACED IN ACCORDANCE WITH THE PROJECT SOILS REPORT.
4. CENTERLINE OF FOOTING TO BE CENTERED ON COLUMNS, PIERS AND WALLS U.N.O. ON PLAN.

DETAILS:

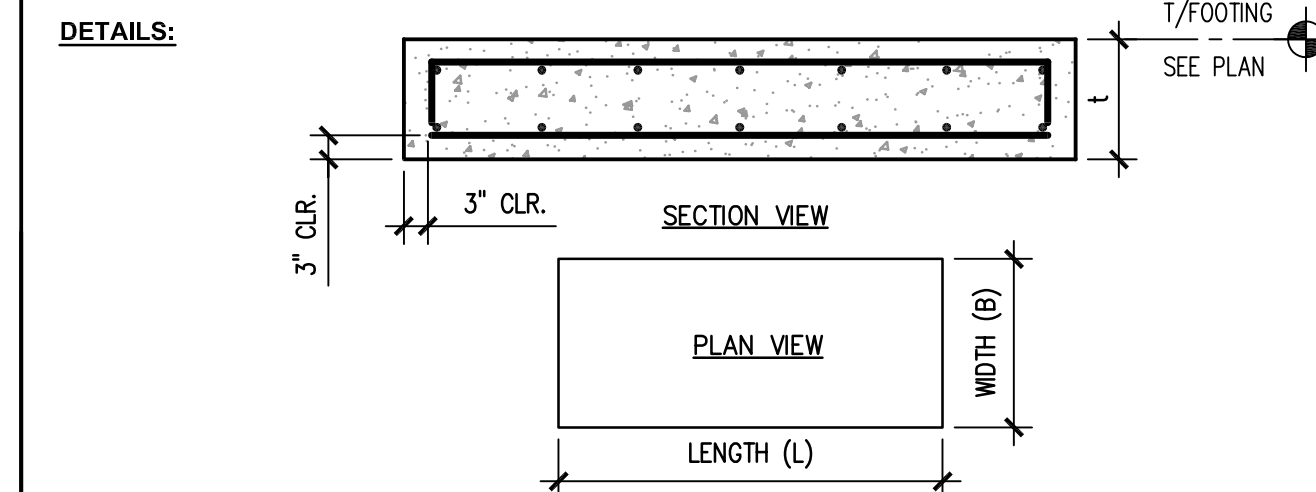


SLAB SCHEDULE AND NOTES


MARK	THICK (t)	CONCRETE STRENGTH (fc)	CONCRETE TYPE (NW or LW)	REINFORCING STEEL	GENERAL LOCATIONS	SPECIAL COMMENTS OR ADDITIONAL LOCATIONS
SLAB S1	5"	4,500 PSI	NW	NW-66 W2.W42.1	EXTERIOR SLAB ON GRADE	ALL EDGES TO BE THICKENED, SEE DETAIL 4/STH
SLAB S2	4"	4,000 PSI	NW	NW-66 W2.W42.1	TYP. INTERIOR SLAB ON GRADE	



NOTES:

1. SEE PROJECT SPECIFICATIONS FOR DETAILED MISC DESIGNS.
2. PREPARE ALL SLAB ON GRADE SUB-GRADINGS AS INDICATED ON SHEET S010.
3. ALL SLABS ON GRADE TO BE PLACED OVER 6" OF CLEAN, WELL GRADED GRANULAR MATERIALS AS INDICATED ON SHEET S010.
4. SEE MISC AND DETAILS FOR ALL LOCATIONS OF REINFORCING STEEL, CONTRACTION JOINTS, CONSTRUCTION JOINTS AND ISOLATION JOINTS.
5. ALL INTERIOR SLAB ON ISOLATION AREAS REQUIRE A 10 MIL. VAPOR BARRIER PLACED DIRECTLY OVER THE GRADE SUB-GRADING. SEE PROJECT SPECIFICATIONS FOR ADDITIONAL INFORMATION.
6. ALL WWF REINFORCING TO BE IN FLAT SHEETS ONLY. PLACEMENT (E.G. SUPPORT SPACING, LAP SPICE LENGTHS, ETC.) TO BE IN ACCORDANCE WITH THE STRUCTURAL WELDED WIRE REINFORCEMENT MANUAL OF THE STRUCTURAL STEEL INSTITUTE. SEE PROJECT SPECIFICATIONS FOR LATEST EDITION.
7. ALL REINFORCING STEEL TO BE SUPPORTED AS REQUIRED TO MAINTAIN THE DETAILED POSITIONS SHOWN ON THE CONTRACT DOCUMENTS DURING PLACEMENT OF THE CONCRETE.
8. ALL REINFORCING TO BE BARS OR WELDED WIRE REINFORCEMENT. ALL WWF SHALL BE ASTM A18, SMOOTH.
9. NORMAL WEIGHT CONCRETE (NW) SHALL HAVE A MAXIMUM DENSITY OF 145 PCF.
10. ALL CONCRETE TO HAVE 8% AIR ENTRAINMENT.
11. SEE CIVIL DRAWINGS FOR ALL SIDEWALKS.

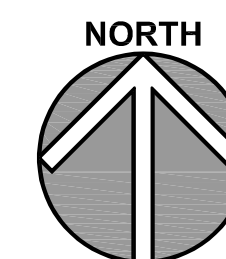


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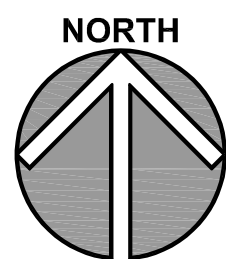


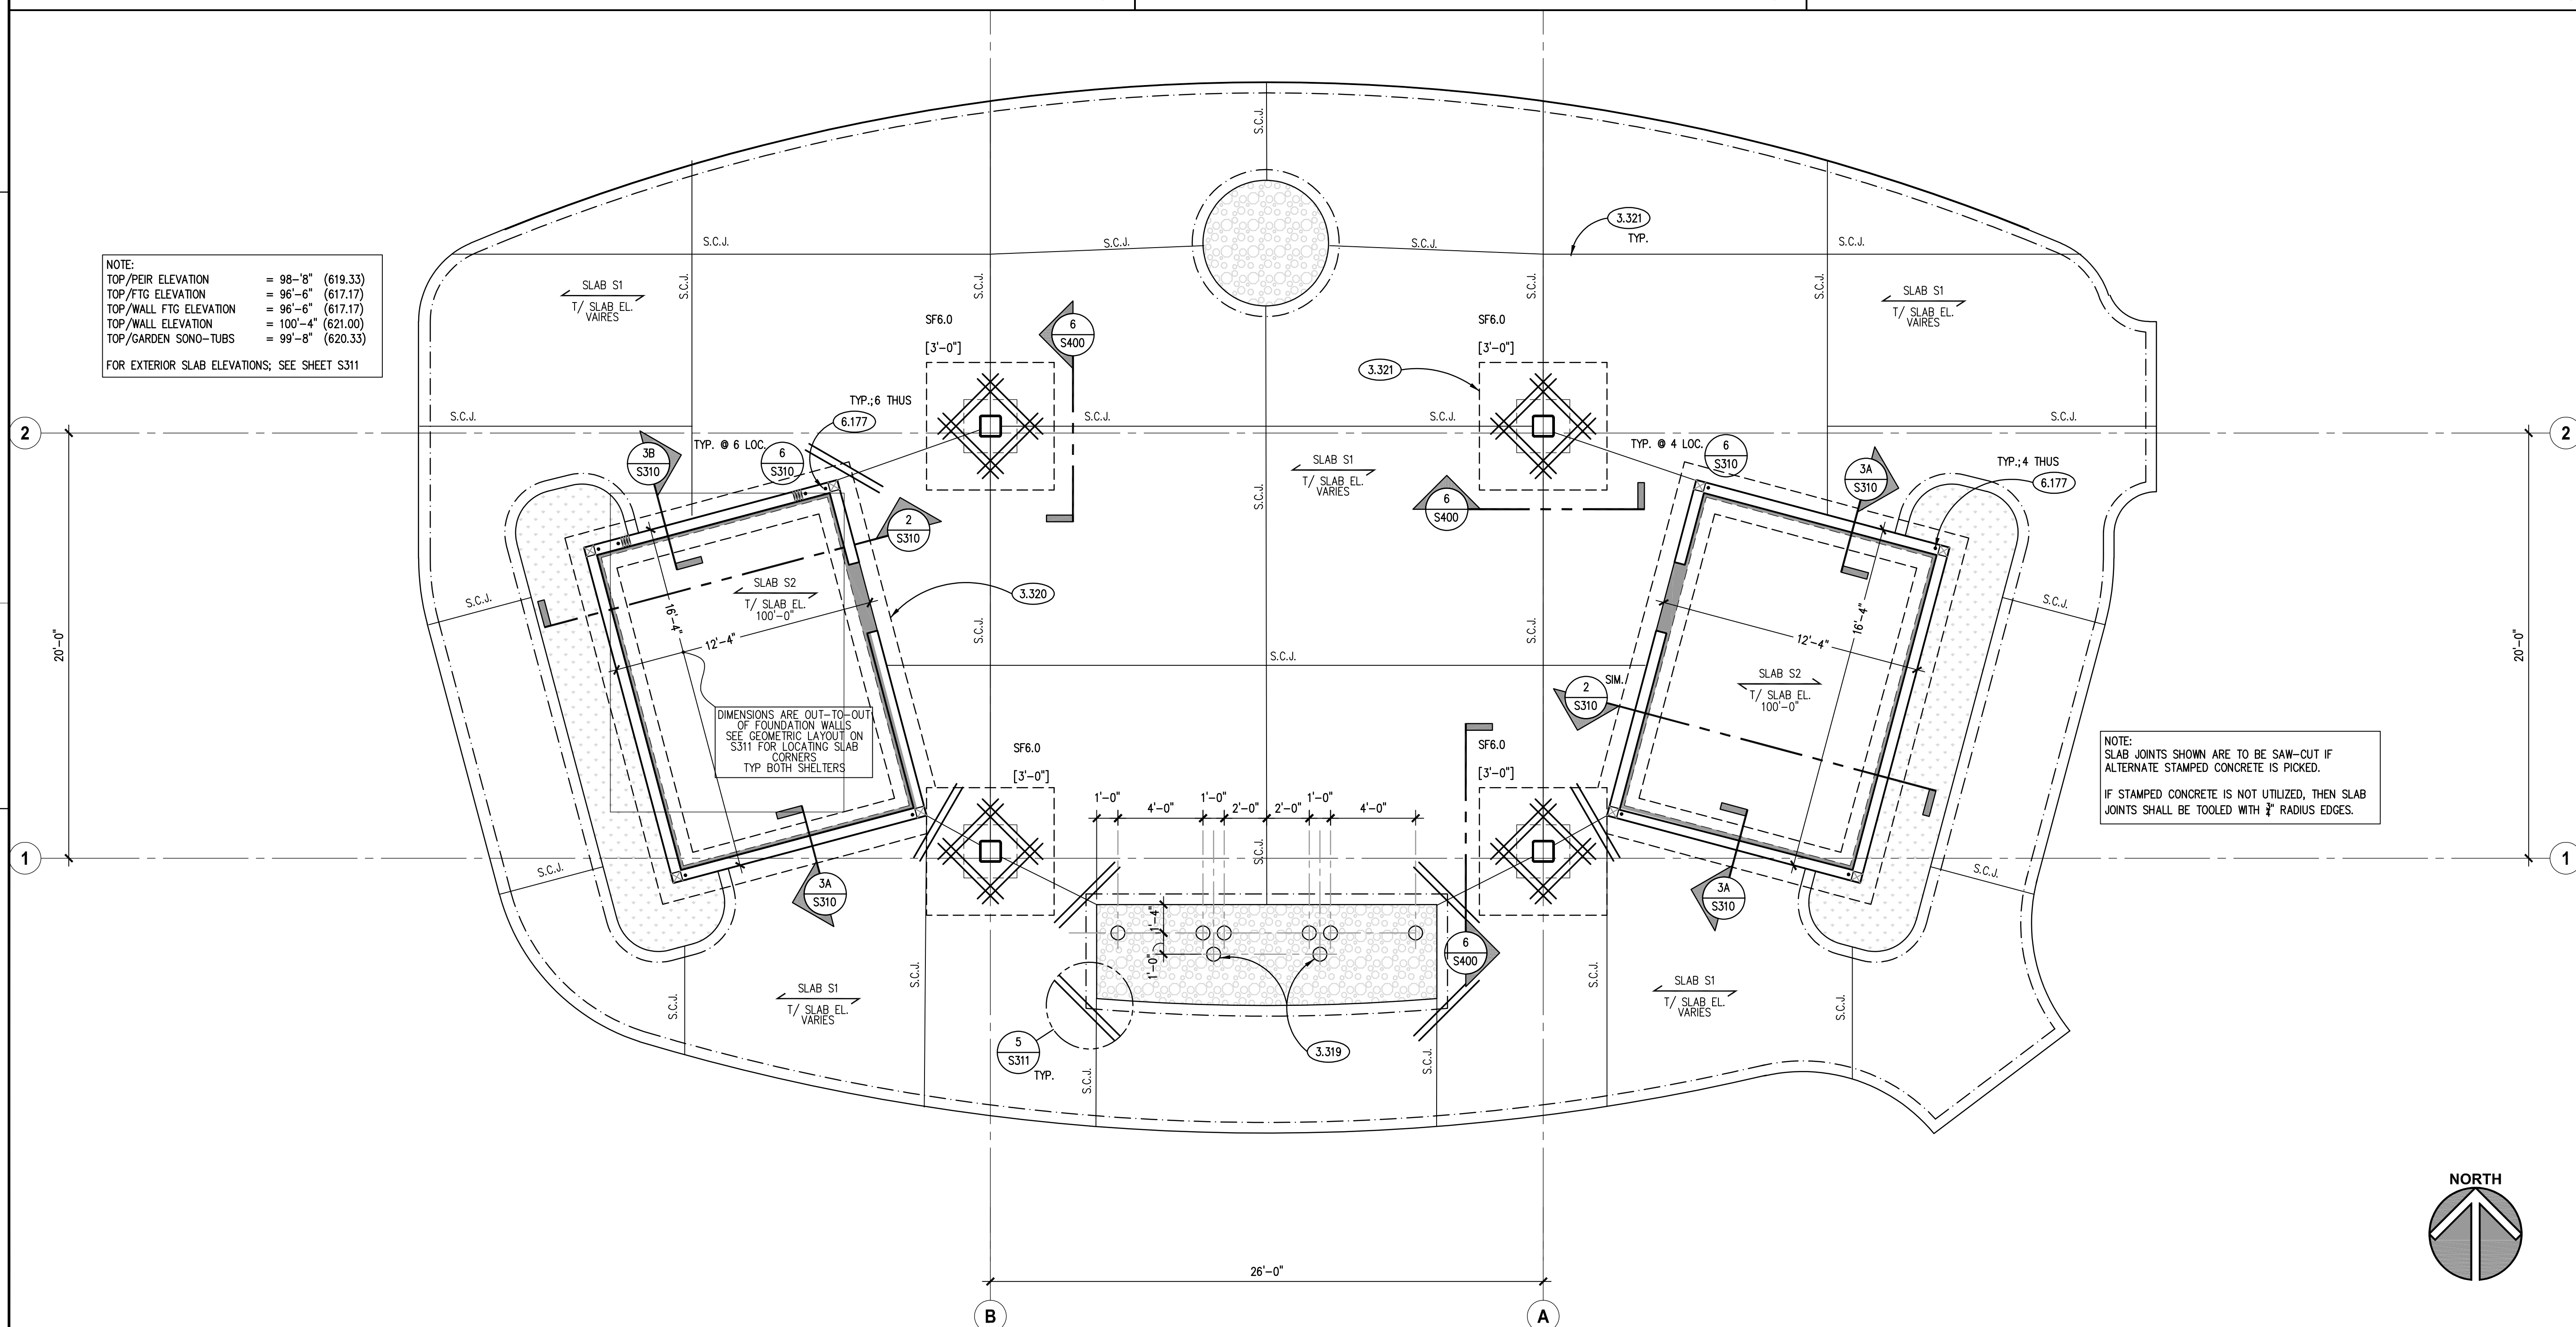TYPICAL SLAB JOINT DETAILS

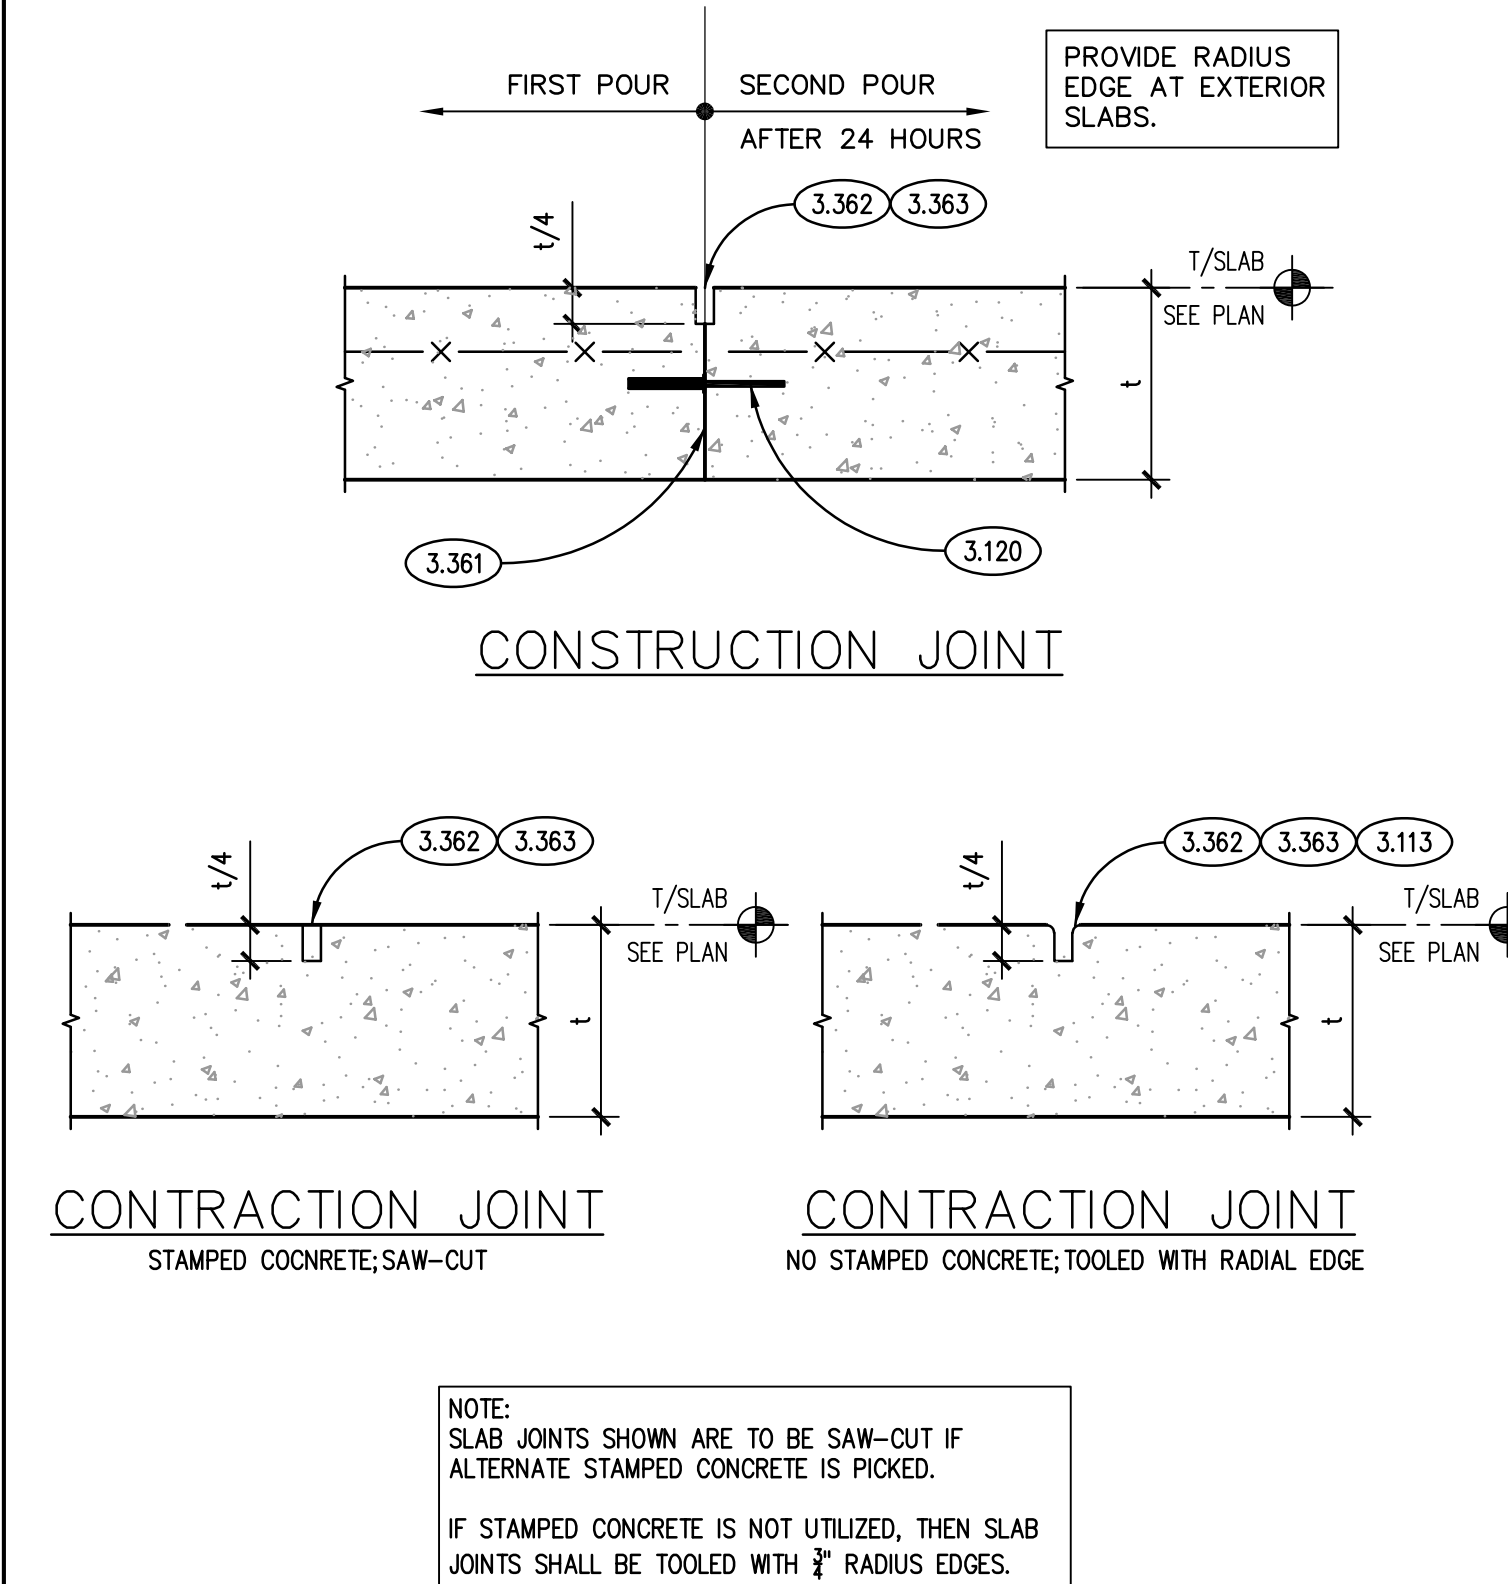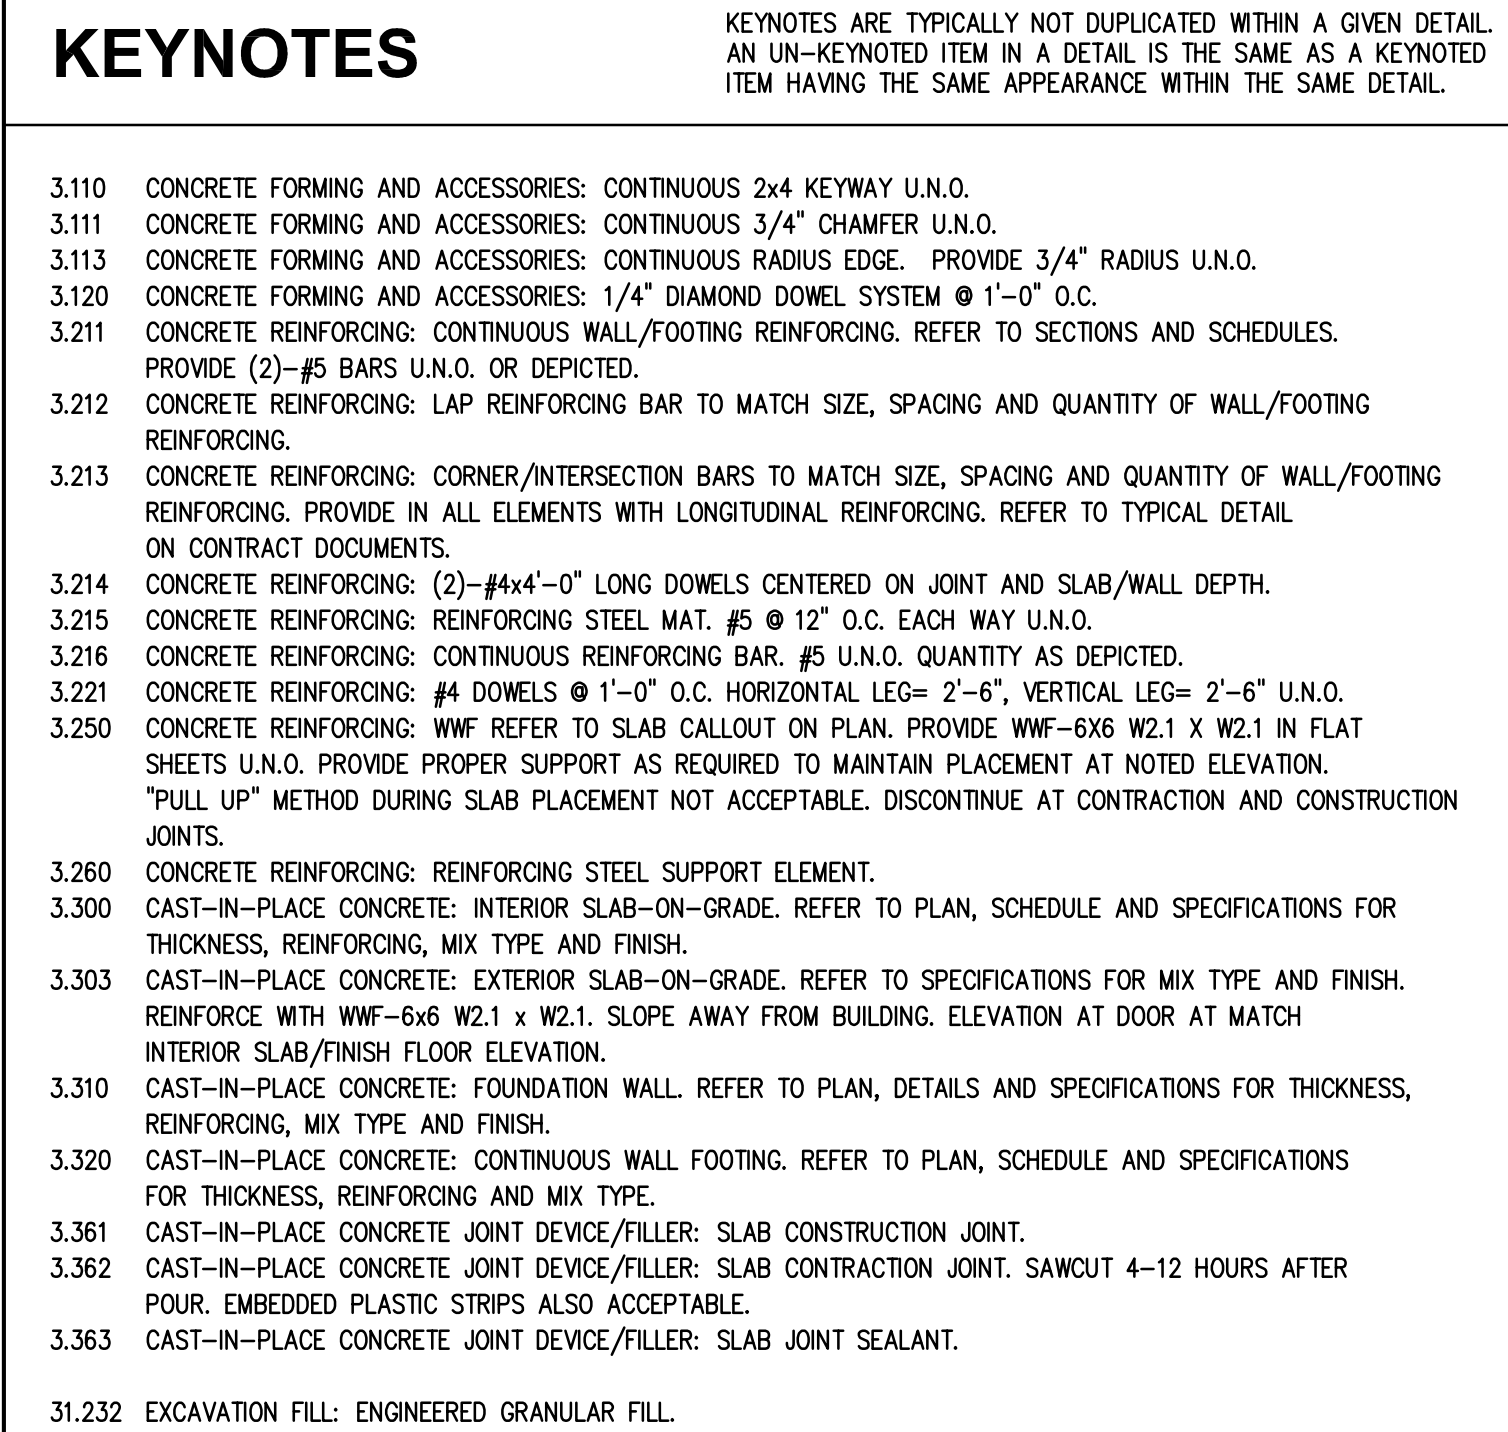SCALE: N.T.S.



TYP. CORNER/INTERSECTION BAR DETAILS 7
SCALE: N.T.S.

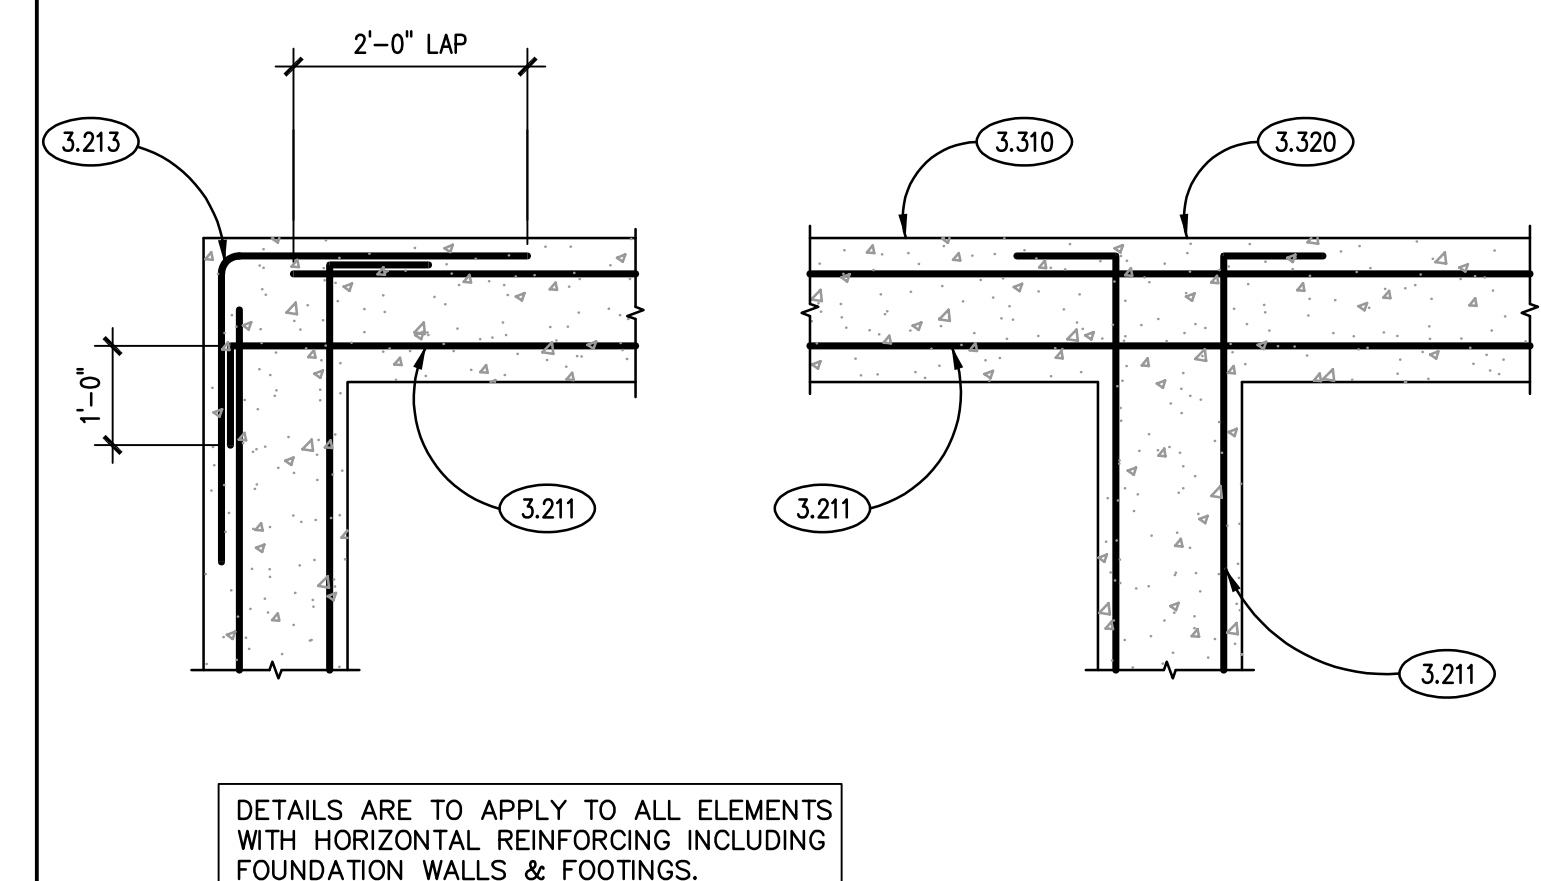

CANOPY FRAMING PLAN

SCALE: 1/4" = 1'-0"



SECTION 7
SCALE: 1" = 1'-0"




KEYNOTES

KEYNOTES ARE TYPICALLY NOT DUPLICATED WITHIN A GIVEN DETAIL. AN UN-KEYNOTED ITEM IN A DETAIL IS THE SAME AS A KEYNOTED ITEM HAVING THE SAME APPEARANCE WITHIN THE SAME DETAIL.

- 3.113 CONCRETE FORMING AND ACCESSORIES: CONTINUOUS RADIUS EDGE. PROVIDE 3/4" RADIUS U.N.O.
- 3.134 CAST-IN-PLACE CONCRETE: EXTERIOR SLAB-ON-GRADE. REFER TO SPECIFICATIONS FOR MIX TYPE AND FINISH. REFER TO PLAN & SCHEDULE FOR REINFORCING. REFER TO PLAN AND ARCHITECTURAL DRAWINGS FOR ELEVATIONS AND SLOPES.
- 3.319 CAST-IN-PLACE CONCRETE: 8"x4" x 4'-0" LONG SOUTHOE ANCHORAGE FORDATION; PROVIDE (4)-#4 BARS @ (2)-#1 CLOSURE LONG STRIPS AT TOP 4" OF PIER. COORDINATE WITH ARCHITECTURAL FABRICATION DETAILS FOR REQUIRED MATERIALS TO BE CAST INTO TOP OF PIERS
- 3.321 CAST-IN-PLACE CONCRETE: SPREAD FOOTING. REFER TO PLAN, SCHEDULE AND SPECIFICATIONS FOR THICKNESS, SIZE, REINFORCING AND MIX TYPE.
- 5.101 STRUCTURAL STEEL: STEEL COLUMN. REFER TO PLAN AND SCHEDULE.
- 5.122 STRUCTURAL STEEL: BASEPLATE & SETTING PLATE. REFER TO PLAN AND SCHEDULE.
- 5.715 METAL FABRICATION: DECORATIVE ART PANELS. SEE ARCHITECTURAL DRAWINGS FOR MORE INFORMATION FOR DISPLAY AND SUSPENSION SYSTEM.
- 5.717 METAL FABRICATION: 16" LONG STEEL BEAM SADDLE FABRICATED FROM COLUMN SECTION; PROVIDE THRU-BOLT HOLES AS DEPICTED AND FABRICATED TO TOP OF COLUMN VIA SHOP WELDING AS DEPICTED. ALL STEEL TO BE GALVANIZED.
- 6.101 WOOD FRAMING: BEAM/HEADER. SEE PLAN, SCHEDULE AND DETAILS FOR SIZE AND SPECIES. FIRE OUT SIDES TO MATCH WALL THICKNESS WHERE APPLICABLE.
- 6.106 WOOD FRAMING: ROOF JOIST. SEE PLAN, SCHEDULE AND DETAILS FOR SIZE, SPECIES AND SPACING.
- 6.111 WOOD FRAMING: CONTINUOUS PERMITER LSL PRESSURE TREATED RM BOARD (2 SIDES) TO MATCH DEPTH OF JOIST/BEAM. ATTACH TO JOIST/BEAM USING (2)-16d NAILS, GANTLET ENDS BEYOND LAST JOIST/BEAM AS REQUIRED TO SUPPORT SIDE RM BOARDS. INSIDE CORNERS OF FRONT LSL AND SIDE LSL TO HAVE (2) A35 FRAMING ANGLES AS MANUFACTURED BY SIMPSON OR EQUIVALENT BEAR SIDE LSL RM BOARD TO WOOD FRAMING. CONTRACTOR OPTION: IN LIEU OF LSL, PROVIDE (2)-2x8 PRESSURE TREATED ELEMENTS WITH (3)-16d Nails each 2x8 at EACH JOIST/BEAM.
- 6.115 WOOD FRAMING: APA RATED SHEATHING. SEE PLAN, SCHEDULE AND DETAILS FOR TYPE, THICKNESS AND ATTACHMENT REQUIREMENTS.
- 6.126 WOOD FRAMING: HEADER BEAM AS NOTED WITH JOIST HANGER EACH END.
- 6.158 WOOD FRAMING: CONTINUOUS BEVELLED TOP PLATE TO MATCH SLOPE OF ROOF.

- 6.168 WOOD FRAMING: PROVIDE SLOD 2X BLOCKING BETWEEN JOISTS; ATTACH USING (2)-16d NAILS @ EACH END.
- 6.176 WOOD FRAMING ACCESSORY: LIGHT GAUGE WOOD CONSTRUCTION CONNECTOR AS NOTED MANUFACTURED BY SIMPSON - STRONG-TIE OR EQUAL. INSTALL PER MANUFACTURER'S RECOMMENDATIONS. PROVIDE NAIL TYPE AND QUANTITIES RESULTING IN THE MAXIMUM FABRICATED CAPACITIES.
- 6.176 WOOD FRAMING ACCESSORY: SPECIALIZED SERIES WOOD CONSTRUCTION CONNECTOR AS NOTED MANUFACTURED BY SIMPSON OR EQUAL FOR THE LOADING AND MEMBER SIZES INDICATED. INSTALL PER MANUFACTURER'S RECOMMENDATIONS. REACTION FOR CONNECTOR DESIGN AS NOTED ON THE DRAWINGS. CONNECTION MANUFACTURER TO SUBMIT CALCULATIONS AND DETAILS TO STRUCTURAL ENGINEER FOR REVIEW.
- 6.176 WOOD FRAMING ACCESSORY: SPECIALIZED SERIES OF PROFESSIONAL ENGINEER PROVIDING THE CONNECTION.
- 6.176 WOOD FRAMING ACCESSORY: FASTER AS NOTED.
- 6.206 WOOD FRAMING: JOIST REINFORCEMENT: 12"x14230 JOIST REINFORCED WITH ADDITIONAL (2)-2x10'S (N/S/PS); WILL AS REQUIRED TO FIT BETWEEN JOIST CHORDS AND FASTEN TOGETHER WITH 16d NAILS @ 12" O.C. 16d.
- 6.207 WOOD FRAMING: JOIST REINFORCEMENT; PROVIDE BLOCKING/SHEATHING REINFORCEMENT IN ACCORDANCE WITH JOIST MANUFACTURER'S RECOMMENDATIONS FOR INSTALLATION OF LIGHT GAUGE HANGER.

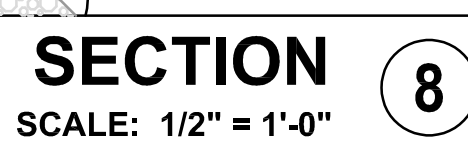

ISSUED	OWNER REVIEW	BID DOCUMENTS
04/10/24		
04/11/24		

JOB NO.	23-429-149
DRAWN	KS
CHECKED	JM
APPROVED	JM

ROOF FRAMING PLANS SECTIONS AND DETAILS

SHEET NUMBER

S320

